

Brownfield Cleanup Program Application

Broadway Triangle Site A
Block 2272 Lots 49, 51, 52, 53, 108
663 to 667 Flushing Avenue
and
Block 2269 Lot 52
29-31 Bartlett Street
Brooklyn, New York 11206

August 3, 2021

Prepared for:

Bartlett Crossing LLC
Bartlett Crossing Managers LLC
Bartlett Crossing UNP LLC
2 Kingsland Avenue
Brooklyn, New York 11211

Prepared by:

Roux Environmental Engineering and Geology, D.P.C. 209 Shafter Street Islandia, New York 11749



BROWNFIELD CLEANUP PROGRAM (BCP) APPLICATION FORM

DEC requires an application to request major changes to the description of the property set forth in a Brownfield Cleanup Agreement, or "BCA" (e.g., adding a significant amount of new property, or adding property that could affect an eligibility determination due to contamination levels or intended land use). Such application must be submitted and processed in the same manner as the original application, including the required public comment period. Is this an application to amend an existing BCA?			
Yes No If yes, provide existing site n	•		
PART A (note: application is separated into Parts A and B for DEC revi			
Section I. Requestor Information - See Instructions for Further Guid	DEC USE ONLY BCP SITE #:		
NAME Bartlett Crossing LLC, Bartlett Crossing Managers LLC,	, Bartlett Crossing UNP LLC		
ADDRESS 2 Kingsland Avenue			
CITY/TOWN Brooklyn ZIP CODE 1	1211		
PHONE 718-388-5454 x 170 FAX	E-MAIL cstewart@stnicksalliance.org		
 Is the requestor authorized to conduct business in New York State (NYS)? ✓ Yes No If the requestor is a Corporation, LLC, LLP or other entity requiring authorization from the NYS Department of State to conduct business in NYS, the requestor's name must appear, exactly as given above, in the NYS Department of State's Corporation & Business Entity Database. A print-out of entity information from the database must be submitted to the New York State Department of Environmental Conservation (DEC) with the application to document that the requestor is authorized to do business in NYS. Please note: If the requestor is an LLC, the members/owners names need to be provided on a separate attachment. Appendix A Do all individuals that will be certifying documents meet the requirements detailed below? ✓ Yes No Individuals that will be certifying BCP documents, as well as their employers, meet the requirements of Section 1.5 of DER-10: Technical Guidance for Site Investigation and Remediation and Article 145 of New York State Education Law. Documents that are not properly certified will be not approved under the BCP. 			
Section II. Project Description Appendix B			
1. What stage is the project starting at? Investigation	Remediation		
NOTE: If the project is proposed to start at the remediation stage, a R at a minimum is required to be attached, resulting in a 30-day public of Analysis and Remedial Work Plan are also attached (see DER-10 / To Investigation and Remediation for further guidance) then a 45-day public to the start of the project is proposed to start at the remediation stage, a R	comment period. If an Alternatives echnical Guidance for Site		
2. If a final RIR is included, please verify it meets the requirements of Er	nvironmental Conservation Law		
(ECL) Article 27-1415(2): Yes No Not Applicable			
3. Please attach a short description of the overall development project, including:			
the date that the remedial program is to start; and			
the date the Certificate of Completion is anticipated.			

Section III. Property's Environmental History Appendix C			
All applications must include an Investigation Report (per ECL 27-1407(1)). The report must be sufficient to establish that the site requires remediation and contamination of environmental media on the site above applicable Standards, Criteria and Guidance (SCGs) based on the reasonably anticipated use of the property. To the extent that existing information/studies/reports are available to the requestor, please attach the following (<i>please submit the information requested in this section in electronic format only</i>): 1. Reports: an example of an Investigation Report is a Phase II Environmental Site Assessment report prepared in accordance with the latest American Society for Testing and Materials standard (ASTM E1903). Please submit a separate electronic copy of each report in Portable Document Format			
2. SAMPLING DATA: INDIC		ANTS AND THE MEDIA WHICH D BE REFERENCED AND COPI	
Contaminant Category	Soil	Groundwater	Soil Gas
Petroleum			
Chlorinated Solvents			X
Other VOCs			X
SVOCs	X		
Metals	X	X	
Pesticides			
PCBs			
Other*			
*Please describe:			
3. FOR EACH IMPACTED MEDIUM INDICATED ABOVE, INCLUDE A SITE DRAWING INDICATING:			
 SAMPLE LOCATION DATE OF SAMPLING EVENT KEY CONTAMINANTS AND CONCENTRATION DETECTED FOR SOIL, HIGHLIGHT IF ABOVE REASONABLY ANTICIPATED USE FOR GROUNDWATER, HIGHLIGHT EXCEEDANCES OF 6NYCRR PART 703.5 FOR SOIL GAS/ SOIL VAPOR/ INDOOR AIR, HIGHLIGHT IF ABOVE MITIGATE LEVELS ON THE NEW YORK STATE DEPARTMENT OF HEALTH MATRIX 			
THESE DRAWINGS ARE TO BE REPRESENTATIVE OF ALL DATA BEING RELIED UPON TO MAKE THE CASE THAT THE SITE IS IN NEED OF REMEDIATION UNDER THE BCP. DRAWINGS SHOULD NOT BE BIGGER THAN 11" X 17". THESE DRAWINGS SHOULD BE PREPARED IN ACCORDANCE WITH ANY GUIDANCE PROVIDED. ARE THE REQUIRED MAPS INCLUDED WITH THE APPLICATION?* (*answoring No will result in an incomplete application) Yes No			
(*answering No will result in an incomplete application) ✓ Tes ☐ NO 4. INDICATE PAST LAND USES (CHECK ALL THAT APPLY):			
☐ Coal Gas Manufacturing☐ Salvage Yard☐ Landfill	Bulk Plant Pip	ricultural Co-op	Station
Other: Junk Shop, Carpenter, Sausage Factory, Bakery, Fur Dresser, Commercial, Residential			

Section IV. Property Information - See Instruction	s for Fu	rther Guida	nce Appe	ndix D	
PROPOSED SITE NAME Broadway Triangle Site	А				
ADDRESS/LOCATION 663 to 667 Flushing Aven	ue and	29 to 31 E	Bartlett Str	eet	
CITY/TOWN Brooklyn ZIP C	CODE 11	206			
MUNICIPALITY(IF MORE THAN ONE, LIST ALL): New	York Cit	ty			
COUNTY Kings	S	ITE SIZE (AC	RES) 0.33		
LATITUDE (degrees/minutes/seconds)	LONG	TUDE (degre	es/minutes/se	econds)	"
40 ° 42 ' 01.5 "	73	•	56		47.6
Complete tax map information for all tax parcels included proposed, please indicate as such by inserting "P/O" in finclude the acreage for that portion of the tax parcel in the PER THE APPLICATION INSTRUCTIONS. Site includes me	ront of the corresp	e lot number i onding far rig	in the approp	riate box belo	ow, and only
Parcel Address		Section No.	Block No.	Lot No.	Acreage
Site includes multiple lots, see Appendi	x D				
Do the proposed site boundaries correspond to ta If no, please attach an accurate map of the propse		etes and bo	unds?	✓Yes []No
2. Is the required property map attached to the application will not be processed without map)		e 2		√ Yes] No
3. Is the property within a designated Environmental Zone (En-zone) pursuant to Tax Law 21(b)(6)? (See DEC's website for more information) Yes ✓ No □					
If yes, identify census tract : 507					
Percentage of property in En-zone (check one):	0-49		50-99%	100%	1
4. Is this application one of multiple applications for a large development project, where the development project spans more than 25 acres (see additional criteria in BCP application instructions)? ☐ Yes ✓ No					
If yes, identify name of properties (and site number applications:	ers if ava	ilable) in rela	ated BCP		
5. Is the contamination from groundwater or soil vap subject to the present application?	or solely	emanating f	rom propert	y other than Ye	
6. Has the property previously been remediated purs ECL Article 56, or Article 12 of Navigation Law? If yes, attach relevant supporting documentation.	suant to ⁻	Γitles 9, 13, α	or 14 of ECL	Article 27, Type	
7. Are there any lands under water? If yes, these lands should be clearly delineated or	n the site	map.		☐ Ye	s 📝 No

Section IV. Property Information (continued)		
8. Are there any easements or existing rights of way that would preclude remediation in the If yes, identify here and attach appropriate information.	ese areas? Yes 🚺 No	
Easement/Right-of-way Holder Description	<u>on</u>	
9. List of Permits issued by the DEC or USEPA Relating to the Proposed Site (type here of information) None	or attach	
<u>Type</u> <u>Issuing Agency</u> <u>De</u>	<u>scription</u>	
10. Property Description and Environmental Assessment – please refer to application ins the proper format of <u>each</u> narrative requested. Appendix D	structions for	
Are the Property Description and Environmental Assessment narratives included in the prescribed format ?	√ Yes No	
Note: Questions 11 through 13 only pertain to sites located within the five counties comprising Ne	ew York City	
11. Is the requestor seeking a determination that the site is eligible for tangible property tax credits?	Yes No	
If yes, requestor must answer questions on the supplement at the end of this form.		
12. Is the Requestor now, or will the Requestor in the future, seek a determination that the property is Upside Down?	Yes √ No	
13. If you have answered <i>Yes</i> to Question 12, above, is an independent appraisal of the value of the property, as of the date of application, prepared under the hypothetical condition that the property is not contaminated, included with the application?	Yes No Not Applicable	
NOTE: If a tangible property tax credit determination is not being requested in the application to participate in the BCP, the applicant may seek this determination at any time before issuance of a certificate of completion by using the BCP Amendment Application, <u>except</u> for sites seeking eligibility under the underutilized category.		
If any changes to Section IV are required prior to application approval, a new page, initialed	by each requestor,	
must be submitted.		
Initials of each Requestor:		

BCP application - PART B (note:	application is	separated into Parts A	A and B for DEC review purposes)
Section V. Additional Requesto See Instructions for Further Gui		BCP SITE NAME: BCP SITE #	DEC USE ONLY #:
NAME OF REQUESTOR'S AUTHORIZED REPRESENTATIVE Charlie Stewart/St. Nicks Alliance			
ADDRESS 2 Kingsland Avenue			
CITY/TOWN Brooklyn			ZIP CODE 11211
PHONE 718-388-5454 x 170	FAX		E-MAIL cstewart@stnicksalliance.org
NAME OF REQUESTOR'S CONSUL	TANT Jessica L.	Taylor, P.G./Roux Environ	nmental Engineering and Geology, D.P.C.
ADDRESS 209 Shafter Street			
CITY/TOWN Islandia			ZIP CODE 11749
PHONE 631-630-2395	FAX		E-MAIL jtaylor@rouxinc.com
NAME OF REQUESTOR'S ATTORN	EY George C.	D. Duke, Esq., P.G.	BROWN DUKE & FOGEL, P.C.
ADDRESS 350 Fifth Ave, Suite	4640		
CITY/TOWN New York			ZIP CODE 10118
PHONE 201-915-0236	FAX 646-219-	-2601	E-MAIL gduke@bdflegal.com
Section VI. Current Property Ow	ner/Operator In	nformation – if not a R	Requestor Appendix E
CURRENT OWNER'S NAME New York	City Department of Hous	ing Preservation and Development	OWNERSHIP START DATE: varies
ADDRESS 100 Gold Street			
CITY/TOWN New York		ZIP CODE	10038
PHONE 212-863-8566	FAX		E-MAIL cortesf@hpd.nyc.gov
CURRENT OPERATOR'S NAME Fel	ipe Cortes/New \	ork City Department of I	Housing Preservation and Development
ADDRESS 100 Gold Street			
CITY/TOWN New York		ZIP CODE	10038
PHONE 212-863-8566	FAX		E-MAIL cortesf@hpd.nyc.gov
PROVIDE A LIST OF PREVIOUS PROPERTY OWNERS AND OPERATORS WITH NAMES, LAST KNOWN ADDRESSES AND TELEPHONE NUMBERS AS AN ATTACHMENT. DESCRIBE REQUESTOR'S RELATIONSHIP, TO EACH PREVIOUS OWNER AND OPERATOR, INCLUDING ANY RELATIONSHIP BETWEEN REQUESTOR'S CORPORATE MEMBERS AND PREVIOUS OWNER AND OPERATOR. IF NO RELATIONSHIP, PUT "NONE". IF REQUESTOR IS NOT THE CURRENT OWNER, DESCRIBE REQUESTOR'S RELATIONSHIP TO THE CURRENT OWNER, INCLUDING ANY RELATIONSHIP BETWEEN REQUESTOR'S CORPORATE MEMBERS AND THE CURRENT OWNER.			
Section VII. Requestor Eligibility	/ Information (P	Please refer to ECL § 2	27-1407) Appendix F
at the site? 3. Is the requestor subject to an o	ending against the xisting order for utstanding claim	ne requestor regarding the investigation, remo by the Spill Fund for the	this site? Yes V No val or remediation of contamination Yes V No

Section VII. Requestor Eligibility Information (continued)			
4.	Has the requestor been determined in an administrative, civil or criminal proceeding to be in violation of i) any provision of the ECL Article 27; ii) any order or determination; iii) any regulation implementing Title 14; or iv) any similar statute, regulation of the state or federal government? If so, provide an explanation on a congrete attachment		
5.	application, such as name, address, DEC assigned site number, the reason for denial, and other		
6.	relevant information. ☐ Yes ☑ No Has the requestor been found in a civil proceeding to have committed a negligent or intentionally tortious act involving the handling, storing, treating, disposing or transporting of contaminants? ☐ Yes ☑ No		
	Has the requestor been convicted of a criminal offer or transporting of contaminants; or ii) that involves a	violent felony, fraud, bribery, perjury, theft, or offense Article 195 of the Penal Law) under federal law or the	
9.	Has the requestor knowingly falsified statements or concealed material facts in any matter within the jurisdiction of DEC, or submitted a false statement or made use of or made a false statement in connection with any document or application submitted to DEC? ☐ Yes ✓ No ☐ Is the requestor an individual or entity of the type set forth in ECL 27-1407.9 (f) that committed an act or		
	failed to act, and such act or failure to act could be the basis for denial of a BCP application? Yes ✓ No 0. Was the requestor's participation in any remedial program under DEC's oversight terminated by DEC or by a court for failure to substantially comply with an agreement or order? Yes ✓ No		
11	Are there any unregistered bulk storage tanks on-si	te which require registration? ☐ Yes ✓No	
	IE REQUESTOR MUST CERTIFY THAT HE/SHE IS EITH TH ECL 27-1405 (1) BY CHECKING ONE OF THE BOXE	HER A PARTICIPANT OR VOLUNTEER IN ACCORDANCE S BELOW:	
the dis	PARTICIPANT requestor who either 1) was the owner of the site at the time of the disposal of hazardous waste or charge of petroleum or 2) is otherwise a person sponsible for the contamination, unless the liability	VOLUNTEER Appendix F A requestor other than a participant, including a requestor whose liability arises solely as a result of ownership, operation of or involvement with the site subsequent to the disposal of hazardous waste or discharge of petroleum.	
arises solely as a result of ownership, operation of, or involvement with the site subsequent to the disposal of hazardous waste or discharge of petroleum.		NOTE: By checking this box, a requestor whose liability arises solely as a result of ownership, operation of or involvement with the site certifies that he/she has exercised appropriate care with respect to the hazardous waste found at the facility by taking reasonable steps to: i) stop any continuing discharge; ii) prevent any threatened future release; iii) prevent or limit human, environmental, or natural resource exposure to any previously released hazardous	
		waste. If a requestor whose liability arises solely as a result of ownership, operation of or involvement with the site, submit a statement describing why you should be considered a volunteer – be specific as to the appropriate care taken.	

Se	Section VII. Requestor Eligibility Information (continued)			
	questor Relationship to Property (check one): Previous Owner Current Owner Potential /Future Purchaser Other			
be	equestor is not the current site owner, proof of site access sufficient to complete the remediation must submitted . Proof must show that the requestor will have access to the property before signing the BCA d throughout the BCP project, including the ability to place an easement on the site			
	Yes No Appendix F			
	te: a purchase contract does not suffice as proof of access.			
Se	ction VIII. Property Eligibility Information - See Instructions for Further Guidance			
	Is / was the property, or any portion of the property, listed on the National Priorities List? If yes, please provide relevant information as an attachment. ☐ Yes ✓ No			
2.	Is / was the property, or any portion of the property, listed on the NYS Registry of Inactive Hazardous Waste Disposal Sites pursuant to ECL 27-1305? If yes, please provide: Site # Class #			
3.	Is / was the property subject to a permit under ECL Article 27, Title 9, other than an Interim Status facility? If yes, please provide: Permit type: EPA ID Number: Permit expiration date:			
4.	If the answer to question 2 or 3 above is yes, is the site owned by a volunteer as defined under ECL 27-1405(1)(b), or under contract to be transferred to a volunteer? Attach any information available to the requestor related to previous owners or operators of the facility or property and their financial viability, including any bankruptcy filing and corporate dissolution documentation.			
5.	Is the property subject to a cleanup order under Navigation Law Article 12 or ECL Article 17 Title 10? If yes, please provide: Order # Yes ✓ No			
6.	Is the property subject to a state or federal enforcement action related to hazardous waste or petroleum? If yes, please provide explanation as an attachment. ☐ Yes ✓ No			
Section IX. Contact List Information Appendix G				
DE	be considered complete, the application must include the Brownfield Site Contact List in accordance with ER-23 / Citizen Participation Handbook for Remedial Programs. Please attach, at a minimum, the names d addresses of the following: The chief executive officer and planning board chairperson of each county, city, town and village in which the property is located.			
5.	Local news media from which the community typically obtains information. The public water supplier which services the area in which the property is located. Any person who has requested to be placed on the contact list. The administrator of any school or day care facility located on or near the property.			

Section X. Land Use Factors Appendix H	
1. What is the current municipal zoning designation for the site? What uses are allowed by the current zoning? (Check boxes, below) ✓ Residential ✓ Commercial Industrial If zoning change is imminent, please provide documentation from the appropriate zoning and appropriate zoning appropriate zo	uthority.
2. Current Use: ☐ Residential ☐ Commercial ☐ Industrial ✓ Vacant ☐ Recreational (checapply) Attach a summary of current business operations or uses, with an emphasis on identity possible contaminant source areas. If operations or uses have ceased, provide the design of the contaminant source areas.	ntifying
3. Reasonably anticipated use Post Remediation: ✓ Residential ✓ Commercial ☐ Industria that apply) Attach a statement detailing the specific proposed use.	I (check all
If residential, does it qualify as single family housing?	_Yes ✓ No
4. Do current historical and/or recent development patterns support the proposed use?	✓ Yes No
See attached Appendix H.	
 Is the proposed use consistent with applicable zoning laws/maps? Briefly explain below, or attach additional information and documentation if necessary. See attached Appendix H. 	√ Yes No
6. Is the proposed use consistent with applicable comprehensive community master plans, local waterfront revitalization plans, or other adopted land use plans? Briefly explain below, or attach additional information and documentation if necessary.	✓ Yes No
See attached Appendix H.	

(By requestor who is an individual) If this application is approved, I hererby acknowledge and agree: (1) to execute a Brownfield Cleanup Agreement (BCA) within 60 days of the date of DEC's approval letter; (2) to the general terms and conditions set forth in the DER-32, Brownfield Cleanup Program Applications and Agreements; and (3) that in the event of a conflict between the general terms and conditions of participation and the terms contained in a site-specific BCA, the terms in the site-specific BCA shall control. Further, I hereby affirm that information provided on this form and its attachments is true and complete to the best of my knowledge and belief. I am aware that any false statement made herein is punishable as a Class A misdemeanor pursuant to section 210.45 of the Penal Law. Date: Signature: Signature: Signature: Signature: Print Name: (By a requestor other than an individual) I hereby affirm that I am Authorized Signatory (title) of Bartlett Crossing UNP LLC (entity); that I am authorized by that entity to make this application and execute the Brownfield Cleanup Agreement (BCA) and all subsequent amendments; that this application was prepared by me or under my supervision and direction. If this application is approved, I acknowledge and agree: (1) to execute a BCA within 60 days of the date of DEC's approval letter; (2) to the general terms and conditions set forth in the DER-32, Brownfield Cleanup Program Applications and Agreements; and (3) that in the event of a conflict between the general terms and conditions of participation and the terms contained in a site-specific BCA, the terms in the site-specific BCA shall control. Further, I hereby affirm that information provided on this form and its attachments is true and complete to the best of my knowledge and belief. I am aware that any false statement made herein is punishable as a Class A misdemeanor pursuant to Section 210.45 of the Penal Law. Date: Signature: Signature: Signature: Prank Lang SUBMITTAL INFORMATION: Two (2) copies, on	XI. Statement of Certification and Signatures
If this application is approved, I hererby acknowledge and agree: (1) to execute a Brownfield Cleanup Agreement (BCA) within 60 days of the date of DEC's approval letter; (2) to the general terms and conditions set forth in the DER-32, Brownfield Cleanup Program Applications and Agreements; and (3) that in the event of a conflict between the general terms and conditions of participation and the terms contained in a site-specific BCA, the terms in the site-specific BCA shall control. Further, I hereby affirm that information provided on this form and its attachments is true and complete to the best of my knowledge and belief. I am aware that any false statement made herein is punishable as a Class A misdemeanor pursuant to section 210.45 of the Penal Law. Date: Signature: Signature: Print Name: [By a requestor other than an individual) I hereby affirm that I am Authorized Signatory (title) of Bartlett Crossing UNP LLC (entity); that I am authorized by that entity to make this application and execute the Brownfield Cleanup Agreement (BCA) and all subsequent amendments; that this application was prepared by me or under my supervision and direction. If this application is approved, I acknowledge and agree: (1) to execute a BCA within 60 days of the date of DEC's approval letter; (2) to the general terms and conditions set forth in the DER-32, Brownfield Cleanup Program Applications and Agreements; and (3) that in the event of a conflict between the general terms and conditions of participation and the terms contained in a site-specific BCA, the terms in the site-specific BCA shall control. Further, I hereby affirm that information provided on this form and its attachments is true and complete to the best of my knowledge and belief. I am aware that any false statement made herein is punishable as a Class A misdemeanor pursuant to Section 210.45 of the Penal Law. Date: Signature: Signature: Print Name: Frank Lang SUBMITTAL INFORMATION: Two (2) copies, one paper copy of the application form with original signatu	
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FOR DEC USE ONLY BCP SITE T&A CODE: LEAD OFFICE:	Two (2) copies, one paper copy of the application form with original signatures and table of contents, and one complete electronic copy in final, non-fillable Portable Document Format (PDF), must be sent to: Chief, Site Control Section New York State Department of Environmental Conservation Division of Environmental Remediation Bivision of Environmental Remediation Reme

XI. Statement of Certification and Signatures
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Date: Signature:
Print Name:
(By a requestor other than an individual)
I hereby affirm that I am Authorized Signatory (title) of Bartlett Crossing Managers LLC (entity); that I am authorized by that entity to make this application and execute the Brownfield Cleanup Agreement (BCA) and all subsequent amendments; that this application was prepared by me or under my supervision and direction. If this application is approved, I acknowledge and agree: (1) to execute a BCA within 60 days of the date of DEC's approval letter; (2) to the general terms and conditions set forth in the DER-32, Brownfield Cleanup Program Applications and Agreements; and (3) that in the event of a conflict between the general terms and conditions of participation and the terms contained in a site-specific BCA, the terms in the site-specific BCA shall control. Further, I hereby affirm that information provided on this form and its attachments is true and complete to the best of my knowledge and belief. I am aware that any false statement made herein is punishable as a Class A misdemeanor pursuant to Section 210.45 of the Penal Law. Date: Signature: Frank Lang
SUBMITTAL INFORMATION: • Two (2) copies, one paper copy of the application form with original signatures and table of
contents, and one complete electronic copy in final, non-fillable Portable Document Format (PDF), must be sent to:
 Chief, Site Control Section New York State Department of Environmental Conservation Division of Environmental Remediation 625 Broadway Albany, NY 12233-7020
PLEASE DO NOT SUBMIT PAPER COPIES OF SUPPORTING DOCUMENTS. Please provide a hard copy of ONLY the application form and a table of contents.
FOR DEC USE ONLY BCP SITE T&A CODE: LEAD OFFICE:
9

XI. Statement of Certification and Signatures	
(By requestor who is an individual)	
in the event of a conflict between the general terms in a site-specific BCA, the terms in the site-specific E information provided on this form and its attachment	C's approval letter; (2) to the general terms and aup Program Applications and Agreements; and (3) that and conditions of participation and the terms contained
Date: Signature:	
Print Name:	
(By a requestor other than an individual)	
all subsequent amendments; that this application was direction. If this application is approved, I acknowled the date of DEC's approval letter; (2) to the general DER-32, Brownfield Cleanup Program Applications between the general terms and conditions of participating the terms in the site-specific BCA shall control. Furthform and its attachments is true and complete to the	d execute the Brownfield Cleanup Agreement (BCA) and as prepared by me or under my supervision and dge and agree: (1) to execute a BCA within 60 days of terms and conditions set forth in the and Agreements; and (3) that in the event of a conflict pation and the terms contained in a site-specific BCA, her, I hereby affirm that information provided on this a best of my knowledge and belief. I am aware that any as A misdemeanor pursuant to Section 210.45 of the
	ation form with original signatures and table of n final, non-fillable Portable Document Format
 Chief, Site Control Section New York State Department of Enviror Division of Environmental Remediation 625 Broadway Albany, NY 12233-7020 	nmental Conservation 1
PLEASE DO NOT SUBMIT PAPER COPIES OF SU of ONLY the application form and a table of contents	JPPORTING DOCUMENTS. Please provide a hard copy is.
FOR DEC USE ONLY BCP SITE T&A CODE:	LEAD OFFICE:
BOF SHE TWA CODE.	
	9

Supplemental Questions for Sites Seeking Tangible Property Credits in New York City ONLY. Sufficient information to demonstrate that the site meets one or more of the criteria identified in ECL 27 1407(1-a) must be submitted if requestor is seeking this determination.

BCP	App	Rev	11
------------	-----	-----	----

BCF APP Nev 11		
Property is in Bronx, Kings, New York, Queens, or Richmond counties.		✓ Yes No
Requestor seeks a determination that the site is eligible for the tangible brownfield redevelopment tax credit.	e property credit co	omponent of the ✓ Yes No
Please answer questions below and provide documentation necess	ary to support an	swers.
Is at least 50% of the site area located within an environmental zone Please see DEC's website for more information.	pursuant to NYS 1	ax Law 21(b)(6)? ✓ Yes ☐ No
2. Is the property upside down or underutilized as defined below?	Upside Down?	☐ Yes 🗸 No
From ECL 27-1405(31):	Underutilized?	☐ Yes 🗸 No
"Upside down" shall mean a property where the projected and incurre remediation which is protective for the anticipated use of the property equipercent of its independent appraised value, as of the date of submission in the brownfield cleanup program, developed under the hypothetical concontaminated.	uals or exceeds sof the application	eventy-five for participation
From 6 NYCRR 375-3.2(I) as of August 12, 2016: (Please note: Eligib underutilized category can only be made at the time of application)	ility determination	for the
(I) "Underutilized" means, as of the date of application, real profifty percent of the permissible floor area of the building or buildings have been used under the applicable base zoning for at least three which zoning has been in effect for at least three years; and (1) the proposed use is at least 75 percent for industrial uses; or (2) at which: (i) the proposed use is at least 75 percent for commercial or commercial the proposed development could not take place without substancertified by the municipality in which the site is located; and (iii) one or more of the following conditions exists, as certified by the (a) property tax payments have been in arrears for at least five year application; (b) a building is presently condemned, or presently exhibits docume certified by a professional engineer, which present a public health of (c) there are no structures. "Substantial government assistance" shall mean a substantial loan, land purchase cost exemption or waiver, or tax credit, or some common governmental entity.	ercial and industratial government as applicant: rs immediately prented structural dor safety hazard;	e applicant to e application, ial uses; assistance, as rior to the deficiencies, as or

Su	pplemental Questions for Sites Seeking Tangible Property Credits in New York City (continued)
3.	If you are seeking a formal determination as to whether your project is eligible for Tangible Property Tax Credits based in whole or in part on its status as an affordable housing project (defined below), you must attach the regulatory agreement with the appropriate housing agency (typically, these would be with the New York City Department of Housing, Preservation and Development, the New York State Housing Trust Fund Corporation; the New York State Department of Housing and Community Renewal; or the New York State Housing Finance Agency, though other entities may be acceptable pending Department review). Check appropriate box, below:
	☐ Project is an Affordable Housing Project - Regulatory Agreement Attached;
	Project is Planned as Affordable Housing, But Agreement is Not Yet Available* (*Checking this box will result in a "pending" status. The Regulatory Agreement will need to be provided to the Department and the Brownfield Cleanup Agreement will need to be amended prior to issuance of the CoC in order for a positive determination to be made.);
	☐ This is Not an Affordable Housing Project.
Fr	om 6 NYCRR 375- 3.2(a) as of August 12, 2016:
se tha	"Affordable housing project" means, for purposes of this part, title fourteen of article twenty ven of the environmental conservation law and section twenty-one of the tax law only, a project at is developed for residential use or mixed residential use that must include affordable sidential rental units and/or affordable home ownership units.
reg rer	(1) Affordable residential rental projects under this subdivision must be subject to a federal, ate, or local government housing agency's affordable housing program, or a local government's gulatory agreement or legally binding restriction, which defines (i) a percentage of the residential intal units in the affordable housing project to be dedicated to (ii) tenants at a defined maximum recentage of the area median income based on the occupants' households annual gross income.
re	(2) Affordable home ownership projects under this subdivision must be subject to a federal, ate, or local government housing agency's affordable housing program, or a local government's gulatory agreement or legally binding restriction, which sets affordable units aside for home where at a defined maximum percentage of the area median income.
sta	(3) "Area median income" means, for purposes of this subdivision, the area median income the primary metropolitan statistical area, or for the county if located outside a metropolitan tistical area, as determined by the United States department of housing and urban velopment, or its successor, for a family of four, as adjusted for family size


BCP Application Summary (for DEC use	only)	
Site Name: Broadway Triangle Site A City: Brooklyn	Site Address: 663 to 667 Flushing Avenue and 29 to 31 Bartlett Street County: Kings Zip: 11206	et
Tax Block & Lot Section (if applicable): Blo	ock: Lot:	
Requestor Name: Bartlett Crossing LLC, Bartlett Crossing Manager City: Brooklyn	Requestor Address: 2 Kingsland Avenue Zip: 11211 Email: cstewart@stnicksallia	
Requestor's Representative (for billing pame: Charlie Stewart/St. Nicks Alliance Add City: Brooklyn		e.org
Requestor's Attorney Name: George C. D. Duke, Esq., P.G./BROWN DUKE & FOGEL, P.C. Add City: New York	Iress: 350 Fifth Ave, Suite 4640 Zip: 10118 Email: gduke@bdflega	al.com
Requestor's Consultant Name: Jessica L. Taylor, P.G./Roux Environmental Engineering and Geology, D.P.C. Add City: Islandia Percentage claimed within an En-Zone: DER Determination: Agree	Iress: 209 Shafter Street Zip: 11749 Email: jtaylor@rouxin 0% 50-99% ☐ 100% ☐ Disagree	.c.com
Requestor's Requested Status: 🗸 Vol	unteer	
DER/OGC Determination: Agree Notes:	Disagree	
For NYC Sites, is the Requestor See	king Tangible Property Credits: ✓ Yes ☐ No	
Does Requestor Claim Property is UDER/OGC Determination: Agree Notes:		
Does Requestor Claim Property is UDER/OGC Determination: Agree Notes:	<u> </u>	
Does Requestor Claim Affordable H DER/OGC Determination: Agree Notes:	ousing Status: Yes No Planned, No Cont Disagree Undetermined	ract


Brownfield Cleanup Program Application Broadway Triangle Site A


FIGURES


- 1. Site Location Map
- 2. Existing Conditions and Tax Map
- 3. Surrounding Land Use and Adjacent Property Owners
- 4. Soil Sample Locations and Exceedances
- 5. Groundwater Sample Locations and Exceedances
- 6. Soil Vapor Sample Locations and Detections

3605.0001Y108/CVRS ROUX

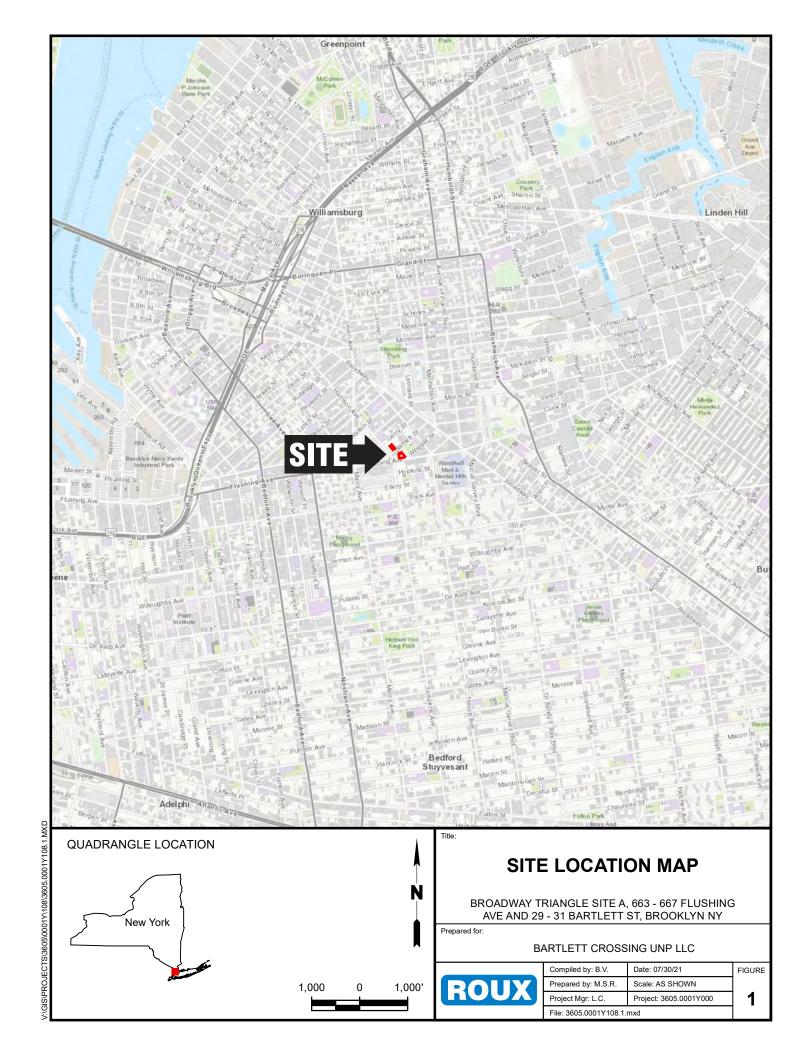

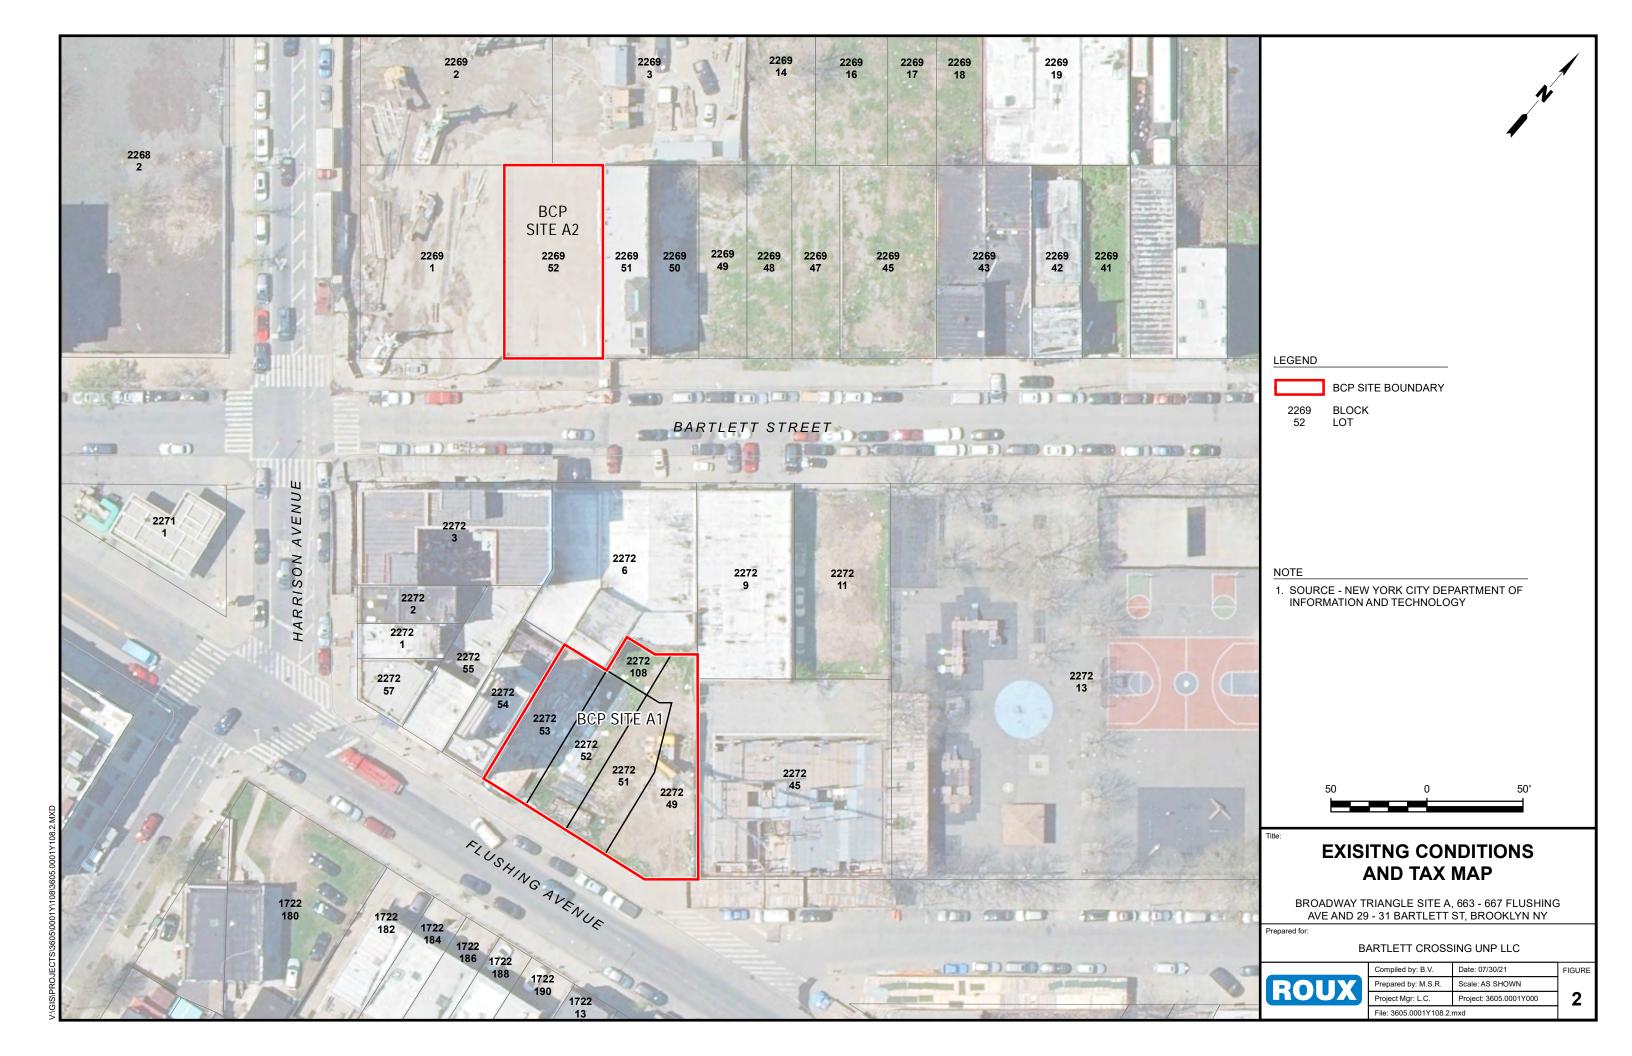

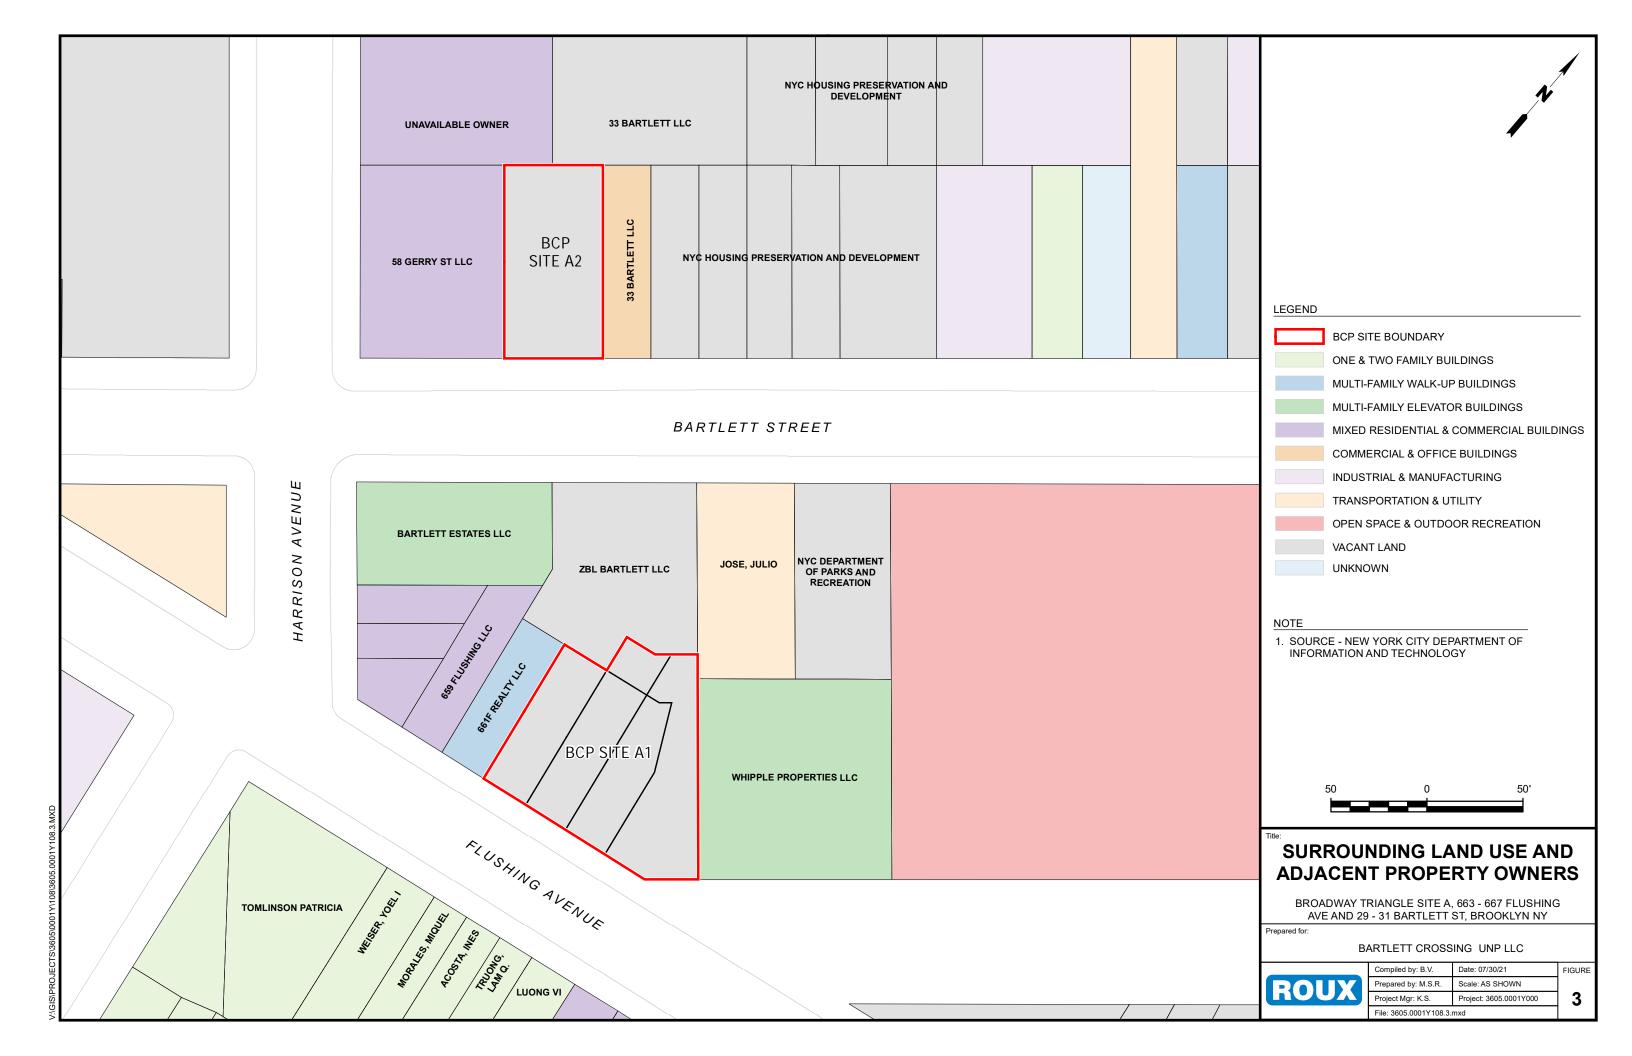

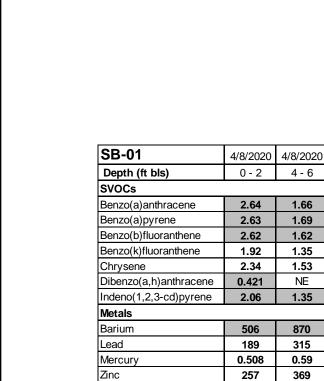

Pesticides

4,4'-DDD

4,4'-DDE

4,4'-DDT

SB-03	4/7/2020	4/7/2020
Depth (ft bls)	0 - 2	4 - 6
VOCs	-	
Acetone	NE	0.052
SVOCs		
Benzo(k)fluoranthene	0.827	0.824
Indeno(1,2,3-cd)pyrene	0.589	0.531
Metals		
Lead	473	NE
Mercury	0.762	NE
Zinc	192	250
Pesticides		
4,4'-DDD	0.00608	ND
4,4'-DDE	0.00909	ND
4.4'-DDT	0.0447	0.00376

1.69

1.53

NE


0.014 0.00843

0.0157 0.0125

0.135 0.0369

RXA-5201	12/14/2020	12/14/2020
Depth (ft bls)	0 - 2	0 - 2 FD
SVOCs		
Benzo(A)Anthracene	3.4	7.6
Benzo(A)Pyrene	4.3	8.8
Benzo(B)Fluoranthene	5.3	12
Benzo(K)Fluoranthene	2.1	4.4
Chrysene	3.3	8
Dibenz(A,H)Anthracene	0.81	1.7
Indeno(1,2,3-C,D)Pyrene	2.7	5.5
Metals		
Arsenic	24.3	18.7
Barium	807	1880
Chromium, Total	NE	75.5
Copper	69.4	160
Lead	880	2290
Mercury	0.87	1.3
Nickel	NE	95.8
Zinc	874	1240

SB-02	4/7/2020	4/7/2020
Depth (ft bls)	0 - 2	11 - 13
SVOCs		
Benzo(a)anthracene	1.32	ND
Benzo(a)pyrene	1.27	ND
Benzo(b)fluoranthene	1.2	ND
Benzo(k)fluoranthene	1.05	ND
Chrysene	1.19	ND
Indeno(1,2,3-cd)pyrene	0.663	ND
Metals		
Barium	1130	NE
Lead	93.9	NE
Zinc	678	NE
Pesticides		
4,4'-DDE	0.00551	ND
4,4'-DDT	0.0181	ND
PCBs	-	
Aroclor 1260	0.178	ND
Aroclor, Total	0.178	ND

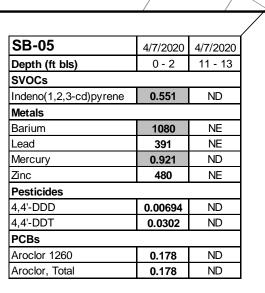

SB-01	4/7/2020	4/7/2020
Depth (ft bls)	0 - 2	11 - 13
SVOCs		
Benzo(a)anthracene	4.87	ND
Benzo(a)pyrene	4.17	ND
Benzo(b)fluoranthene	3.59	ND
Benzo(k)fluoranthene	2.64	ND
Chrysene	4.28	ND
Dibenzo(a,h)anthracene	0.766	ND
Indeno(1,2,3-cd)pyrene	1.84	ND
Metals		
Lead	202	NE
Mercury	0.204	ND
Zinc	178	NE
Pesticides		
4,4'-DDT	0.00498	ND

LOT 108

LOT 51

RXA-5101

LOT 49

SB-01/MW-03

SV-04

SB-06/MW-02

SB-03/MW-01 SB-04

LOT 52

SB-01

▲ SV-02

SB-02

\$B-03/MW-03

SV-03

LOT 52

BLOCK 2269

BARTLETT STREET

RXA-5101	12/14/2020
Depth (ft bls)	0 - 2
SVOCs	
Benzo(A)Anthracene	7
Benzo(A)Pyrene	7.6
Benzo(B)Fluoranthene	10
Benzo(K)Fluoranthene	3.2
Chrysene	6.8
Dibenz(A,H)Anthracene	1.4
Indeno(1,2,3-C,D)Pyrene	4.9
Metals	
Barium	726
Copper	52.3
Lead	578
Mercury	0.67
Zinc	543

BLOCK 2272

4/8/2020	
4/0/2020	4/8/2020
0 - 2	6 - 8
7.29	ND
5.80	ND
4.86	ND
4.05	ND
7.06	ND
1.3	ND
3.32	ND
1490	NE
54	NE
2050	NE
0.698	0.264
ND	4.46
549	NE
0.00732	ND
0.0184	ND
0.0704	ND
0.00545	ND
	7.29 5.80 4.86 4.05 7.06 1.3 3.32 1490 54 2050 0.698 ND 549 0.00732 0.0184 0.0704


SB-03	4/8/2020	4/8/2020
Depth (ft bls)	0 - 2	12 - 14
VOCs		
Acetone	0.097	0.24
SVOCs		
Benzo(a)anthracene	1.45	ND
Benzo(a)pyrene	1.35	ND
Benzo(b)fluoranthene	1.16	ND
Benzo(k)fluoranthene	1.06	ND
Chrysene	1.32	ND
Indeno(1,2,3-cd)pyrene	0.996	ND
Metals		
Lead	114	NE
Mercury	0.268	ND
Zinc	178	NE
Pesticides		
4,4'-DDD	0.00718	ND
4,4'-DDE	0.0381	ND
4,4'-DDT	0.0291	ND

	•	
SB-04	4/7/2020	4/7/2020
Depth (ft bls)	0 - 2	4 - 6
SVOCs		
Benzo(a)anthracene	6.56	ND
Benzo(a)pyrene	6.81	ND
Benzo(b)fluoranthene	6.15	ND
Benzo(k)fluoranthene	5.8	ND
Chrysene	6.27	ND
Dibenzo(a,h)anthracene	1.61	ND
Indeno(1,2,3-cd)pyrene	4.13	ND
Metals		
Barium	884	NE
Copper	74.3	79
Lead	396	266
Mercury	0.812	0.195
Zinc	671	280
Pesticides		
4,4'-DDD	0.0174	ND
4,4'-DDE	0.0383	ND
4,4'-DDT	0.237	ND
Dieldrin	0.298	ND
PCBs		
Aroclor 1260	0.151	ND
Aroclor, Total	0.151	ND

Depth (ft bls)	0 - 2	4 - 6
SVOCs		
Benzo(a)anthracene	9	NE
Benzo(a)pyrene	9.19	NE
Benzo(b)fluoranthene	8.76	NE
Benzo(k)fluoranthene	7.46	NE
Chrysene	8.62	NE
Dibenzo(a,h)anthracene	2.04	NE
Indeno(1,2,3-cd)pyrene	5.55	NE
Metals		
Barium	1660	NE
Copper	68	146
Lead	1810	583
Mercury	0.579	3.2
Zinc	972	745
Pesticides		
4,4'-DDD	0.0263	ND
4,4'-DDE	0.0548	ND
4,4'-DDT	0.301	ND
Dieldrin	0.0563	ND

4/7/2020 4/7/2020

SB-06

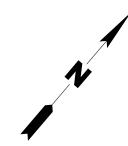

LEGEND

LOCATION OF ROUX SOIL BORING



LOCATION OF GALLAGHER BASSET TECHNICAL SERVICES SOIL BORING COLLECTED IN 2020



LOCATION OF GALLAGHER BASSET TECHNICAL SERVICES SOIL BORING AND GROUNDWATER SAMPLE COLLECTED IN 2020



SOIL VAPOR POINT COLLECTED IN 2020

BCP SITE BOUNDARY

10/0050	11/05505
	NYSDEC Part
375 UUSCOs	375 RRSCOs
0.05	100
	1
1	1
1	1
0.8	3.9
1	3.9
0.33	0.33
0.5	0.5
13	16
350	400
30	180
50	270
63	400
0.18	0.81
30	310
109	10000
0.0033	13
0.0033	8.9
0.0033	7.9
0.005	0.2
0.1	1
0.1	1
	0.8 1 0.33 0.5 13 350 30 50 63 0.18 30 109 0.0033 0.0033 0.0033 0.005

- 1. ALL CONCENTRATIONS SHOWN IN MILLIGRAMS PER KILOGRAM 2. BOLD DATA INDICATES AN EXCEEDANCE OF NYSDEC PART 375 UUSCO
- 3. SHADED DATA INDICATES AN EXCEEDANCE OF NYSDEC PART 375 RRSCO

FD - DUPLICATE SAMPLE

FT BLS - FEET BELOW LAND SURFACE

ND - NO DETECTION


NE - NO EXCEEDANCE

NYSDEC - NEW YORK STATE DEPARTMENT OF ENVIRONMENTAL CONSERVATION PCBS - POLYCHLORINATED BIPHENYLS

RRSCOS - RESTRICTED RESIDENTIAL SOIL CLEANUP OBJECTIVES

SVOCS - SEMIVOLATILE ORGANIC COMPOUNDS UUSCOS - UNRESTRICTED USE SOIL CLEANUP OBJECTIVES

VOCS - VOLATILE ORGANIC COMPOUNDS

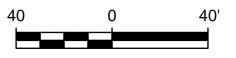

SOIL SAMPLE LOCATIONS AND EXCEEDANCES

BROADWAY TRIANGLE SITE A, 663 - 667 FLUSHING AVE AND 29 - 31 BARTLETT ST, BROOKLYN NY


BARTLETT CROSSING UNP LLC



Compiled by: B.V.	Date: 03/05/21	FIGURE
Prepared by: M.S.R.	Scale: AS SHOWN	4
Project Mgr: K.S.	Project: 3605.0001Y002	4
File: 3605.0001Y108.4.	mxd	





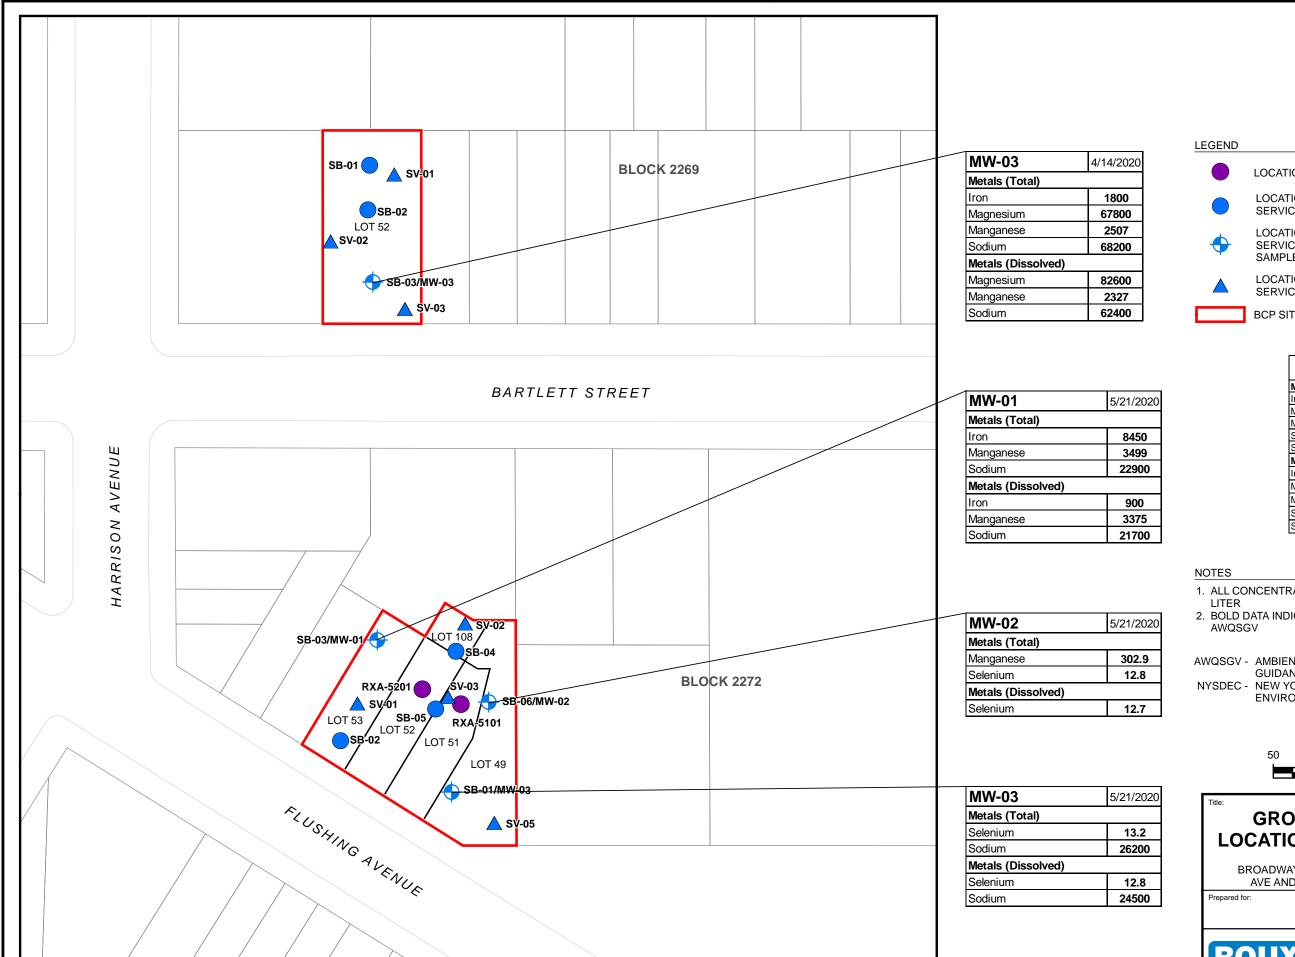

LOCATION OF ROUX SOIL BORING

LOCATION OF GALLAGHER BASSET TECHNICAL SERVICES SOIL BORING COLLECTED IN 2020

LOCATION OF GALLAGHER BASSET TECHNICAL SERVICES SOIL BORING AND GROUNDWATER SAMPLE COLLECTED IN 2020

LOCATION OF GALLAGHER BASSET TECHNICAL SERVICES SOIL VAPOR POINT COLLECTED IN 2020

BCP SITE BOUNDARY

Danamatan	NYSDEC
Parameter	AWQSGVs
Metals (Total)	
Iron	300
Magnesium	35000
Manganese	300
Selenium	10
Sodium	20000
Metals (Dissolved)	1
Iron	300
Magnesium	35000
Manganese	300
Selenium	10
Sodium	20000

- 1. ALL CONCENTRATIONS SHOWN IN MICROGRAMS PER
- 2. BOLD DATA INDICATES AN EXCEEDANCE OF NYSDEC

AWQSGV - AMBIENT WATER-QUALITY STANDARDS AND

GUIDANCE VALUES

NYSDEC - NEW YORK STATE DEPARTMENT OF **ENVIRONMENTAL CONSERVATION**




GROUNDWATER SAMPLE LOCATIONS AND EXCEEDANCES

BROADWAY TRIANGLE SITE A, 663 - 667 FLUSHING AVE AND 29 - 31 BARTLETT ST, BROOKLYN NY

BARTLETT CROSSING UNP LLC




Compiled by: B.V.	Date: 03/05/21	FIGURE
Prepared by: M.S.R.	Scale: AS SHOWN	
Project Mgr: L.C.	Project: 3605.0001Y002	5
File: 3605.0001Y108.5.	mxd	_

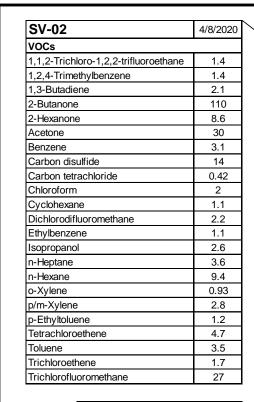


SV-02	4/7/2020
VOCs	
2-Butanone	21
Acetone	410
Isopropanol	18
Methyl Methacrylate	10
n-Heptane	3.4
n-Hexane	5.6
Styrene	4.3
Tetrachloroethene	11
Toluene	18

SV-01	4/7/2020
VOCs	
1,3-Butadiene	12
2-Butanone	34
4-Methyl-2-pentanone	6.5
Acetone	620
Benzene	4.1
Carbon disulfide	4
n-Hexane	4.5
Tetrachloroethene	21
Toluene	10
Trichlorofluoromethane	8.9

SV-04	4/7/2020
VOCs	
2-Butanone	29
Acetone	510
Benzene	6.2
Carbon disulfide	2.5
Dichlorodifluoromethane	14
Isopropanol	4.1
n-Heptane	220
n-Hexane	300
Tetrachloroethene	250
Toluene	3.5
Trichlorofluoromethane	500

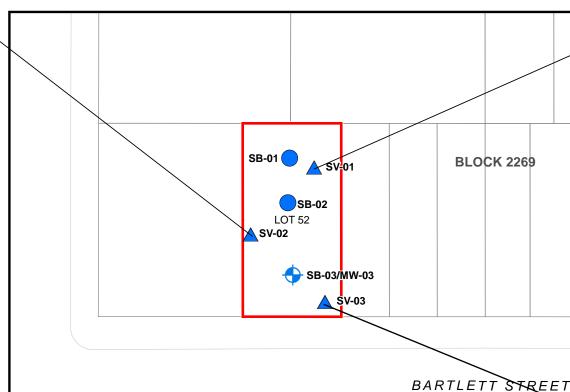

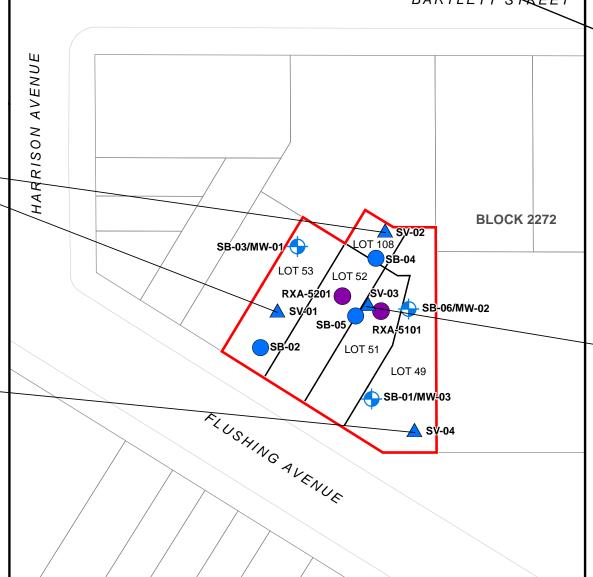

SV-01	4/8/2020
VOCs	
1,1,1-Trichloroethane	0.88
1,1,2-Trichloro-1,2,2-trifluoroethane	1.7
1,2,4-Trimethylbenzene	1.9
2-Butanone	92
2-Hexanone	8.5
4-Methyl-2-pentanone	0.66
Acetone	20
Benzene	1
Carbon disulfide	0.69
Chloroform	82
Dichlorodifluoromethane	2.6
Ethylbenzene	1.1
Isopropanol	13
Methyl Methacrylate	9.3
n-Hexane	0.83
o-Xylene	1.1
p/m-Xylene	3.6
p-Ethyltoluene	1.7
Tetrachloroethene	5
Toluene	4.4
Trichloroethene	0.24
Trichlorofluoromethane	57

SV-03	4/8/2020
VOCs	
1,2,4-Trimethylbenzene	1.5
2-Butanone	130
2-Hexanone	12
Acetone	22
Carbon tetrachloride	0.51
Dichlorodifluoromethane	2.3
Ethylbenzene	0.92
Isopropanol	3.3
Methyl Methacrylate	4.1
o-Xylene	0.85
p/m-Xylene	2.8
p-Ethyltoluene	1.4
Styrene	0.69
Toluene	2.1
Trichlorofluoromethane	2.6

SV-03	4/7/2020
VOCs	
2-Butanone	33
Acetone	630
Carbon disulfide	8
Dichlorodifluoromethane	4.1
Ethylbenzene	4
Isopropanol	20
Methyl Methacrylate	12
n-Hexane	2.9
Propylene	25
Toluene	3.1
Trichlorofluoromethane	9.3



LEGEND

LOCATION OF ROUX SOIL BORING



LOCATION OF GALLAGHER BASSET TECHNICAL SERVICES SOIL BORING COLLECTED IN 2020



LOCATION OF GALLAGHER BASSET TECHNICAL SERVICES SOIL BORING AND GROUNDWATER SAMPLE COLLECTED IN 2020



LOCATION OF GALLAGHER BASSET TECHNICAL SERVICES SOIL VAPOR POINT COLLECTED IN 2020



BCP SITE BOUNDARY

1. ALL CONCENTRATIONS SHOWN IN MICROGRAMS PER CUBIC METER

VOCS - VOLATILE ORGANIC COMPOUNDS



SOIL VAPOR SAMPLE LOCATIONS AND DETECTIONS

BROADWAY TRIANGLE SITE A, 663 - 667 FLUSHING AVE AND 29 - 31 BARTLETT ST, BROOKLYN NY

Prepared for:

BARTLETT CROSSING UNP LLC



Compiled by: B.V.	Date: 03/05/21	FIGURE
Prepared by: M.S.R.	Scale: AS SHOWN	
Project Mgr: L.C.	Project: 3605.0001Y002	6
File: 3605.0001Y108.6.	mxd	

Brownfield Cleanup Program Application Broadway Triangle Site A

APPENDICES

- A. Requestor Information
- B. Property Description
- C. Property's Environmental History (Previous Reports Provided as Separate Files)
- D. Property Information
- E. Current Property Owner-Operator Information
- F. Requestor Eligibility Information
- G. Contact List Information
- H. Land Use Factors

3605.0001Y108/CVRS ROUX

Brownfield Cleanup Program Application Broadway Triangle Site A APPENDIX A

Requestor Information

ROUX 3605.0001Y108/CVRS

7/29/2021 Public Inquiry

July 29, 2021 | 12:45 pm

Entity Details

ENTITY NAME:

COVID-19 Updates

Unvaccinated individuals are at greater risk of serious illness from COVID-19. Learn more about the COVID-19 vaccines.

Department of State Division of Corporations

GET THE FACTS >

Entity Information

DOS ID:

Return to Results

Return to Search

BARTLETT CROSSING LLC	6200091
FOREIGN LEGAL NAME:	FICTITIOUS NAME:
ENTITY TYPE:	DURATION DATE/LATEST DATE OF DISSOLUTION:
DOMESTIC LIMITED LIABILITY COMPANY	
SECTIONOF LAW:	ENTITY STATUS:
LIMITED LIABILITY COMPANY LAW - 203 LIMITED LIABILITY COMPANY LAW - LIMITED LIABILITY COMPANY LAW	Active
DATE OF INITIAL DOS FILING: 06/21/2021	REASON FOR STATUS:
EFFECTIVE DATE INITIAL FILING: 06/21/2021	INACTIVE DATE:
FOREIGN FORMATION DATE:	STATEMENT STATUS: CURRENT
COUNTY: Kings	NEXT STATEMENT DUE DATE: 06/30/2023
JURISDICTION:	NFP CATEGORY:
New York, United States	
Name: bartlett crossing llc Address: 2 kingsland avenue, BROOKLYN, NY, United States, Chief Executive Officer's Name and Address Name: Address:	11211
Principal Executive Office or Owner Name and Address	
Name:	
Address:	
Registered Agent Name and Address	
Name:	
Name.	

7/29/2021 Public Inquiry

Address:			
Entity Primary Location Nar	ne and Address		
Name:			
Address:			
Farmcorpflag			
Is The Entity A Farm Cor	poration: No		
Stock Information			
Share Value	Number Of Shares	Value Per Share	

Public Inquiry Page 1 of 4

August 1, 2021 | 1:20 pm

Entity Details

COVID-19 Updates

Unvaccinated individuals are at greater risk of serious illness from COVID-19. Learn more about the COVID-19 vaccines.

GET THE FACTS >

Department of State Division of Corporations

Entity Information

Return to Result	ts	Return to Search
------------------	----	------------------

ENTITY NAME: BARTLETT CROSSING MANAGERS DOS ID: 6011304

LLC

FOREIGN LEGAL NAME: FICTITIOUS NAME:

ENTITY TYPE: FOREIGN LIMITED LIABILITY DURATION

COMPANY DATE/LATEST DATE OF DISSOLUTION:

SECTIONOF LAW: 802 LLC - LIMITED LIABILITY ENTITY STATUS: Active

COMPANY LAW

DATE OF INITIAL DOS 05/12/2021 REASON FOR STATUS:

FILING:

EFFECTIVE DATE INITIAL 05/12/2021 **INACTIVE DATE:**

FILING:

FOREIGN FORMATION 05/07/2021 STATEMENT STATUS: CURRENT

DATE:

COUNTY: Kings NEXT STATEMENT DUE 05/31/2023

DATE:

JURISDICTION: Delaware, United States NFP CATEGORY:

ENTITY DISPLAY NAME HISTORY FILING HISTORY MERGER HISTORY ASSUMED NAME HISTORY

Service of Process Name and Address

Name: C/O ST. NICKS ALLIANCE CORP.

Address: 2 KINGSLAND AVENUE, BROOKLYN, NY, United States, 11211

Chief Executive Officer's Name and Address

Name:

Address:

Principal Executive Office or Owner Name and Address

Name:

Address:

Public Inquiry Page 2 of 4

Registered Agent Name and Address			
Name: C/O ST. NICKS ALLIANCE CORP.			
Address: 2 KINGSLAND AVENUE, BROOKLYN, NY, 11211			
Entity Primary Location Na	me and Address		
Name:			
Address:			
Farmcorpflag			
Is The Entity A Farm Co	rporation: No		
Stock Information			
Share Value	Number Of Shares	Value Per Share	

Public Inquiry Page 1 of 4

August 1, 2021 | 1:20 pm

Entity Details

COVID-19 Updates

Unvaccinated individuals are at greater risk of serious illness from COVID-19. Learn more about the COVID-19 vaccines.

GET THE FACTS >

Department of State Division of Corporations

Entity Information

ENTITY NAME: BARTLETT CROSSING UNP LLC DOS ID: 6200099

FOREIGN LEGAL NAME: FICTITIOUS NAME:

ENTITY TYPE: DOMESTIC LIMITED LIABILITY DURATION

COMPANY DATE/LATEST DATE OF DISSOLUTION:

SECTIONOF LAW: LIMITED LIABILITY COMPANY LAW - ENTITY STATUS: Active

203 LIMITED LIABILITY COMPANY LAW - LIMITED LIABILITY COMPANY

LAW

DATE OF INITIAL DOS 06/21/2021 REASON FOR STATUS:

FILING:

EFFECTIVE DATE INITIAL 06/21/2021 **INACTIVE DATE:**

FILING:

FOREIGN FORMATION STATUS: CURRENT

DATE:

COUNTY: Kings NEXT STATEMENT DUE 06/30/2023

DATE:

JURISDICTION: New York, United States NFP CATEGORY:

	ENTITY DISPLAY	NAME HISTORY	FILING HISTORY	MERGER HISTORY	ASSUMED NAME HISTORY	
Service	of Process Name and	l Address				
	ss: 2 kingsland avenu		/, United States, 112	111		
0.110. 2	xecutive Officer's Nam	ne and Address				
Name:						

Principal Executive Office or Owner Name and Address

Address:

Name:

Public Inquiry Page 2 of 4

Address:			
Registered Agent Name a	nd Address		
Name:			
Address:			
Entity Primary Location Na	ame and Address		
Name:			
Address:			
Farmcorpflag			
Is The Entity A Farm Co	orporation: No		
Stock Information			
Share Value	Number Of Shares	Value Per Share	

BARTLETT CROSSING LLC AUTHORIZATION TO COMPLETE REMEDIAL REQUIREMENTS

The undersigned, being all of the members of Bartlett Crossing LLC, a New York limited liability company (the "Company") hereby certify as of July **7**, 2021, as follows and adopt the following resolutions and authorize the Company to authorize and direct Frank Lang (the "Authorized Signatory") to take the following actions on behalf of the Company:

WHEREAS, the Company desires to authorize the Authorized Signatory to undertake actions necessary to redevelop at located at 663-667 Flushing Avenue and 29-31 Bartlett Street, Brooklyn, New York; Tax Block 2272, Lots 49, 51, 52, 53, and 108 and Tax Block 2269, Lot 52 (the "Property" or the "Site").

WHEREAS, in connection with the redevelopment of the Property, the Company has or will prepare and submit an application to participate in the New York State Brownfield Cleanup Program ("BCP") and, if accepted into the BCP, enter into a Brownfield Cleanup Agreement ("BCA"); file related documents with the New York State Department of Environmental Conservation ("DEC") to participate in the BCP; and undertake certain environmental remediation work related thereto consistent with applicable laws, regulations and guidance under the BCP (collectively referred to as the "Remedial Program Requirements"):

NOW THEREFORE, BE IT

RESOLVED, the Authorized Signatory be, and hereby is, authorized and directed, in the name of and on behalf of the Company, to execute and to deliver all applications, documents and instruments required to effectuate the BCA (including execution of the BCA), and make any filings required to comply with the BCA consistent with the Remedial Program Requirements; and be it further;

RESOLVED, that this Authorization may be signed in any number of counterparts, including but not limited to electronic, and shall become effective as of the date herein below written when each person named below shall have signed a copy hereof; and

RESOLVED, The Authorized Signatory is authorized to bind the Company as an Authorized Signatory for the purposes set forth in this Authorization, the signature set forth opposite his name below is his actual signature:

Authorized Signatory	Signature
Frank Lang	alte

IN WITNESS WHEREOF, the undersigned have signed and sealed this Member Consent on July____, 2021.

MEMBERS:

Bartlett Crossing Managers LLC

By: Frank Lang

BARTLETT CROSSING MANAGERS LLC AUTHORIZATION TO COMPLETE REMEDIAL REQUIREMENTS

The undersigned, being all of the members of Bartlett Crossing Managers LLC, a New York limited liability company (the "Company") hereby certify as of July 3, 2021, as follows and adopt the following resolutions and authorize the Company to authorize and direct Frank Lang (the "Authorized Signatory") to take the following actions on behalf of the Company:

WHEREAS, the Company desires to authorize the Authorized Signatory to undertake actions necessary to redevelop at located at 663-667 Flushing Avenue and 29-31 Bartlett Street, Brooklyn, New York; Tax Block 2272, Lots 49, 51, 52, 53, and 108 and Tax Block 2269, Lot 52 (the "Property" or the "Site").

WHEREAS, in connection with the redevelopment of the Property, the Company has or will prepare and submit an application to participate in the New York State Brownfield Cleanup Program ("BCP") and, if accepted into the BCP, enter into a Brownfield Cleanup Agreement ("BCA"); file related documents with the New York State Department of Environmental Conservation ("DEC") to participate in the BCP; and undertake certain environmental remediation work related thereto consistent with applicable laws, regulations and guidance under the BCP (collectively referred to as the "Remedial Program Requirements");

NOW THEREFORE, BE IT

RESOLVED, the Authorized Signatory be, and hereby is, authorized and directed, in the name of and on behalf of the Company, to execute and to deliver all applications, documents and instruments required to effectuate the BCA (including execution of the BCA), and make any filings required to comply with the BCA consistent with the Remedial Program Requirements; and be it further:

RESOLVED, that this Authorization may be signed in any number of counterparts, including but not limited to electronic, and shall become effective as of the date herein below written when each person named below shall have signed a copy hereof; and

RESOLVED, The Authorized Signatory is authorized to bind the Company as an Authorized Signatory for the purposes set forth in this Authorization, the signature set forth opposite his name below is his actual signature:

Signature
2127

IN WITNESS WHEREOF, the undersigned have signed and sealed this Member Consent on July____, 2021.

MEMBERS:

Bartlett Crossing UNP LLC

By: Frank Lang

BARTLETT CROSSING UNP LLC AUTHORIZATION TO COMPLETE REMEDIAL REQUIREMENTS

The undersigned, being all of the members of Bartlett Crossing UNP LLC, a New York limited liability company (the "Company") hereby certify as of July ____, 2021, as follows and adopt the following resolutions and authorize the Company to authorize and direct Frank Lang (the "Authorized Signatory") to take the following actions on behalf of the Company:

WHEREAS, the Company desires to authorize the Authorized Signatory to undertake actions necessary to redevelop at located at 663-667 Flushing Avenue and 29-31 Bartlett Street, Brooklyn, New York; Tax Block 2272, Lots 49, 51, 52, 53, and 108 and Tax Block 2269, Lot 52 (the "Property" or the "Site").

WHEREAS, in connection with the redevelopment of the Property, the Company has or will prepare and submit an application to participate in the New York State Brownfield Cleanup Program ("BCP") and, if accepted into the BCP, enter into a Brownfield Cleanup Agreement ("BCA"); file related documents with the New York State Department of Environmental Conservation ("DEC") to participate in the BCP; and undertake certain environmental remediation work related thereto consistent with applicable laws, regulations and guidance under the BCP (collectively referred to as the "Remedial Program Requirements");

NOW THEREFORE, BE IT

RESOLVED, the Authorized Signatory be, and hereby is, authorized and directed, in the name of and on behalf of the Company, to execute and to deliver all applications, documents and instruments required to effectuate the BCA (including execution of the BCA), and make any filings required to comply with the BCA consistent with the Remedial Program Requirements; and be it further;

RESOLVED, that this Authorization may be signed in any number of counterparts, including but not limited to electronic, and shall become effective as of the date herein below written when each person named below shall have signed a copy hereof; and

RESOLVED, The Authorized Signatory is authorized to bind the Company as an Authorized Signatory for the purposes set forth in this Authorization, the signature set forth opposite his name below is his actual signature:

Authorized Signatory	Signature
Frank Lang	zu Te

IN WITNESS WHEREOF, the undersigned have signed and sealed this Member Consent on July____, 2021.

MEMBERS:

St. Nicks Alliance Corp.	Southside United Housing Development Fun Corporation	
By: Michael Rochford	By: Juan Ramos	
RiseBoro Community Partnership Inc.	United Jewish Organization of Williamsburg, Inc.	
By: Scott Short	By: David Niederman	

IN WITNESS WHEREOF, the undersigned have signed and sealed this Member Consent on July____, 2021.

MEMBERS:

St. Nicks Alliance Corp.	Southside United Housing Development Fund Corporation
By: Michael Rochford	By: Juan Ramos
RiseBoro Community Partnership Inc.	United Jewish Organization of Williamsburg, Inc.
Act flort By: Scott Short	By: David Niederman

IN WITNESS W	HEREOF, the	e undersigned have signed and sealed this Member
Consent on July_	, 2021.	e gara and source and member

St. Nicks Alliance Corp. Southside United Housing Development Fund Corporation Harman By: Michael Rochford RiseBoro Community Partnership Inc. United Jewish Organization of Williamsburg, Inc. By: David Niederman


IN WITNESS WHEREOF, the undersigned have signed and sealed this Member Consent on July____, 2021.

MEMBERS:

St. Nicks Alliance Corp.	Southside United Housing Development Fun Corporation		
By: Michael Rochford	By: Juan Ramos		
RiseBoro Community Partnership Inc.	United Jewish Organization of Williamsburg, Inc.		
By: Scott Short	By: David Niederman		



Site A: Bartlett Crossing Construction Loan Closing

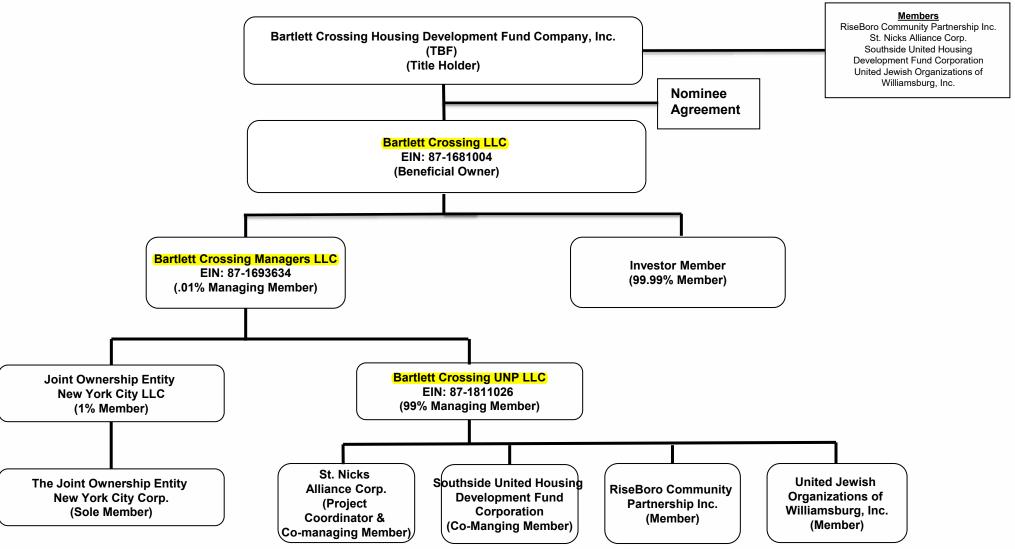

Brownfield Cleanup Program Application Broadway Triangle Site A APPENDIX B

Property Description

ROUX 3605.0001Y108/CVRS

Appendix B - Project Description

Broadway Triangle Site A
663-667 Flushing Avenue and 29-31 Bartlett Street, Brooklyn, New York 11206
BCP Application – Section II, Question 3

The Site proposed for entry into the Brownfield Cleanup Program (BCP) is located at 663-667 Flushing Avenue and 29-31 Bartlett Street in the Broadway Triangle section of Brooklyn, New York (Site), as shown on Figure 1. The Site is comprised of two separate parcels: Site A1 consists of Block 2272, Lots 49,51,52,53, and 108 and Site A2 consists of Block 2269, Lot 52 in Kings County and encompasses approximately 0.33-acres, as shown on the attached surveys dated December 18, 2019 (Appendix B). The Site is currently comprised of vacant, overgrown land with several patches of exposed concrete as shown on Figure 2. Site A1 is bounded to the north by an automotive repair facility, to the south by Flushing Avenue and Whipple Street, and to the east and west by multi-family residential buildings. Site A2 is bounded to the north and west by a construction site, to the south by Bartlett Street, and to the east by a commercial office building. Owners and land use descriptions for properties in the surrounding area are shown on Figure 3.

Proposed Development Plan

The development proposal plan includes the development of two non-adjacent parcels, Site A1 and Site A2. Site A1 will be developed as one 100% affordable, 9-story residential building consisting of 51 affordable housing units, and a 1,300 square foot facility on the ground floor operating as a nonprofit coffee shop. Site A1 will include community spaces to support the residences, including a landscaped rear yard, a laundry room, children's playroom, community room, bike storage, and a rooftop solar array. Site A2 will be developed as 9-story residential building consisting of 28 affordable housing units and will also feature a landscaped rear yard, a laundry room, children's playroom, community room, bike storage, and a rooftop solar array. Both buildings will be developed simultaneously.

Projected Schedule

Timeframe	Description	
August 2021	Submit BCP Application	
November 2021	Sign Brownfield Cleanup Agreement	
November 2021	Submit Citizen Participation Plan (CPP)	
November 2021	Submit RIWP	
December 2021	Approval and Implementation of RIWP	
March 2022	Submit RIR, RIR Fact Sheet and RAWP	
June 2022 Approval of RAWP		
January 2023	Implementation of Remedial Action	
August 2023	Draft SMP	
October 2023	Draft FER	
December 2023	Anticipated issuance of Certificate of Completion	




October 22, 2020

SITE A-1 665 FLUSHING AVE, BROOKLYN NY Revised HPD BLDS Design Consultation

BARTLETT CROSSING

SITE A-1 665 FLUSHING AVE, BROOKLYN NY



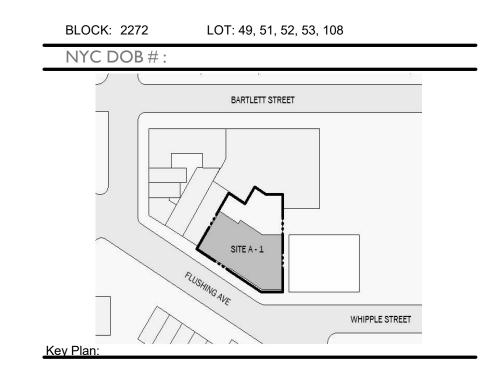

NUMBER DATE DESCRIPT

Revisions:

Architect:

Magnusson Architecture & Planning PC

42 West 39th Street 15th Floor
New York NY 10018
Tel (212) 253 7820 Fax (212) 253 1276

Structural Engineer:

MEP Engineer:

Landscape Architect:

Client Representative:

Do Not Scale Plans
Contractor to promptly notify Architect of any material variations between field conditions and existing conditions as indicated in Contract documents

Cover Page

SEAL & SIGNATURE:

PROJECT No: 19022

DRAWING BY: Author

CHK BY: Checker

DWG No:

C-001.00

SCALE:



Regulations Permitted		Proposed	DWGS	
Use Permitted	1, 2, 3, 4	2		
Use Permitted 5, 6, 7, 8, 9, 14		2		
FAR (Under Quality Housing Program ZR28-01)	Permitted	Proposed	DWGS	
Max Residential IH FAR - Wide Street	4.60	4.37		
Max Allowable Residential SF	43,820	41,610		
Max Community Facility FAR	4.00	0.13		
Max Allowable Community Facility SF	38,104	1,226		
Max Commercial FAR	2.00	0.13		
Max Allowable Commercial SF	19,052	1,226		
Max TOTAL FAR	4.60	4.50		
Max TOTAL Commercial SF	43,820	42,836		
Density	Required Density	Proposed	DWGS	
Density Factor Use Group 2	680 (65 Residential units permitted)	50		
_ot Coverage	Permitted	Proposed	DWGS	
Max Lot Coverage	65%	66%	D1100	
Max Allowable Lot Area	6,230.00	6,294		
Yard Regulations	Required	Proposed	DWGS	
Front Yard	Not Required	N/A		
Side Yards	0 or 8'	0		
Rear Yard	30'-0" min	37'-11"		
Bulk Regulations	Permitted	Proposed	DWGS	
Minimum Base Height - IH	40'	73'-6"		
Maximum Base Height - IH (QGF)	75'	73'-6"		
Maximum Building Height - IH (QGF)	95'	93'-6"		
Maximum Number of Stories - IH (QGF)	9	9		
Min Required Setback distance beyond max base height (Narrow Street)	15'	23'		
Street Wall Location	No closer to street line than exist. adj. bldg	Complies		
Dormer width = <60% of width of street wall, minus 1% of height	Max: 38' - 5 1/2"	30' - 9 3/8"		
Parking Regulations	Required	Proposed	DWGS	
Min Req accessory parking for Residential Uses	N/A, Affordable Housing Within Transit Zone	0		
Waiver of requirements for Spaces below minimum number Bicycle Parking Regulations	< 40 Spaces Required	Proposed	DWGS	
Min Req Use Group 2 (I per 2 DU) 50 DU / 2 = 25	25	26	Dirido	
Street Tree Planting	Required	Proposed	DWGS	
Street Tree Requirement	I per 25ft of street frontage = 5	3 New + 2 Fund = 5		
Planting Strip Requirement	N/A			
Quality Housing Program	Required	Proposed	DWGS	
Refuse Storage Room (2.9 cu. ft. per unit)	2.9 cu ft × 51 units = 147.9 cu ft	1,640 cu ft		
Refuse Disposal Room	Not less than 12sf/ each residential story	Complies		
Laundry Facility Equipment	I washer / 20 units = 3 washers	3		
	I dryer / 40 units = 2 dryers	3		
Daylight in Corridors	Windows min 20 sf glazed area	Complies		
Required Recreation Space: Accessible indoor and outdoor (3.3% of FA) (sf)	1373	1,344 SF		
No. 10 and 10 a	Note that The Nation	Control Inc.		

Apartment Density per Floor

	Residential (GSF)	Commercial (GSF)	Total Gross Floor Area	QUALITY HOUSING ZR 28-12, 28-13, 28-14, 28- 21, 28-31	RESIDENTIAL EXT WALL ZR 12-10 "Floor Area" (12)	BULKHEAD ZR 12-10 "Floor Area" (1), (2), (8),(11(i))	Residential ZFA	Commercial ZFA	TOTAL ZFA
FLOOR									
C	0	0	0	0	O	0	0	0	0
G	5,145	1,226	6,371	-1,640	-154	-927	2,424	1,226	3,650
2	6,294	0	6,294	-607	-189	-189	5,309	0	5,309
3	6,294	0	6,294	-607	-189	-189	5,309	0	5,309
4	6,294	0	6,294	-607	-189	-189	5,309	0	5,309
5	6,294	0	6,294	-607	-189	-189	5,309	Ö.	5,309
6	6,294	0	6,294	-607	-189	-189	5,309	0	5,309
7	6,294	0	6,294	-607	-189	-189	5,309	Ö	5,309
8	4,483	0	4,483	-549	-134	-134	3,665	0	3,665
9	4,483	0	4,483	-549	-134	-134	3,665	0	3,665
R	1,463	0	1,463	0	0	-1,463	0	0	0
TOTAL	53,338	1,226	54,564	-6,380	-1556	-3,792	41,610	1,226	42,836

DEDUCTIONS / GSF EXEMPT FROM ZFA

Residential

SITE

Commercial

Total Gross


RESIDENTIAL MECH &

Residential


Commercial

TOTAL ZFA



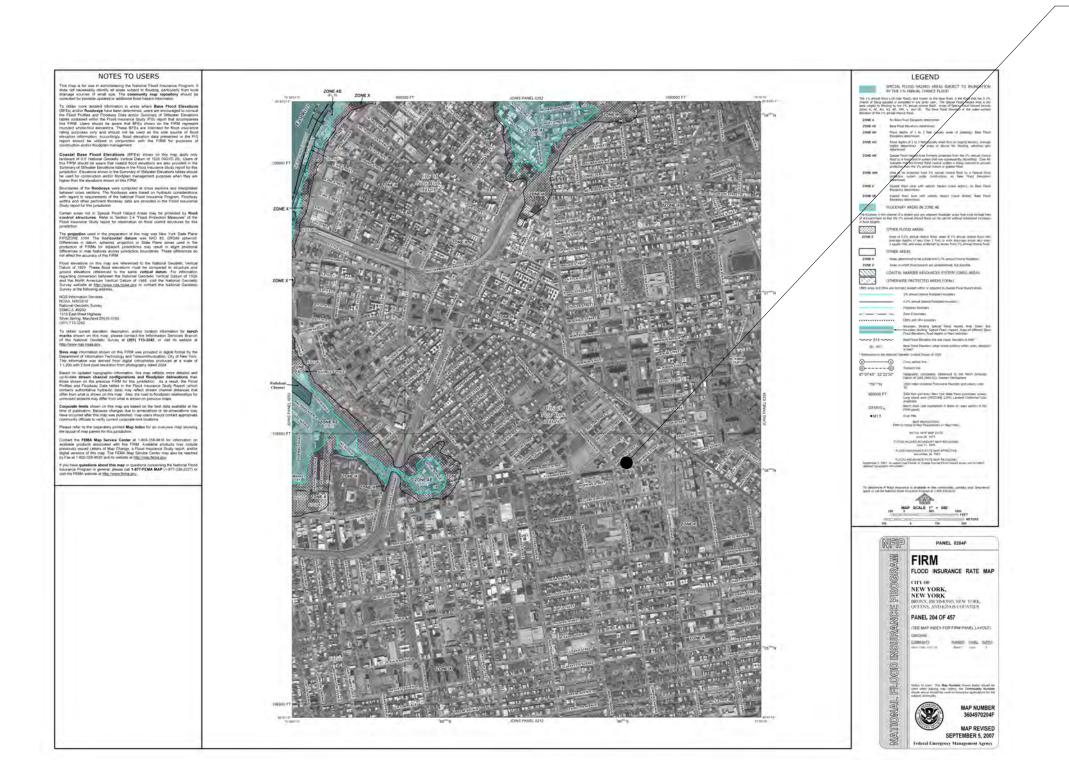

Max: 11 Units

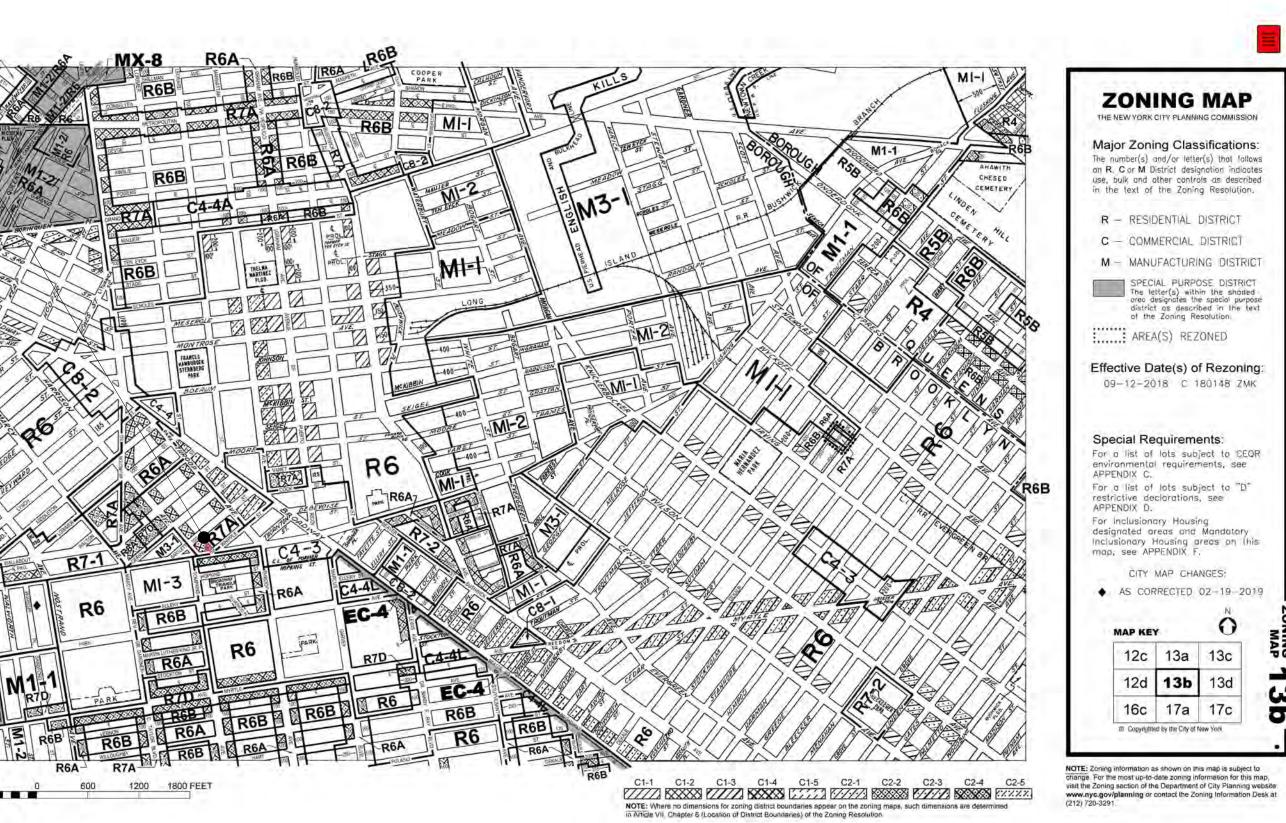

BARTLETT CROSSING


Res Res Res Res 1BR 2BR 3BR 4BR

Total DU

FLOOR

SITE A-1 665 FLUSHING AVE, BROOKLYN NY Owner:



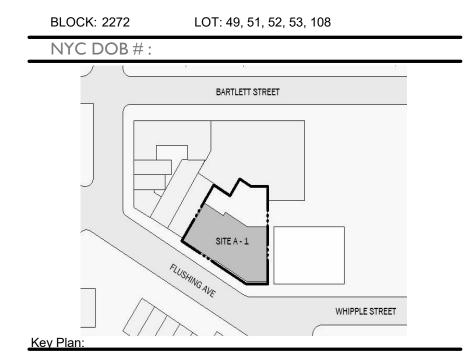

NUMBER DATE DESCRIPTION

Architect:

Magnusson Architecture & Planning PC

42 West 39th Street 15th Floor New York NY 10018

Tel (212) 253 7820 Fax (212) 253 1276 Structural Engineer: CityScape Engineering PLLC 8 Haven Ave., Port Washington NY 11050

Tel (631) 978-5000 MEP Engineer:

Landscape Architect:

Client Representative:

Filing Representative:

Do Not Scale Plans

Contractor to promptly notify Architect of any material variations between field conditions and existing conditions as indicated in Contract documents

ZONING ANALYSIS

SEAL & SIGNATURE: PROJECT No: 19022 DRAWING BY: Author CHK BY: DWG No:

CHAPTER 3: USE AND OCCUPANCY CLASSIFICATION

OCCUPANCY SCHEDULE OCCUPANCY GROUP

RESIDENTIAL INCIDENTAL USE PER STORAGE ROOM OVER 100 SF TRASH COMPACTOR ROOM INCIDENTAL USE PER TABLE 509 MECHANICAL AND/OR ELECTRICAL EQUIP. ROOM INCIDENTAL USE PER TABLE 509 INCIDENTAL USE PER TABLE 509 LAUNDRY ROOM OVER 100 SF

BUSINESS COMMERCIAL

CHAPTER 5: GENERAL BUILDING HEIGHTS AND AREAS; SEPARATION OF OCCUPANCIES

NOTE:		
TABLE 503: ALLOWABLE HEIGHT AND BUILDING AREAS CONSTRUCTION TYPE I-B = UNLIMITED; FULLY SPRINKLERED BLDG		PROPOSE
BC 508: INCIDENTAL USE AREAS AND MIXED OCCUPANCIES:		
TABLE 509 INCIDENTAL USE AREAS		
ROOM OR AREA FIRE SEPARATION	PROTECTION PROVIDED	
RESIDENTIAL_		
STORAGE OVER 100 SF TRASH COMPACTOR ROOM	2HR 3HR	
MECHANICAL AND/OR ELECTRICAL EQUIP. ROOM LAUNDRY OVER 100 SF	2HR OHR	
TABLE 508.4 REQUIRED SEPARATION OF OCCUPANCIES (HOURS)		
BETWEEN R-2 AND S-1 TENANCIES	1HR	

1HR

CHAPTER 6: TYPES OF CONSTRUCTION

BETWEEN R-2 AND B TENANCIES

TYPE I NON-COMBUSTIBLE (FROM TABLE 601 & TABLE 602)	CLASS <u>1-B</u>
TABLE 601: FIRE RESISTANCE RATING FOR BUILDING ELEMENTS	RATING IN HOURS
STRUCTURAL FRAME	2
BEARING WALLS EXTERIOR INTERIOR	2* 2
NONBEARING WALLS AND PARTITIONS EXTERIOR *	1
NONBEARING WALLS AND PARTITIONS INTERIOR	0
FLOOR CONSTRUCTION INCLUDING SUPPORTING BEAMS AND JOISTS	2
ROOF CONSTRUCTION	1

* BASED ON TABLE 602, FOR FIRE SEPERATION DISTANCE < 5FT FIRE RESISTANCE RATING FOR EXTERIOR WALLS FOR OCCUPANCY R = 1 HR

CHAPTER 7: FIRE RESISTANCE RATED CONSTRUCTION

TABLE 705.8: MAXIMUM AREA OF EXTERIOR WALL OPENINGS

LOT LINE WINDOWS ALONG WEST ELEVATION

FIRE SEPARATION DISTANCE	DEGREE OF OPENING PROTECTION	ALLOWABLE AREA
0'	UNPROTECTED, SPRINKLERED	10% PER STORY

NOTE: THESE OPENINGS DO NOT CREDIT TOWARDS MEETING ANY MANADATORY NATURAL LIGHT OR VENTILATION REQUIREMENTS.

CHAPTER 8: INTERIOR FINISH FLAME SPREAD INDEX

TABLE 803.1 INTERIOR WALL AND CEILING FINISH REQUIREMENTS BY OCCUPANCY

		SPRINKLERED	
GROUP	VERTICAL EXITS AND EXIT PASSAGEWAYS	EXIT ACCESS CORRIDORS AND OTHER EXITWAYS	ROOMS AND ENCLOSED SPACES
R-2	В	В	С
В	В	В	В

CHAPTER 10: MEANS OF EGRESS

TABLE 1004.1.1: MAXIMUM FLOOR AREA ALLOWANCES PER OCCUPANT

USE OF SPACE	(SF)	OCCUPANT LOAD (FLOOR AREA PER OCCUPANT PER TABLE 1004.1.1)
RESIDENTIAL = 200 GROSS SF WITHIN DWE	ELLING UNITS	
1ST FLOOR	864	4
2ND FLOOR	6,294	30
3RD FLOOR	6,294	30
4TH FLOOR	6,294	30
5TH FLOOR	6,294	30
6TH FLOOR	6,284	30
7TH FLOOR	6,294	30
8TH FLOOR	4,483	16
9TH FLOOR	4,483	16
EXTERIOR RECREATION SPACE = 15 GROSS		
REAR YARD	1,948	130
ACCESSORY ASSEMBLY A-2 = 15 NET		
1ST FLOOR (COMMUNITY ROOM)	483	32
RESIDENTIAL LAUNDRY = 100 GROSS SF		
1ST FLOOR LAUNDRY ROOM	197	2
ACCESSORY BUSINESS (OFFICE) - 100 GROS	SS SF 80	1

INCIDENTAL USE AREAS ACCESSORY STORAGE AREAS, MECHANICAL EQUIPMENT ROOMS (300 GROSS SF PER PERSON) FOR ACCESSORY STORAGE AREAS, TRASH COMPACTION ROOM, MECH. AND EQUIP. RMS.) 1,500 **B OCCUPANCY** MERCANTILE - AREAS ON THE FLOOR = 30 GROSS FIRST FLOOR (COMMERCIAL)

EXIT AND ACCESS REQUIREMENTS PART I

BUILDING			S TRAVEL DISTANCE (FT) 1016.1	CORRI	DORS
CCUPANCY GROUP OF BUR SPACE	ROUP ESIGNATION	NSPRINKLERED	PRINKLERED	MIN. WIDTH (IN.) SECTION	MAX. DEAD END (LENGTH IN FT) SECTION 1018 4

BUILDING		TABLE	1016.1	CORRI	DORS
OCCUPANCY GROUP OF BU	GROUP DESIGNATION	UNSPRINKLERED	SPRINKLERED	MIN. WIDTH (IN.) SECTION 1018.2	MAX. DEAD END (LENGTH IN FT) SECTION 1018.4
RESIDENTIAL	R-2	150	200	44	80*
BUISNESS	В	200	300	44	50

*BC 1018.4 EXCEPTION 4 4. In occupancies in Group R-2, the dead end in a corridor shall not exceed 40 feet (12 192 mm). However, where the corridors are completely enclosed in construction having a 2-hour fire-resistance rating with all doors opening into the corridor being self-closing and having a fire-resistance rating of 1½ hours, the length of dead-end corridor shall not exceed80 feet (24 384 mm)

EXIT AND ACCESS RE	QUIREMENTS	S PART II			
		REQUIRED WI INCH (TABLE		WIDTHS	PROVIDED
FLOOR (SEPARATE MEANS OF EGRESS FOR EACH OCCUPANCY)	GROUP DESIGNATION	OTHER EGRESS COMPONENTS (0.2" PER OCCUPANT SERVED) * EXIT DOOR WIDTH OF 36" - CAPCITY OF 180 PPL CORRIDOR WIDTH OF 60" - CAPCITY OF 120 PPL	STAIRWAYS (0.3" PER OCCUPANT SERVED) (2) STAIRS WITH WIDTH OF 36" EACH - CAPCITY OF 120 PPL PER EACH STAIR	STAIRWAYS	OTHER EGRESS COMPONENTS (MIN)
8TH & 9TH FLOOR	R2	3.2	4.8	(2) 36	36
2ND - 7TH FLOOR	R2	6.0	9.0	(2) 36	36
FIRST FLOOR	R2	33.8	NA	NA	72
COMMERCIAL	В	8.2	NA	NA	72

CHAPTER 10: MEANS OF EGRESS - CONT

TABLE 1015.1 NUMBER OF EXITS

OCCUPANCY	MAXIMUM OCCUPANTS ALLOWED IN SPACES WITH ONE MEANS OF EGRESS	MAXIMUM OCCUPANCY OF PROVIDED SPACES	NUMBER OF MEANS OF EGRES PROVIDED
R-2	20	32	2
В	74	41	1

SPECIAL INSPECTIONS

ALL METHODS AND CONSTRUCTION COMPONENTS / ASSEMBLIES REQUIRING SPECIAL INSPECTION SHALL BE INSPECTED AND TESTED WHEN REQUIRED TO VERIFY COMPLIANCE WITH THE BUILDING CODE. ALL REQUIRED AUTHORIZED BY THE DEPARTMENT OF BUILDINGS ON BEHALF OF THE OWNER AND AS IDENTIFIED BY THE DESIGN ARCHITECT OF RECORD. ALL SPECIAL INSPECTIONS AND TESTS SHALL BE RECORDED AND MADE AVAILABLE TO THE DEPT. OF BUILDINGS FOR AT LEAST 6 YEARS.

INSPECTION	SECTION
STRUCTURAL STEEL - WELDING	BC 1704.3.1
STRUCTURAL STEEL - DETAILING	BC 1704.3.2
STRUCTURAL STEEL - HIGH STRENGTH BOLTING	BC 1704.3.3
STRUCTURAL COLD-FORMED STEEL	BC 1704.4
CONCRETE - CAST IN PLACE	BC 1704.4
CONCRETE - PRECAST	BC 1704.4
MASONRY	BC 1704.5
WALL PANELS, CURTAIN WALLS, AND VENEERS	BC 1704.10
SPRAYED FIRE-RESISTANT MATERIALS	BC 1704.11
MECHANICAL SYSTEMS	BC 1704.16
PRIVATE ON-SITE STORM WATER DRAINAGE DISPOSAL SYSTEMS, AND	BC 1704.21.2
DETENTION FACILITIES INSTALLATION	
SPRINKLER SYSTEMS	BC 1704.23
STANDPIPE SYSTEMS	BC 1704.24
HEATING SYSTEMS	BC 1704.25
CHIMNEYS	BC 1704.26
FIRE-RESISTANT PENETRATIONS AND JOINTS	BC 1704.27
SEISMIC ISOLATION SYSTEM	BC 1707.8
CONCRETE DESIGN MIX	BC 1905.3 BC 1913.5
CONCRETE SAMPLING AND TESTING	BC 1905.6 BC 1913.10

PROGRESS INSPECTIONS

INSPECTION	SECTION
PRELIMINARY	28-116.2.1 BC 110.2
FOOTING AND FOUNDATION	BC 110.3.1
ENERGY CODE COMPLIANCE INSPECTIONS	BC 110.3.5
FIRE-RESISTANCE RATED CONSTRUCTION	BC 110.3.4
FINAL	28-116.2.4.2 BC 110.5
	DIRECTIVE 14 OF 1975 AND
	1 RCNY S101-10

ENERGY CODE PROGRESS INSPECTIONS

PROGRESS INSPECTION	TABLE REFERENCE IN RCN
	5000-01(h) (1) and (2
- PROTECTION OF FOUNDATION INSULATION	(IA1), (IIA1)
- INSULATION PLACEMENT AND R VALUES	(IA2), (IIA2)
- FENESTRATION THERMAL VALUES AND RATINGS	(IA3), (IIA3)
- FENESTRATION RATINGS FOR AIR LEAKAGE	(IA4), (IIA4)
- FENESTRATION AREAS	(IA5), (IIA5)
- AIR SEALING AND INSULATION - VISUAL	(IA6), (IIA6)
- AIR SEALING AND INSULATION - TESTING	(IA7)
- PROJECTION FACTORS	(IIA7)
- DAMPERS INTEGRAL TO BUILDING ENVELOPE	(IB2), (IIB2)
- HVAC AND SERVICE WATER HEATING EQUIPMENT	(IB3), (IIB3)
- HVAC AND SERVICE WATER HEATING SYSTEM CONTROLS	(IB4), (IIB4)
- DUCT PLENUM AND PIPING INSULATION AND SEALING	(IB5), (IIB5)
- DUCT LEAKAGE TESTING	(IB6, (IIB6)
- ELECTRICAL METERING	(IC1), (IIC1)
- LIGHTING IN DWELLING UNITS	(IC2), (IIC2)
- INTERIOR LIGHTING POWER	(IIC3)
- EXTERIOR LIGHTING POWER	(IIC4)
- LIGHTING CONTROLS	(IIC5)
- EXIT SIGNS	(IIC6)
- TANDEM WIRING	(IIC7)
- ELECTRICAL MOTORS	(IIC8)
	(-)


SEISMIC DESIGN CATEGORY

STRUCTURAL OCCUPANCY/RISK CATEGORY AND IMPORTANCE FACTOR II PER NYC BC 1604.5 SEISMIC CATEGORY B

BARTLETT CROSSING

SITE A-1 665 FLUSHING AVE, BROOKLYN



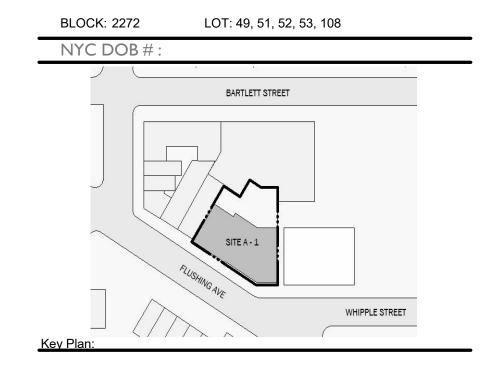

Architect: Magnusson Architecture & Planning PC 42 West 39th Street 15th Floor New York NY 10018 Tel (212) 253 7820 Fax (212) 253 1276 Structural Engineer: CityScape Engineering PLLC 8 Haven Ave., Port Washington NY 11050 Tel (631) 978-5000 MEP Engineer: Landscape Architect: Client Representative:

NYC BUILDING CODE ANALYSIS


Filing Representative:

Do Not Scale Plans

	A-0	04 00
	DWG No:	
	CHK BY:	Checker
	DRAWING BY:	Author
SEAL & SIGNATURE:	PROJECT No:	19022


Contractor to promptly notify Architect of any material variations between field conditions and existing conditions as indicated in Contract documents

 $I \setminus UU \cup UU$ SCALE:

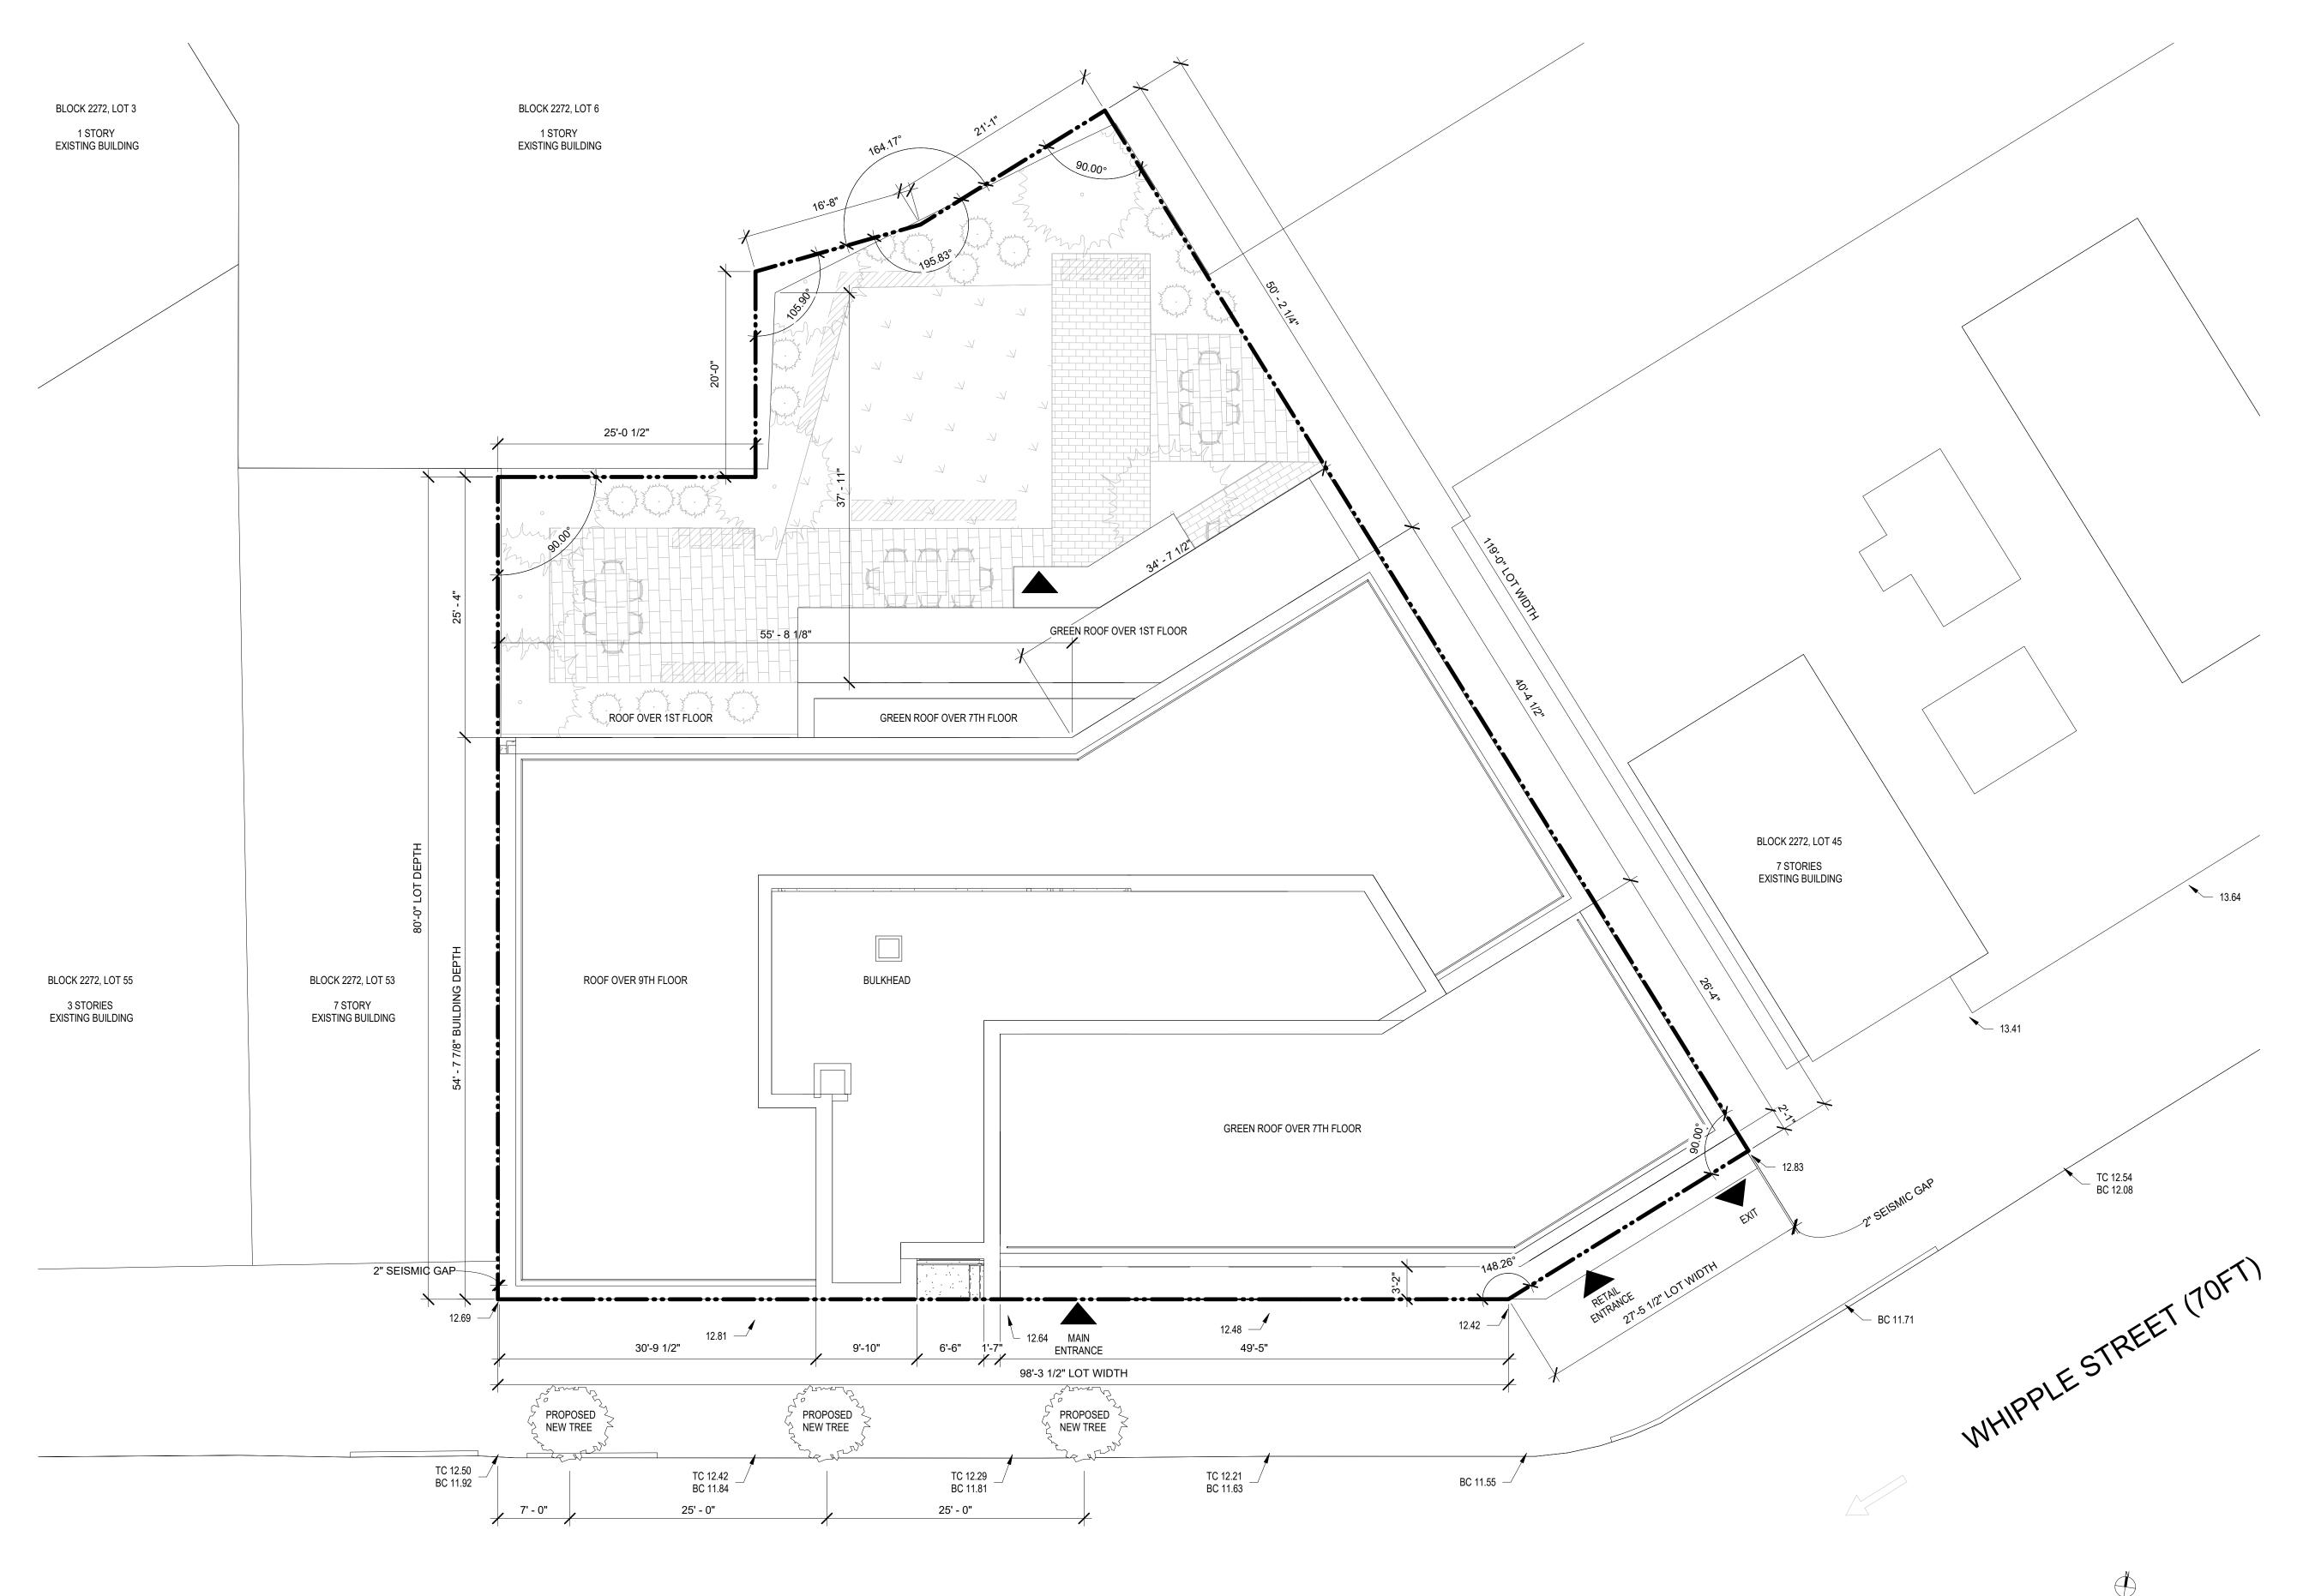

SITE A-1 665 FLUSHING AVE, BROOKLYN NY



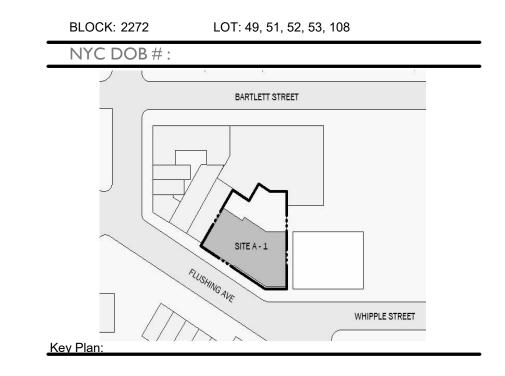

NUMBER DATE DESCRIPTION

Architect:

Mapusson Architecture & Planning PC

42 West 39th Street 15th Floor
New York NY 10018
Tel (212) 253 7820 Fax (212) 253 1276

Structural Engineer:
CityScape Engineering PLLC
8 Haven Ave., Port Washington NY 11050
Tel (631) 978-5000

MEP Engineer:

Landscape Architect:

Client Representative:


Do Not Scale Plans Contractor to promptly notify Architect of any material variations between field conditions and existing conditions as indicated in Contract documents

SITE PLAN

SEAL & SIGNATURE:	PROJECT No:	19022
	DRAWING BY:	Author
	CHK BY:	Checker
	DWG No:	
	A-0′	12.00


FLUSHING AVE (70FT)

1) SITE PLAN 1/8" = 1'-0"

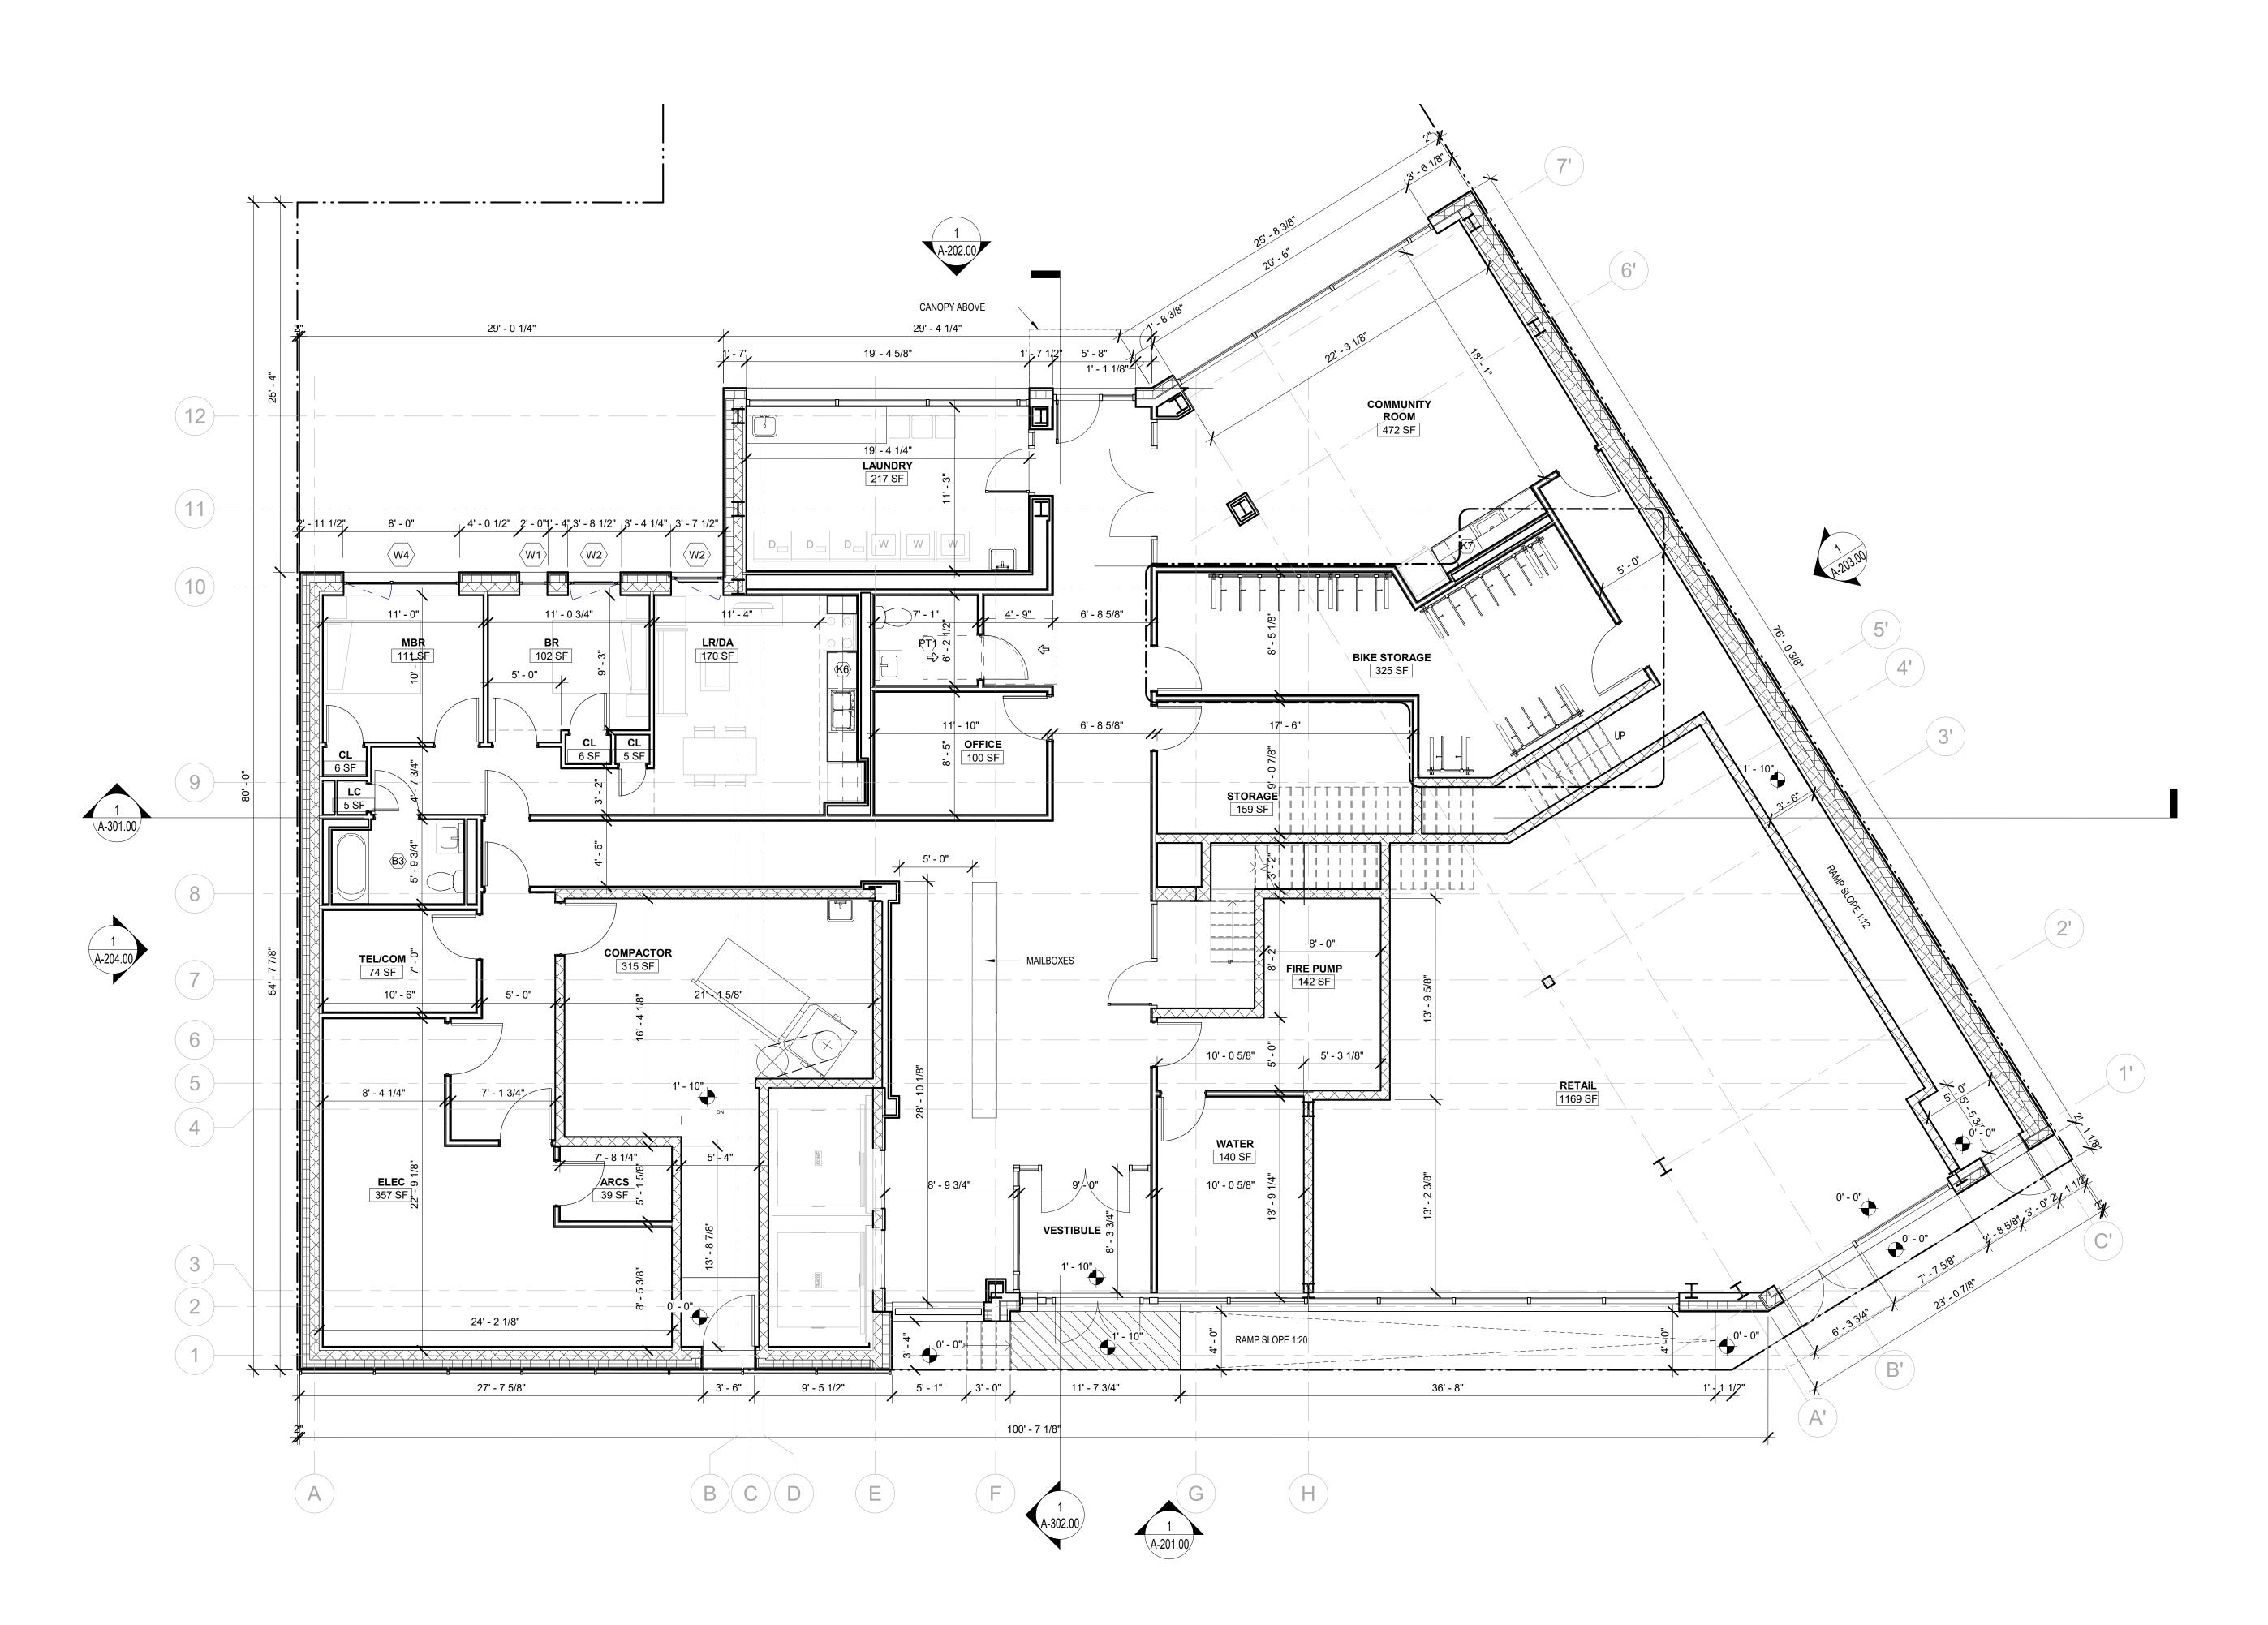

SITE A-1 665 FLUSHING AVE, BROOKLYN NY



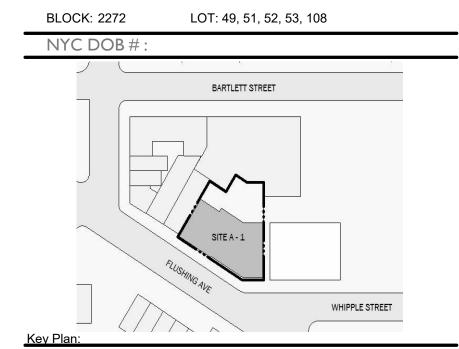

NUMBER DATE DESCRIPTION




GROUND FLOOR PLAN

SEAL & SIGNATURE:	PROJECT No: 19022
	DRAWING BY: Author
	CHK BY: Checker
	DWG No:
	A-101.00
	SCALE: 3/16" = 1'-0"



SITE A-1 665 FLUSHING AVE, BROOKLYN NY



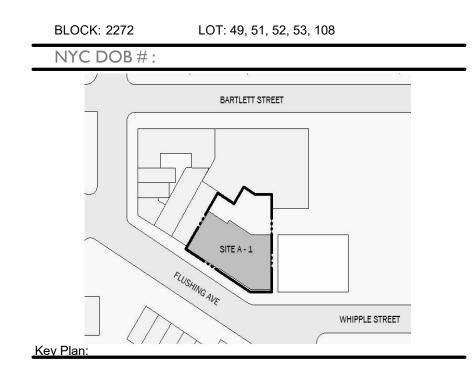


NUMBER DATE DESCRIPTION




2ND TO 7TH TYPICAL FLOOR PLAN

SEAL & SIGNATURE:	PROJECT No:	19022
	DRAWING BY:	Author
	CHK BY:	Checker
	DWG No:	
	A-1()2.00
	SCALE: 3/16" = 1'-0"	

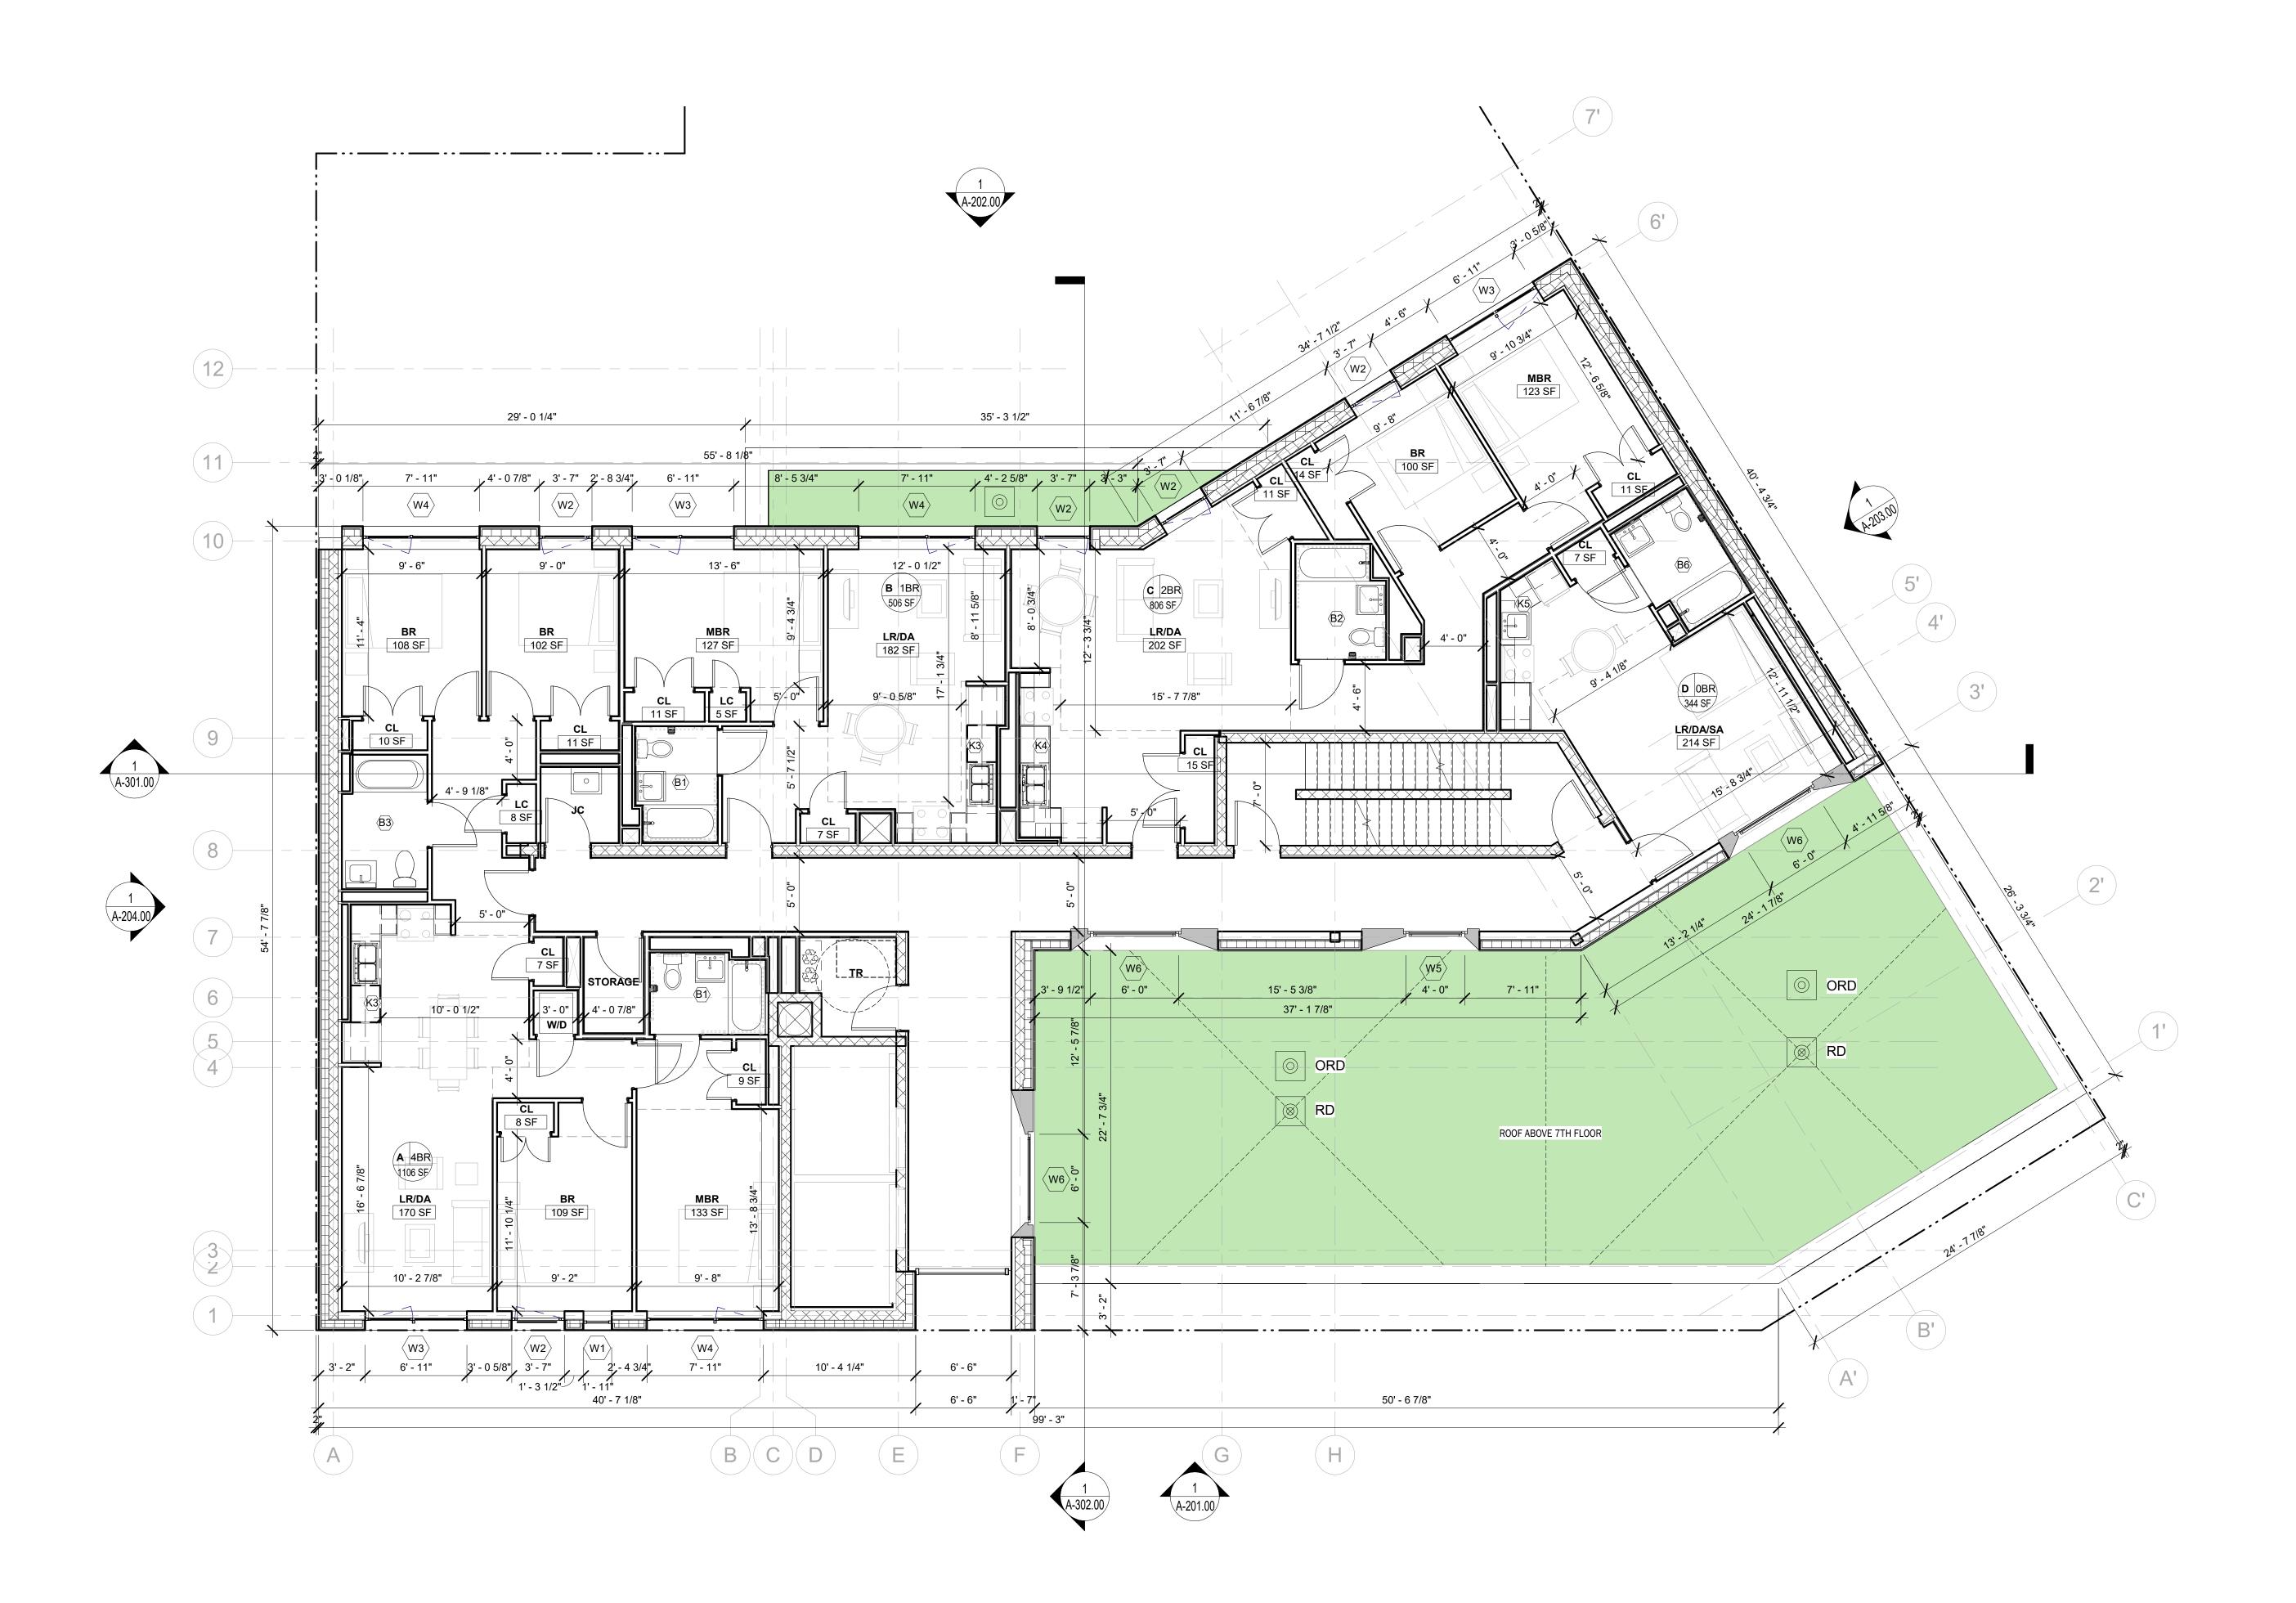

SITE A-1 665 FLUSHING AVE, BROOKLYN NY



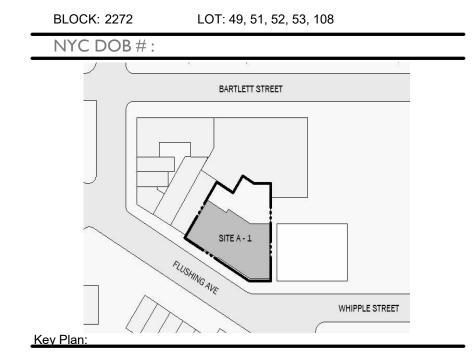

NUMBER DATE DESCRIPTION




Contractor to promptly notify Architect of any material variations between field conditions and existing conditions as indicated in Contract documents

8TH FLOOR PLAN


Do Not Scale Plans

SEAL & SIGNATURE:	PROJECT No:	19022
	DRAWING BY:	Author
	CHK BY:	Checker
	DWG No:	
	A-10	03.00

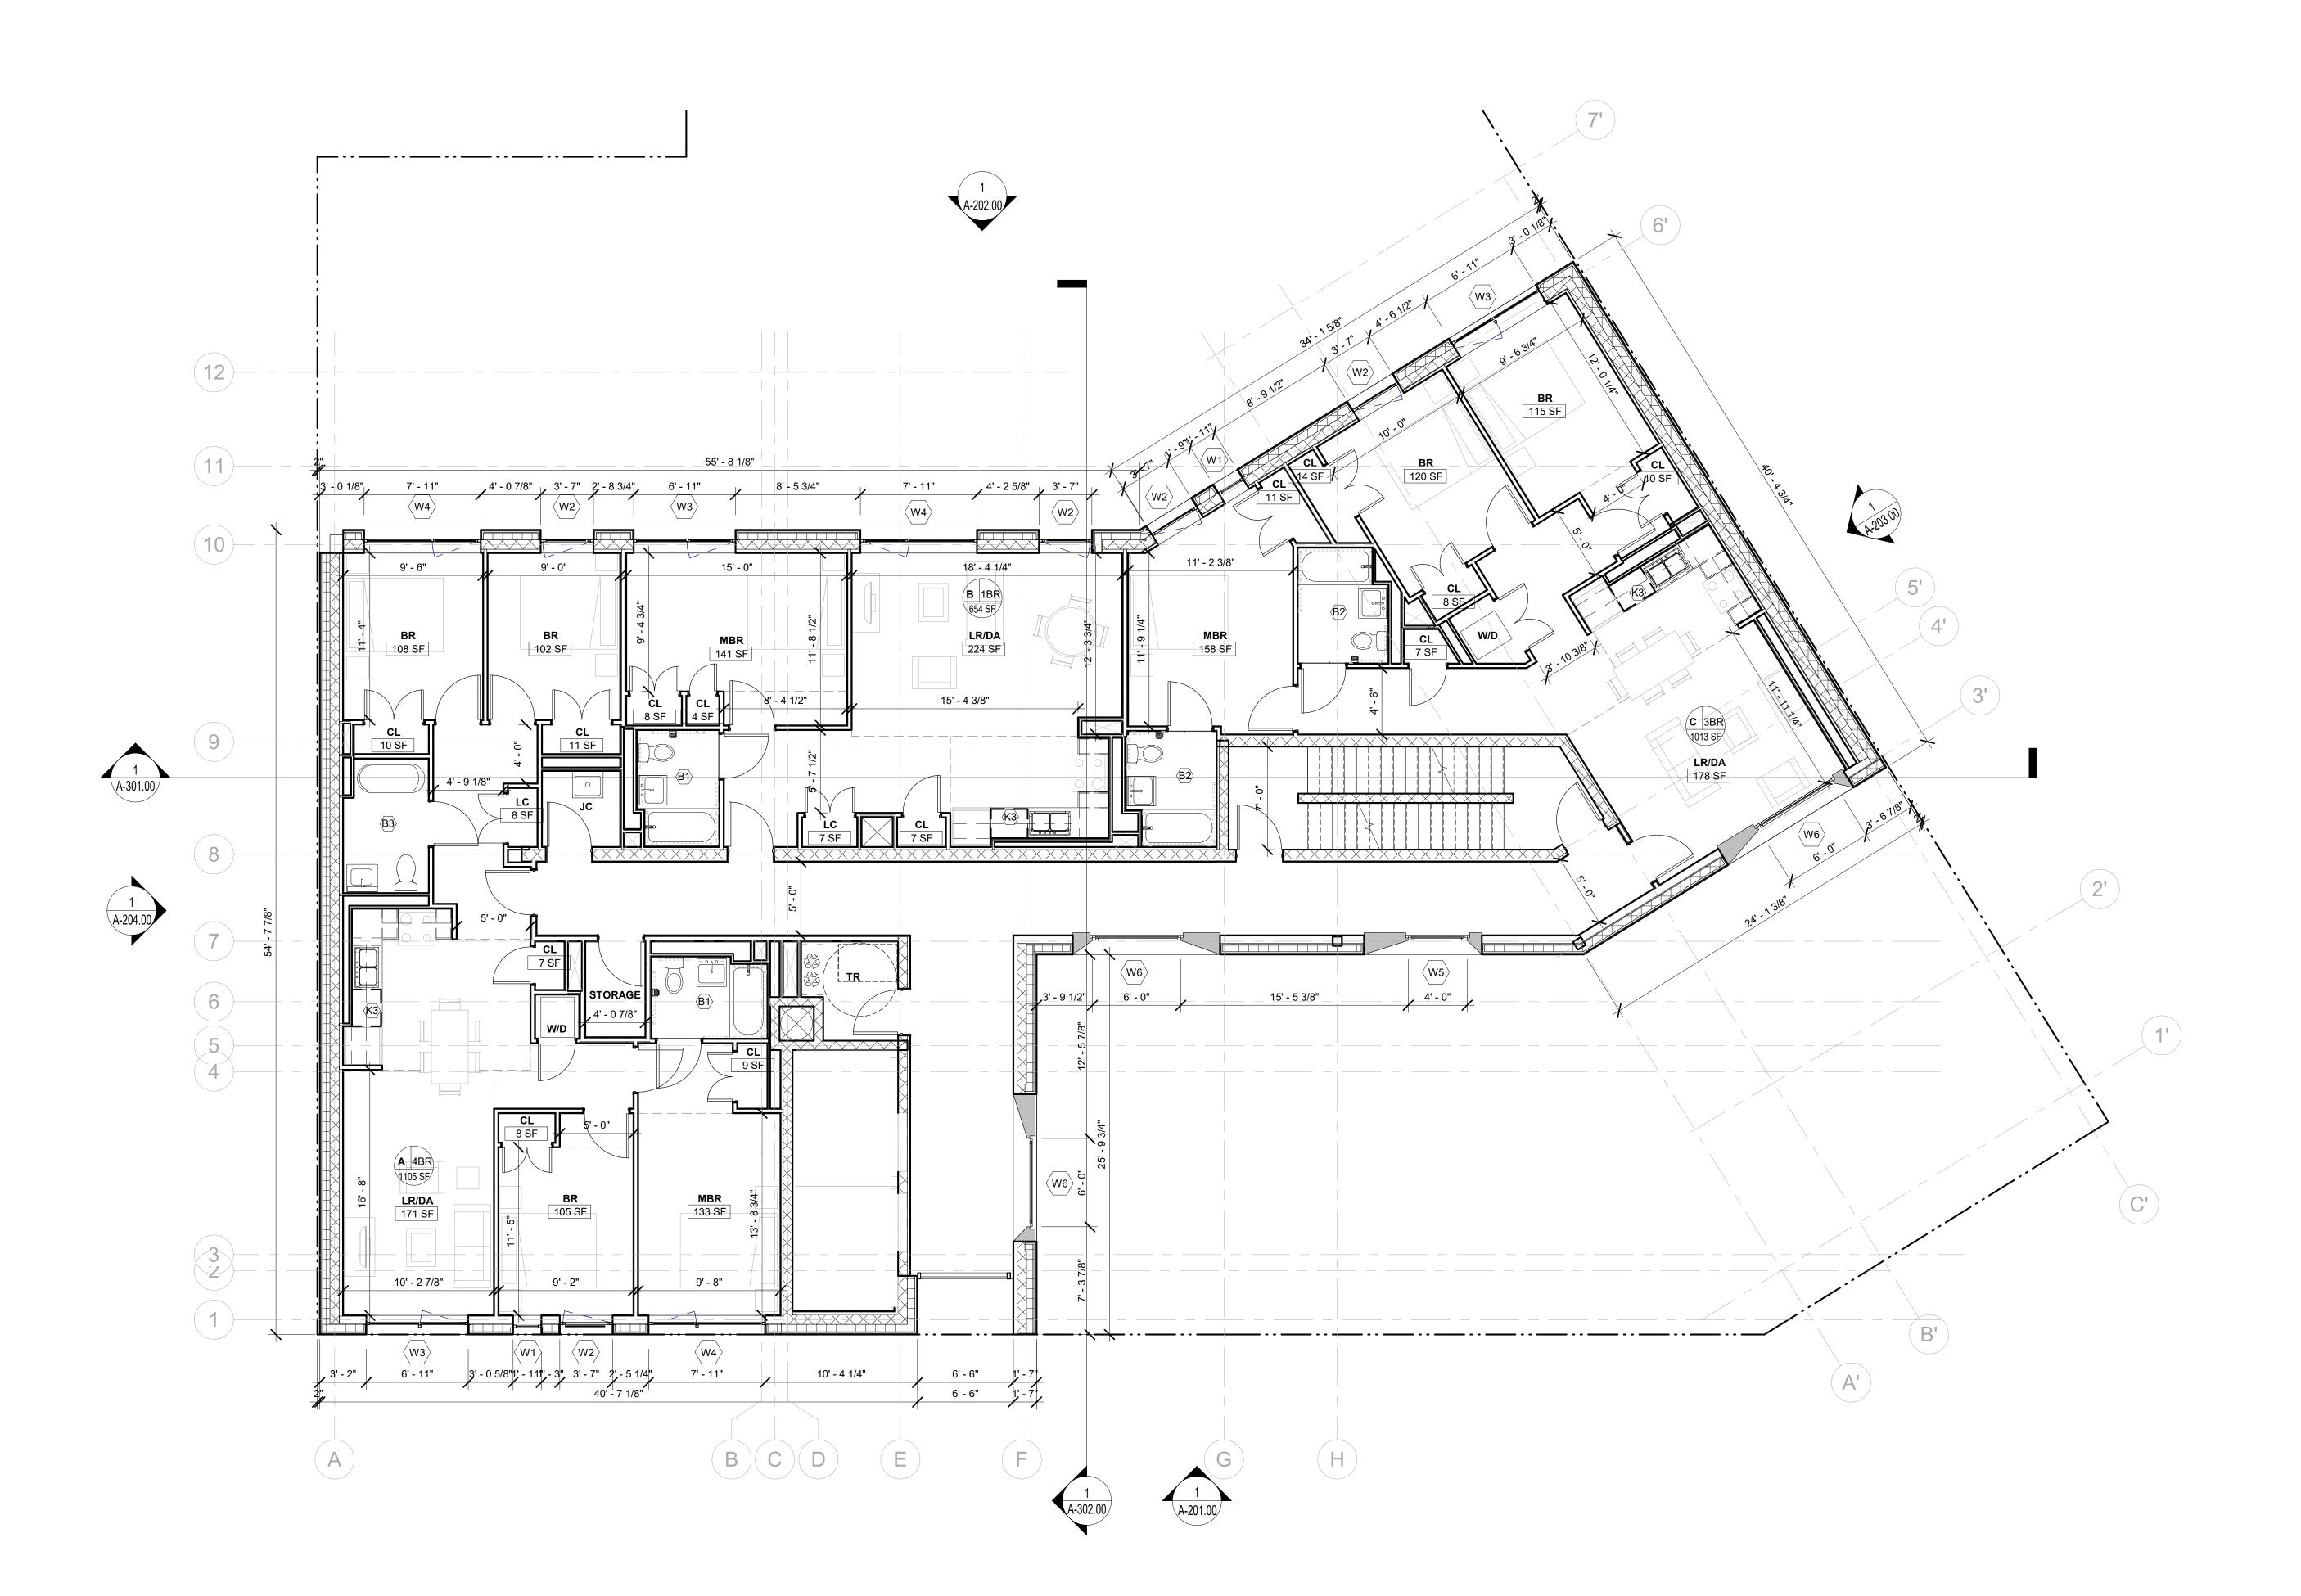

SITE A-1
665 FLUSHING AVE, BROOKLYN
NY



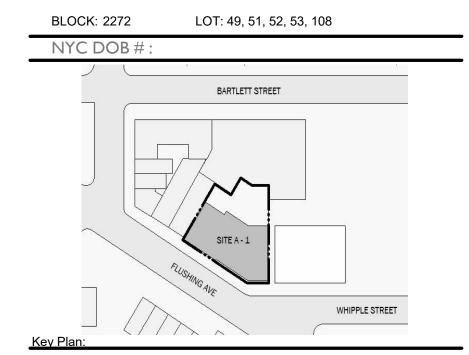

NUMBER DATE DESCRIPTION

Architect:

MAP

Magnusson Architecture & Planning PC

42 West 39th Street 15th Floor
New York NY 10018

Tel (212) 253 7820 Fax (212) 253 1276

Structural Engineer:
CityScape Engineering PLLC
8 Haven Ave., Port Washington NY 11050
Tel (631) 978-5000

MEP Engineer:

Landscape Architect:


Client Representative:

Contractor to promptly notify Architect of any material variations between field conditions and existing conditions as indicated in Contract documents

9TH FLOOR PLAN


Do Not Scale Plans

SEAL & SIGNATURE:	PROJECT No:	19022
	DRAWING BY:	Author
	CHK BY:	Checker
	DWG No:	
	A-1(04.00

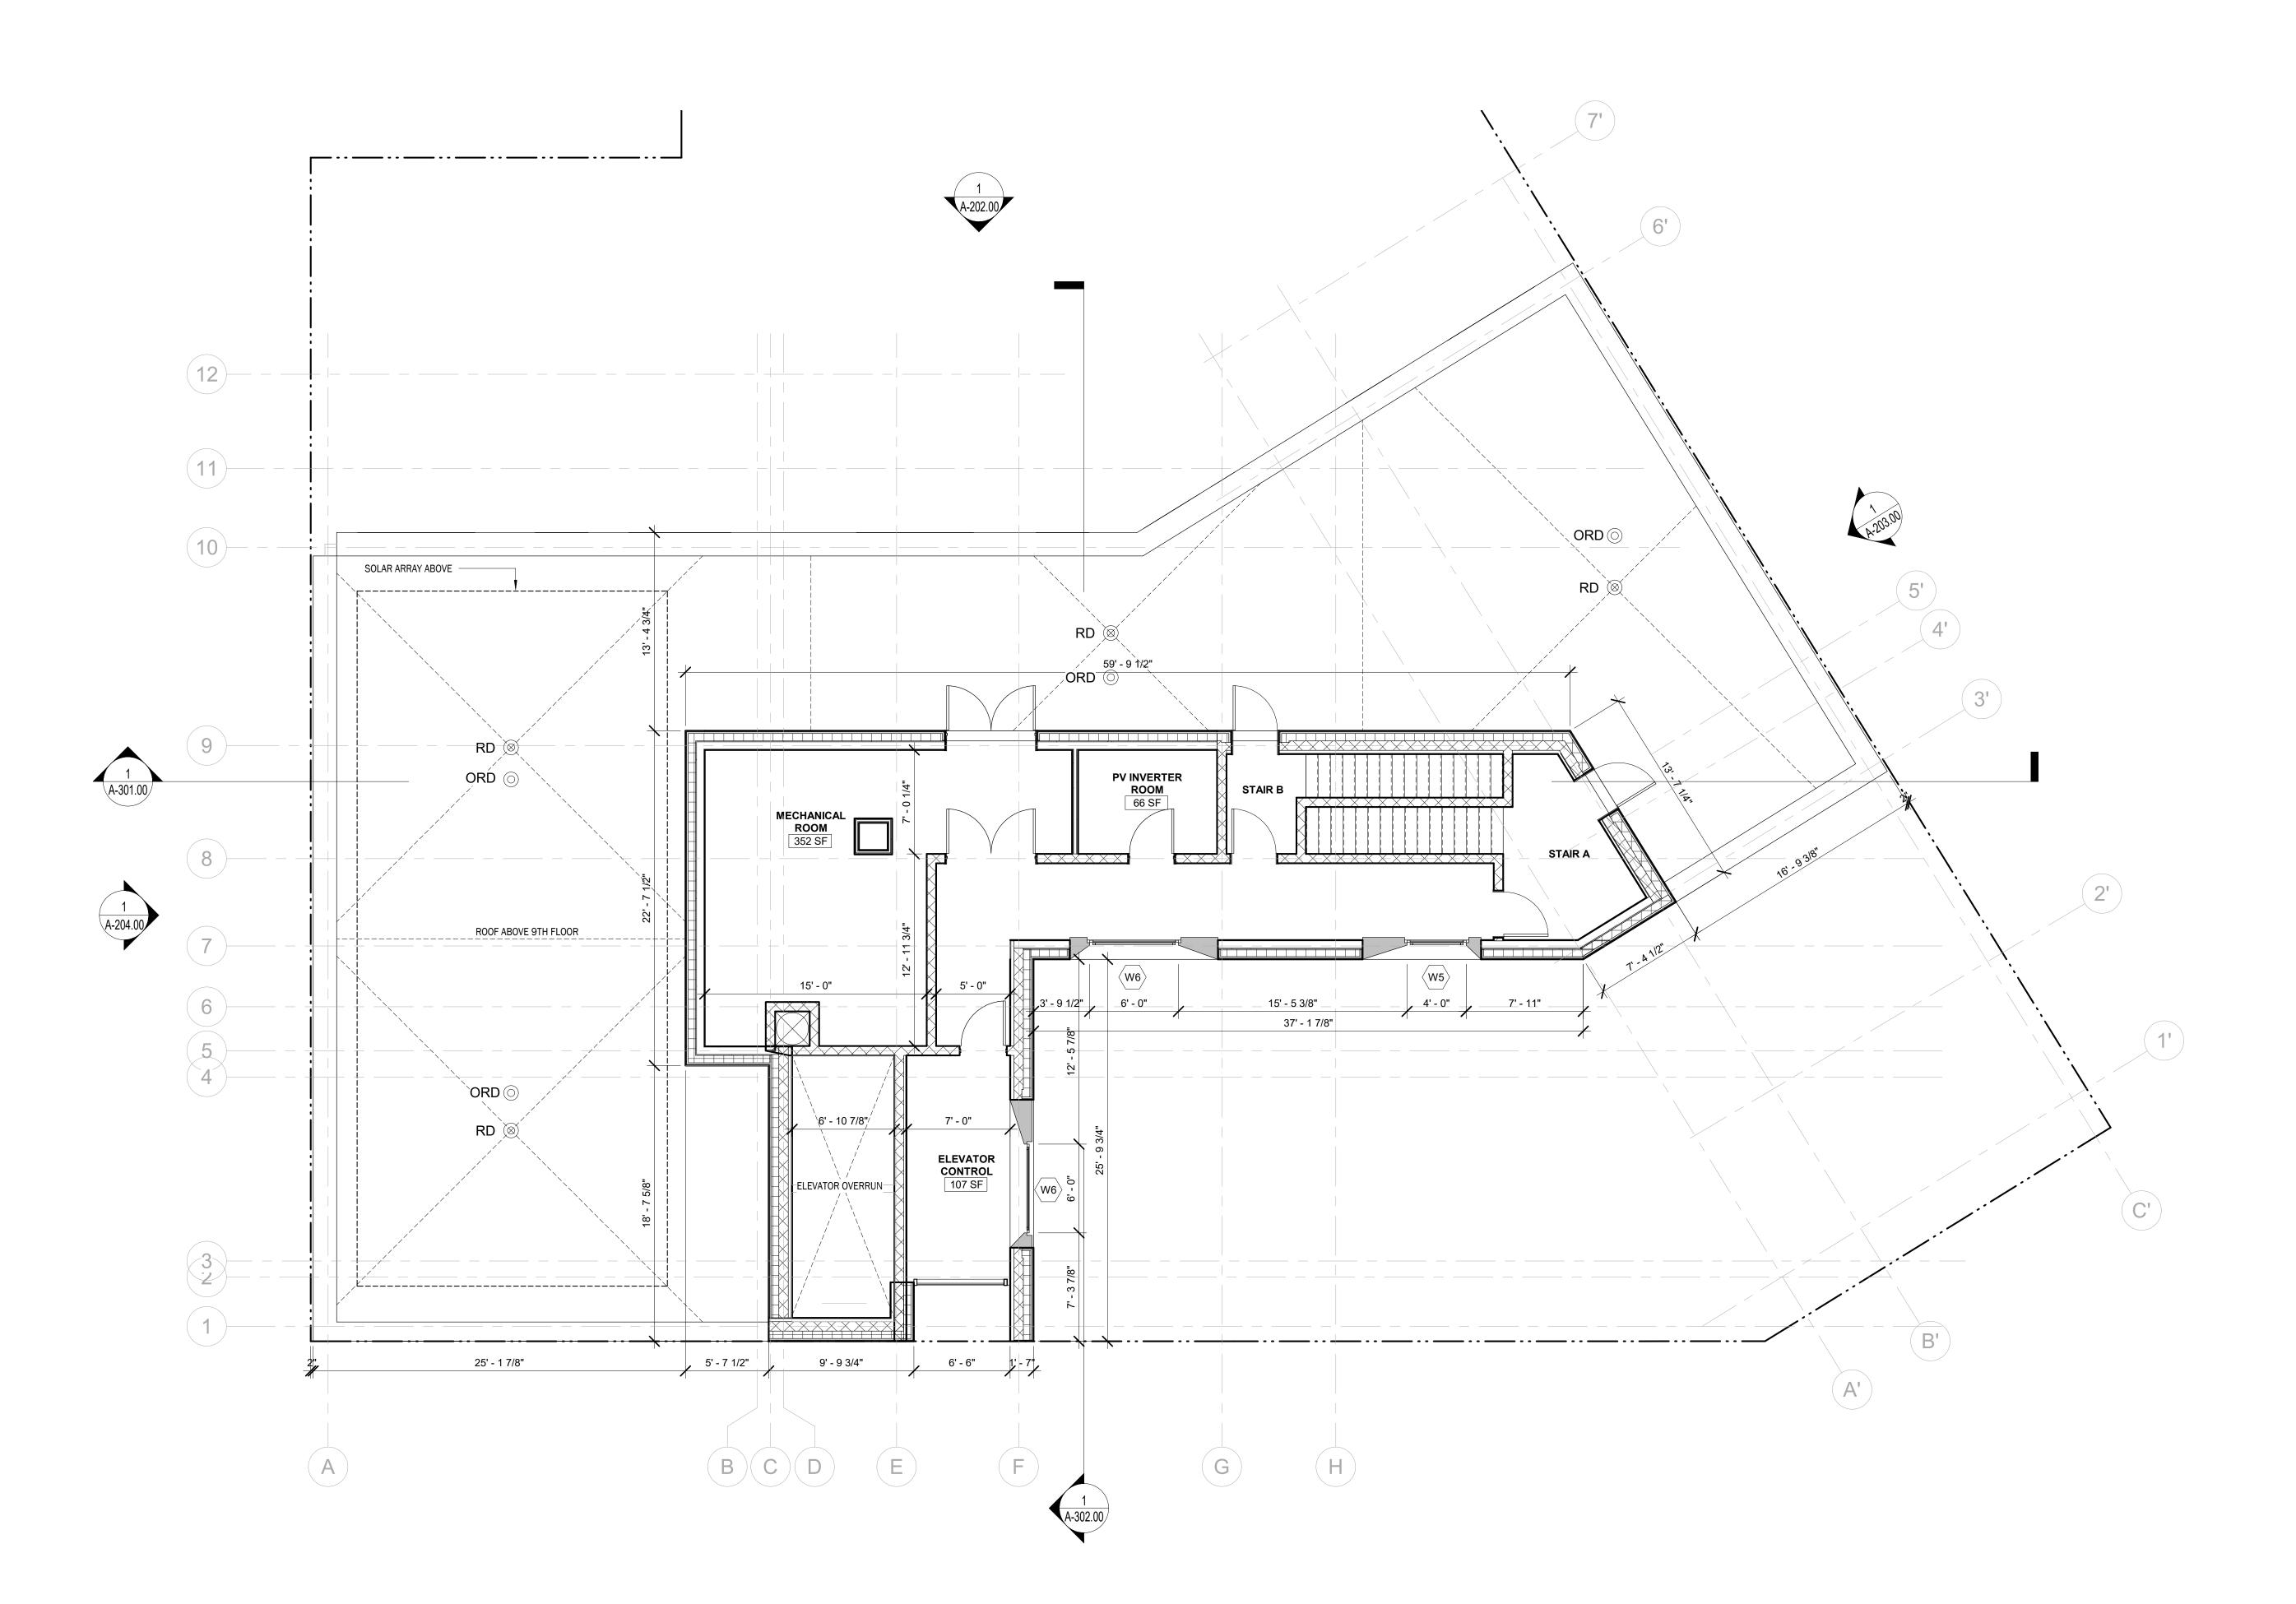

SITE A-1 665 FLUSHING AVE, BROOKLYN NY Owner:



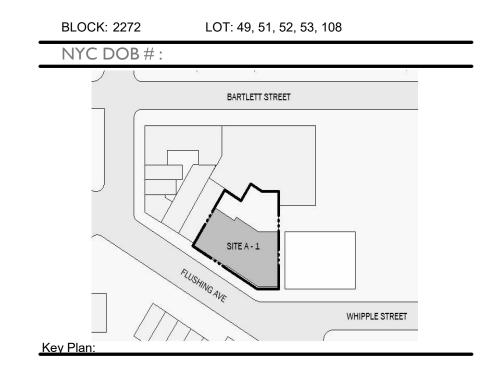

NUMBER DATE DESCRIPTION

Architect:

MAP

Magnusson Architecture & Planning PC

42 West 39th Street 15th Floor
New York NY 10018

Tel (212) 253 7820 Fax (212) 253 1276

Structural Engineer:
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Tel (631) 978-5000

MEP Engineer:

Landscape Architect:


Client Representative:

Filing Representative:

Contractor to promptly notify Architect of any material variations between field conditions and existing conditions as indicated in Contract documents

ROOF PLAN

SEAL & SIGNATURE:	PROJECT No:	19022
	DRAWING BY:	Author
	CHK BY:	Checker
	DWG No:	
	A-10)5.00

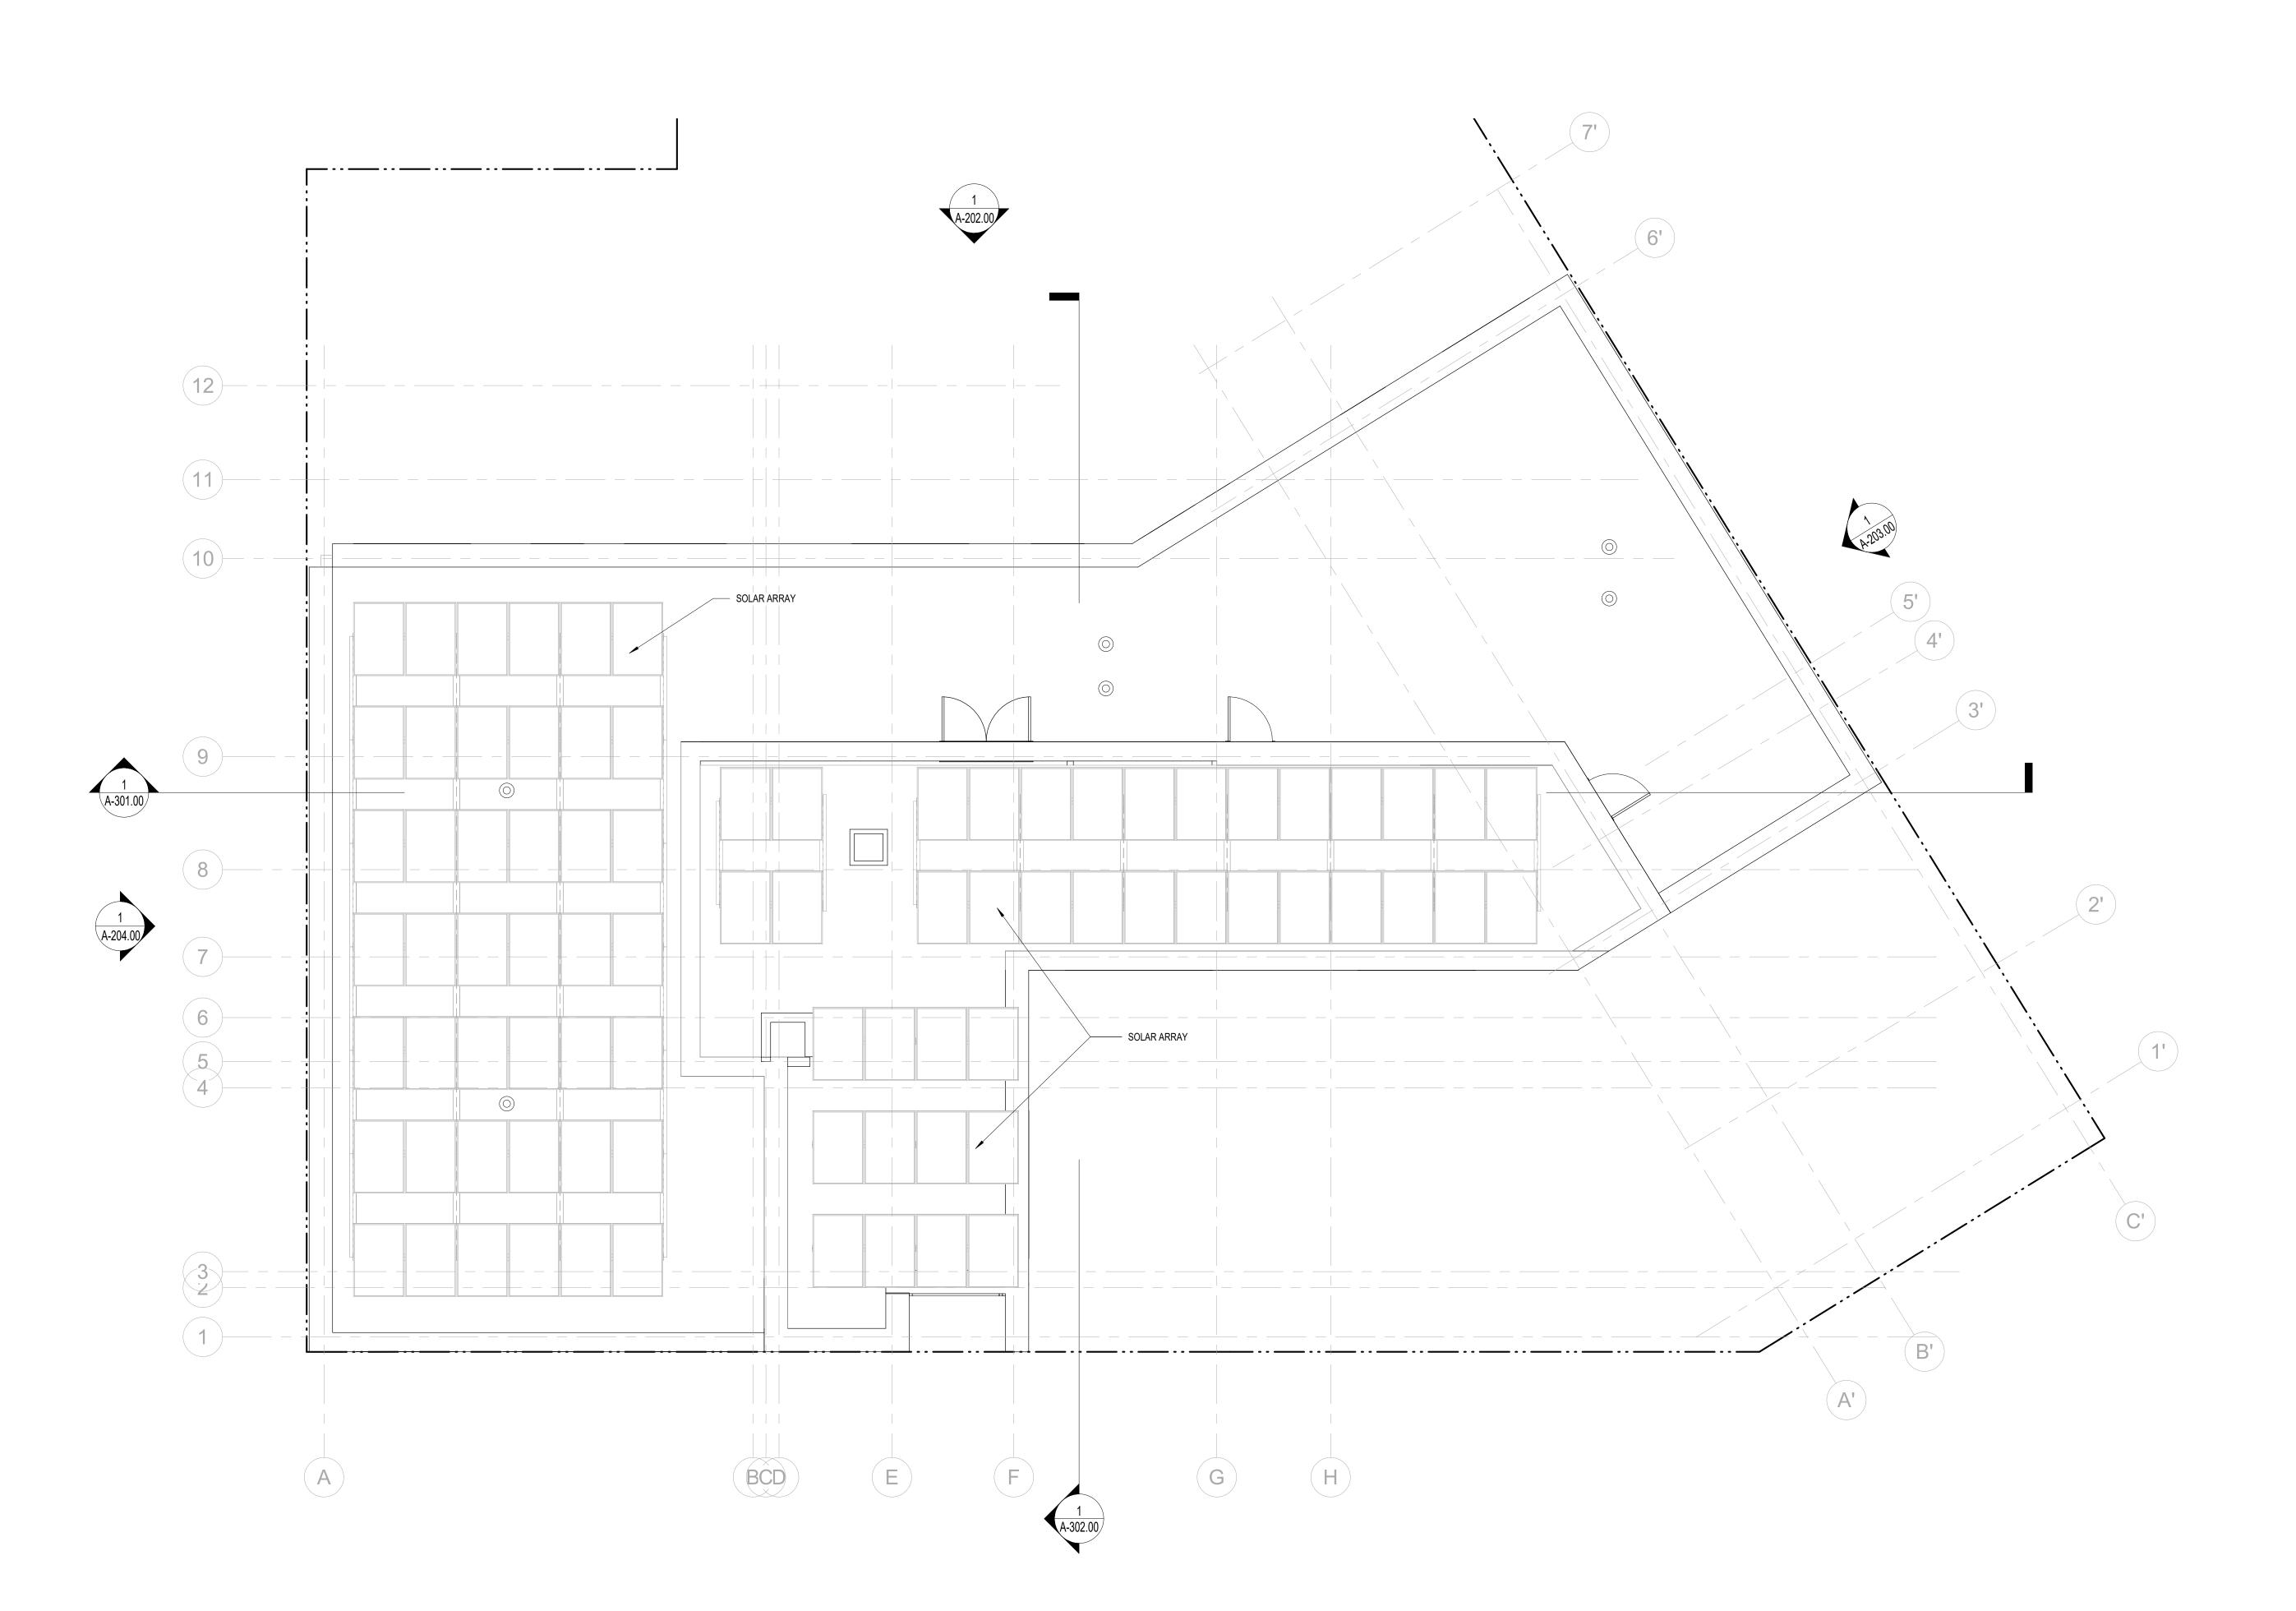

SITE A-1

665 FLUSHING AVE, BROOKLYN NY



BLOCK: 2272

NYC DOB#:

Architect:

Magnusson Architecture & Planning PC

42 West 39th Street 15th Floor New York NY 10018 Tel (212) 253 7820 Fax (212) 253 1276

Structural Engineer: CityScape Engineering 8 Haven Avenue, #209 Port Washington NY 11050 Tel (631) 978 5000 Fax (613) 978 0403

MEP Engineer: Loring Consulting Engineers 360 West 31st Street, New York NY 10001 Tel (646) 674 6100 Fax (212) 563 7382

Landscape Architect: Terrain-NYC 203 Lafayette Street, 5th Floor New York NY 10012 Tel (212) 537 6080


Client Representative:

Filing Representative:

Do Not Scale Plans Contractor to promptly notify Architect of any material variations between field conditions and existing conditions as indicated in Contract documents

BULKHEAD PLAN

SEAL & SIGNATURE: PROJECT No: 19022 DRAWING BY: Author CHK BY: DWG No:

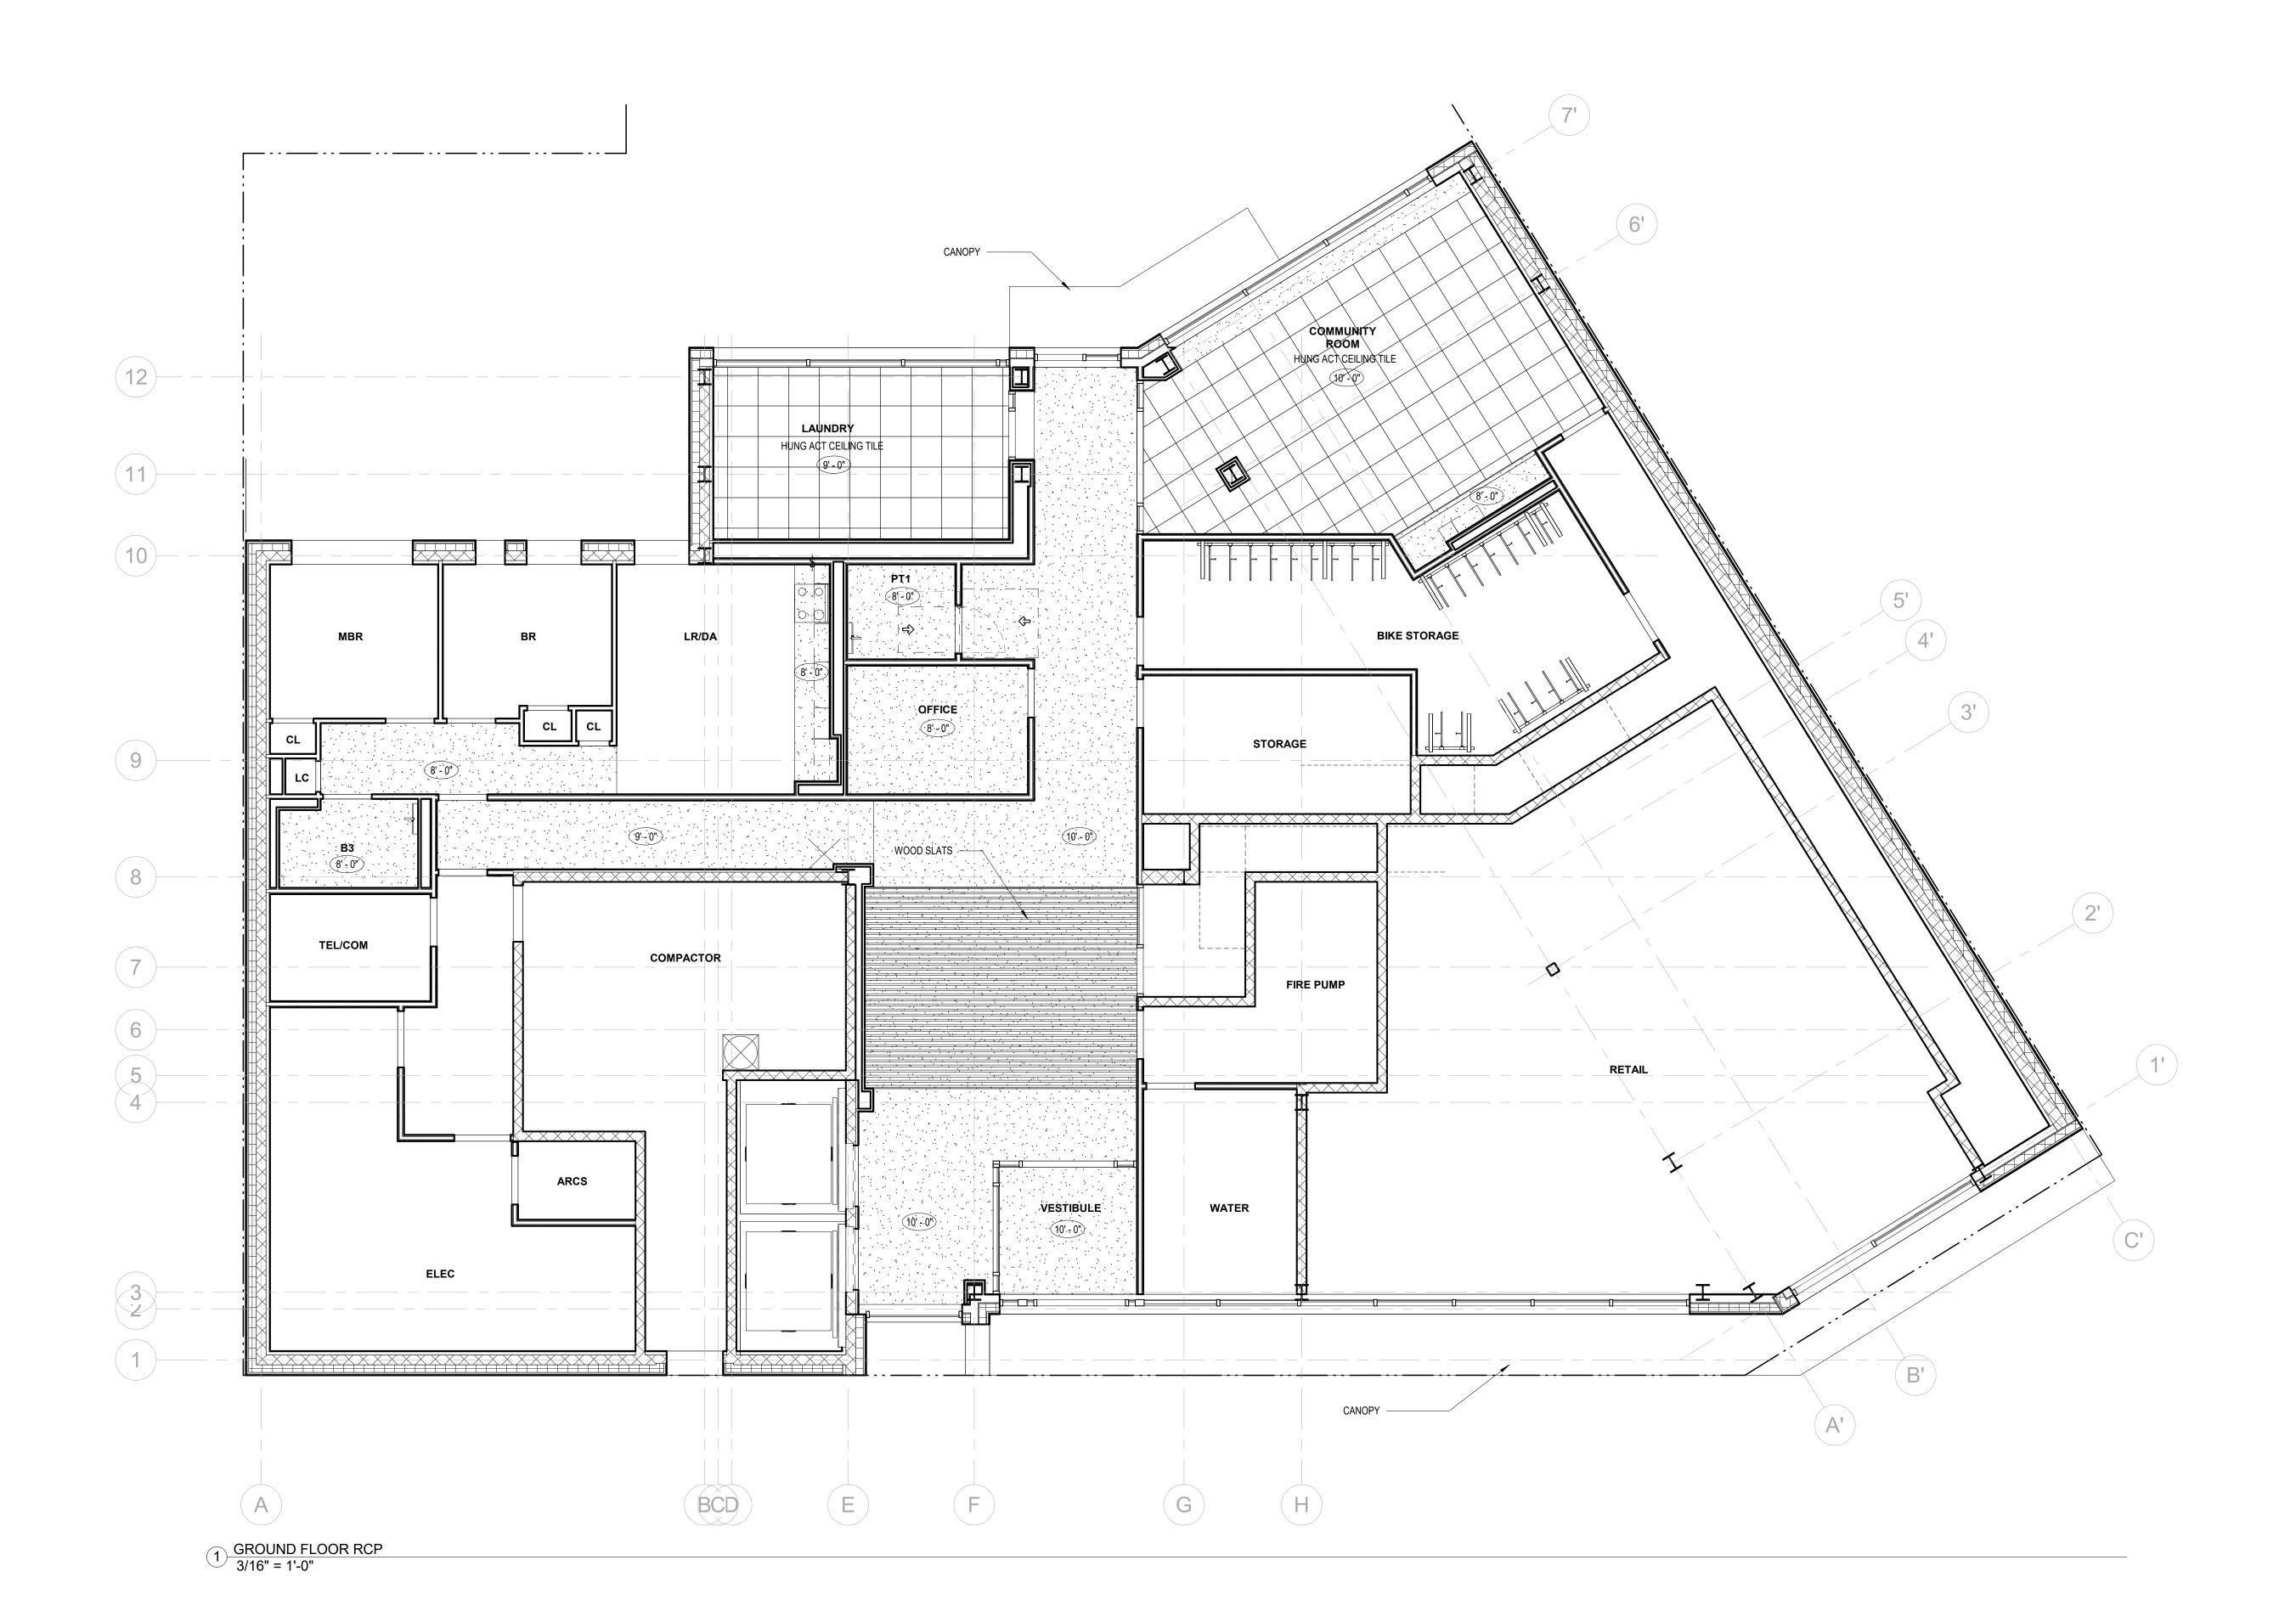

SITE A-1 665 FLUSHING AVE, BROOKLYN NY

Owner:



BLOCK: 2272 LOT

NYC DOB#:

Kev P

NUMBER DATE DESCRIPT

Revisi

Architect:

Magnusson Architecture & Planning PC

42 West 39th Street 15th Floor New York NY 10018 Tel (212) 253 7820 Fax (212) 253 1276

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Landscape Architect: Terrain-NYC 203 Lafayette Street, 5th Floor New York NY 10012 Tel (212) 537 6080

Client Representative:

Filing Representative:

Do Not Scale Plans Contractor to promptly notify Architect of any material variations between field conditions and existing conditions as indicated in Contract documents

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GROUND FLOOR RCP

SEAL & SIGNATURE:


PROJECT No: 19022

DRAWING BY: Author

CHK BY: Checker


DWG No:

A-121 00

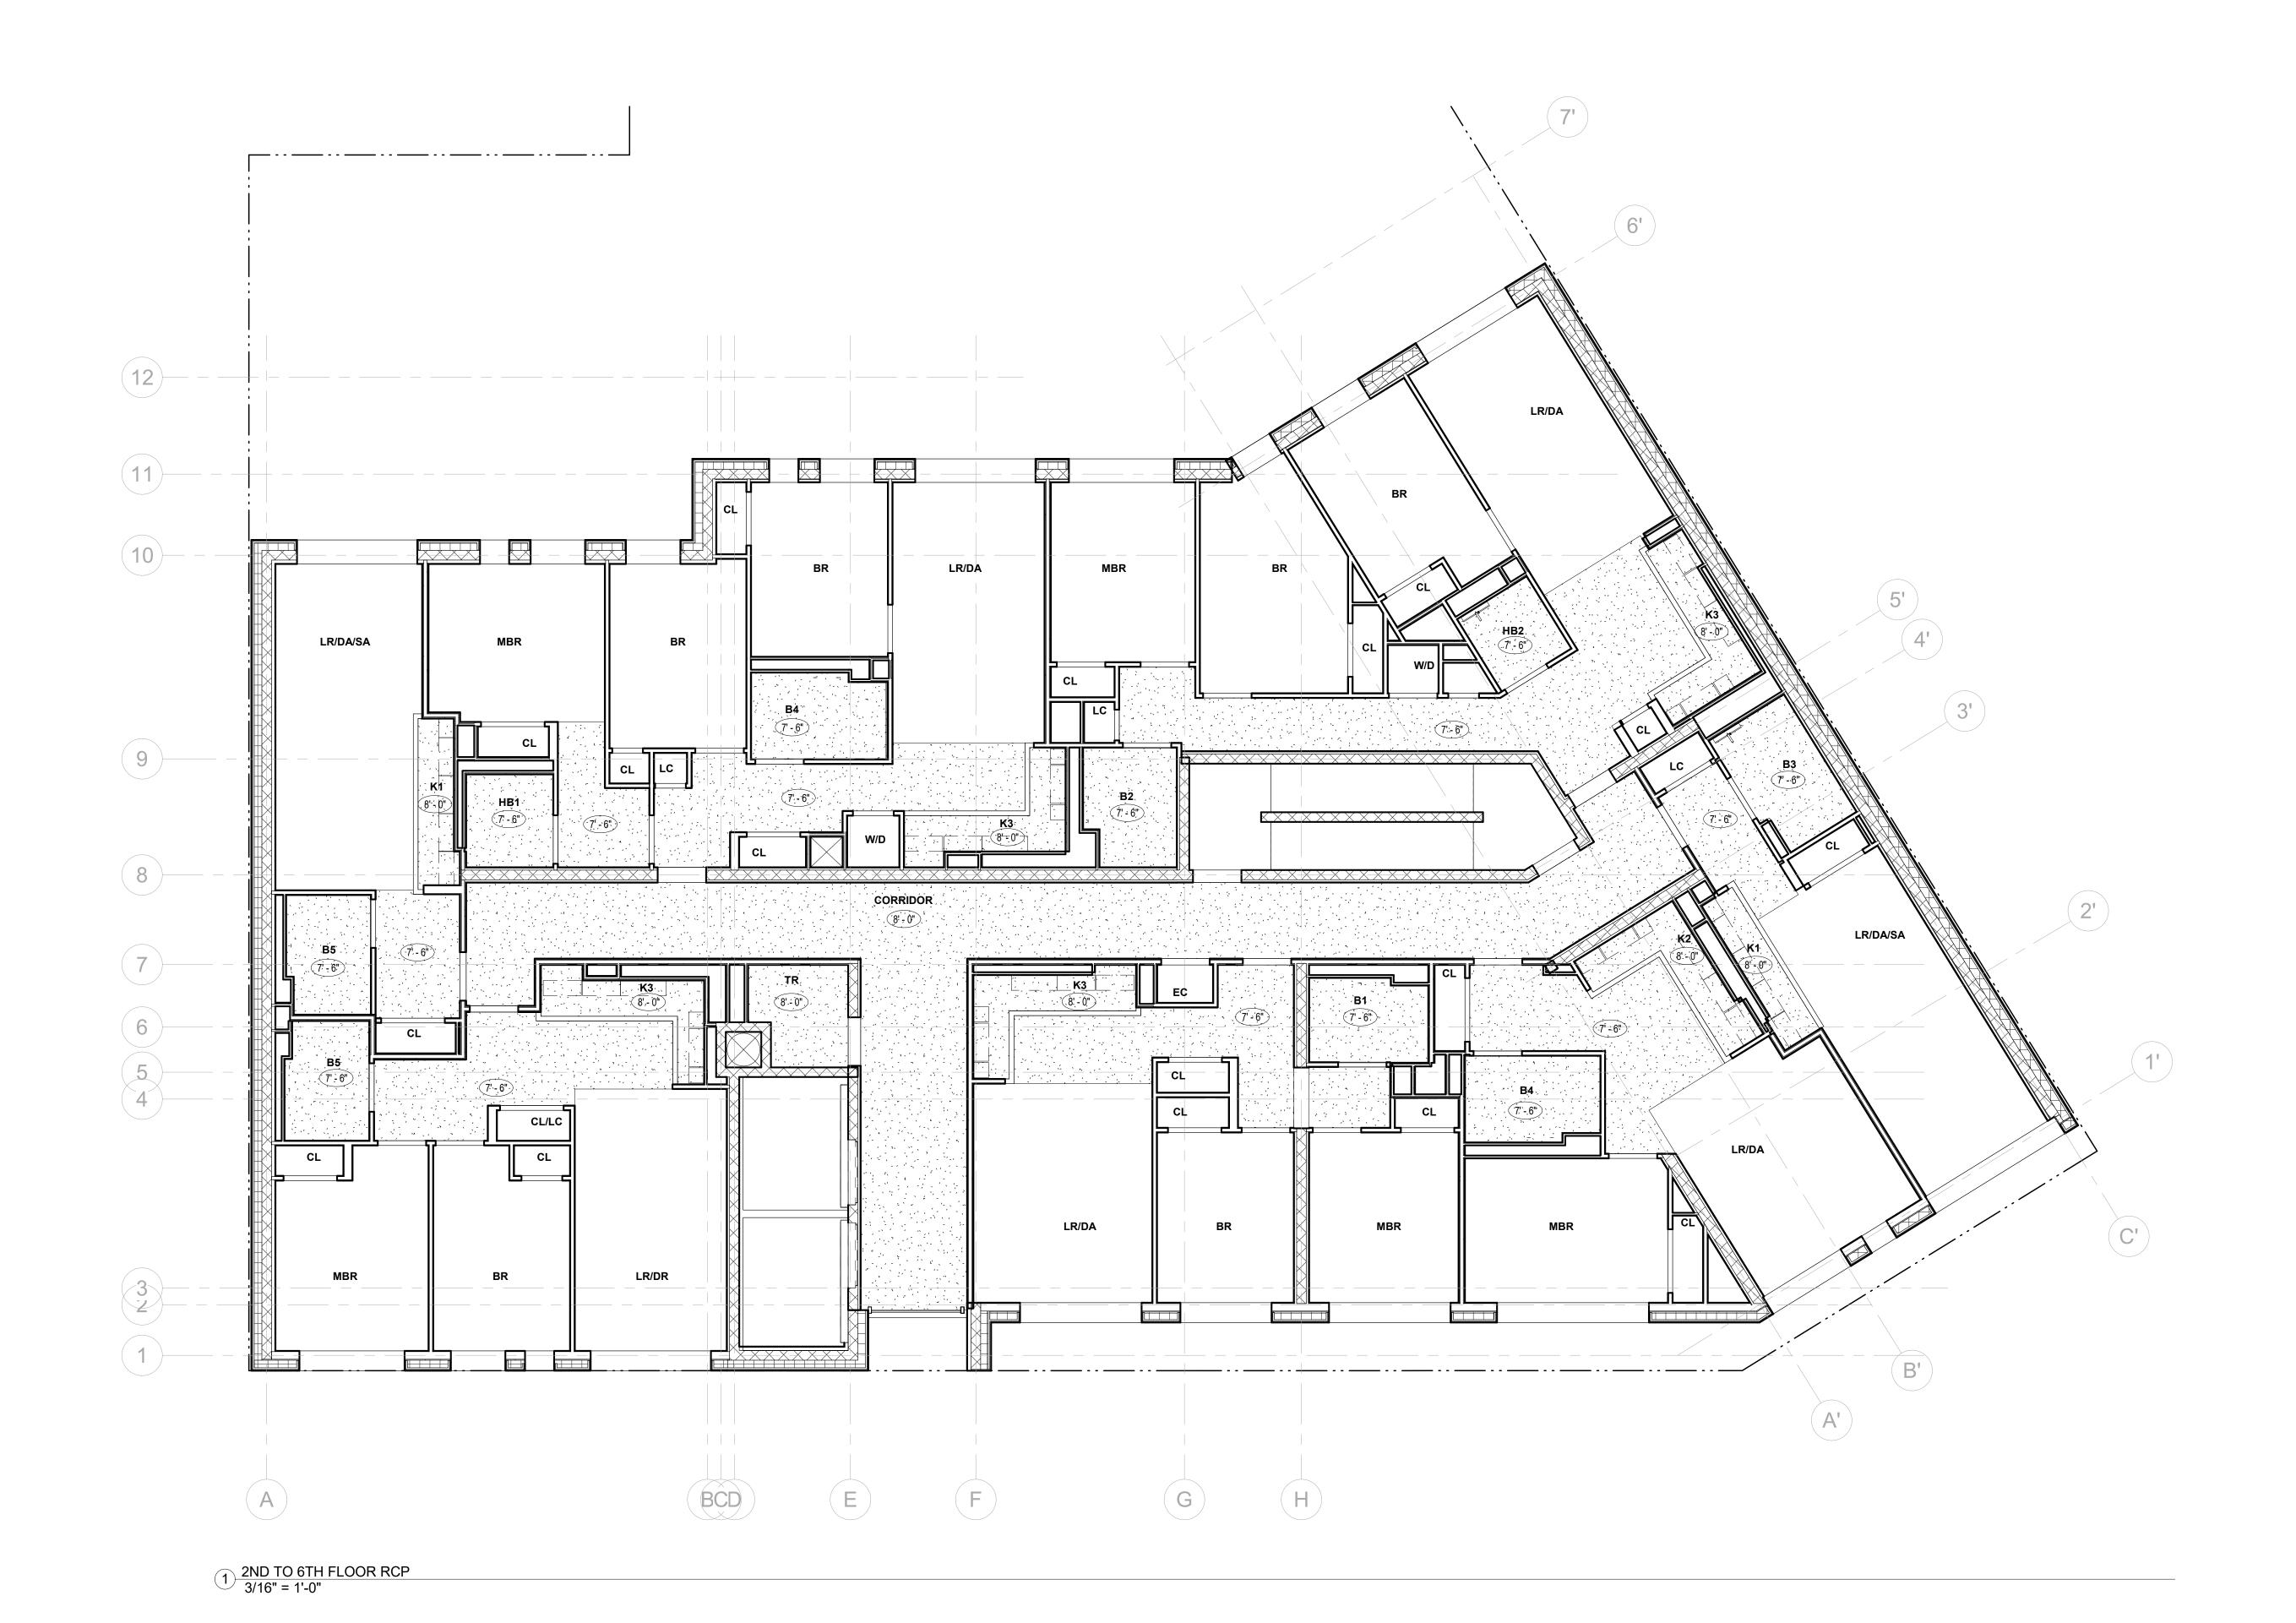

SITE A-1 665 FLUSHING AVE, BROOKLYN NY Owner:



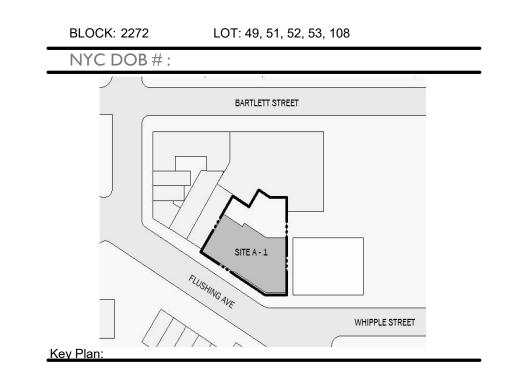

NUMBER DATE DESCRIPTION

Architect:

MAP

Magnusson Architecture & Planning PC

42 West 39th Street 15th Floor
New York NY 10018
Tel (212) 253 7820 Fax (212) 253 1276

Structural Engineer:
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8 Haven Ave., Port Washington NY 11050
Tel (631) 978-5000

MEP Engineer:

Landscape Architect:


Client Representative:

Filing Representative:

Do Not Scale Plans
Contractor to promptly notify Architect of any material variations between field conditions and existing conditions as indicated in Contract documents


2ND TO 6TH FLOOR RCP

SEAL & SIGNATURE:	PROJECT No: 19022
	DRAWING BY: Author
	CHK BY: Checker
	DWG No:
	A-122.00
	SCALE: 3/16" = 1'-0"

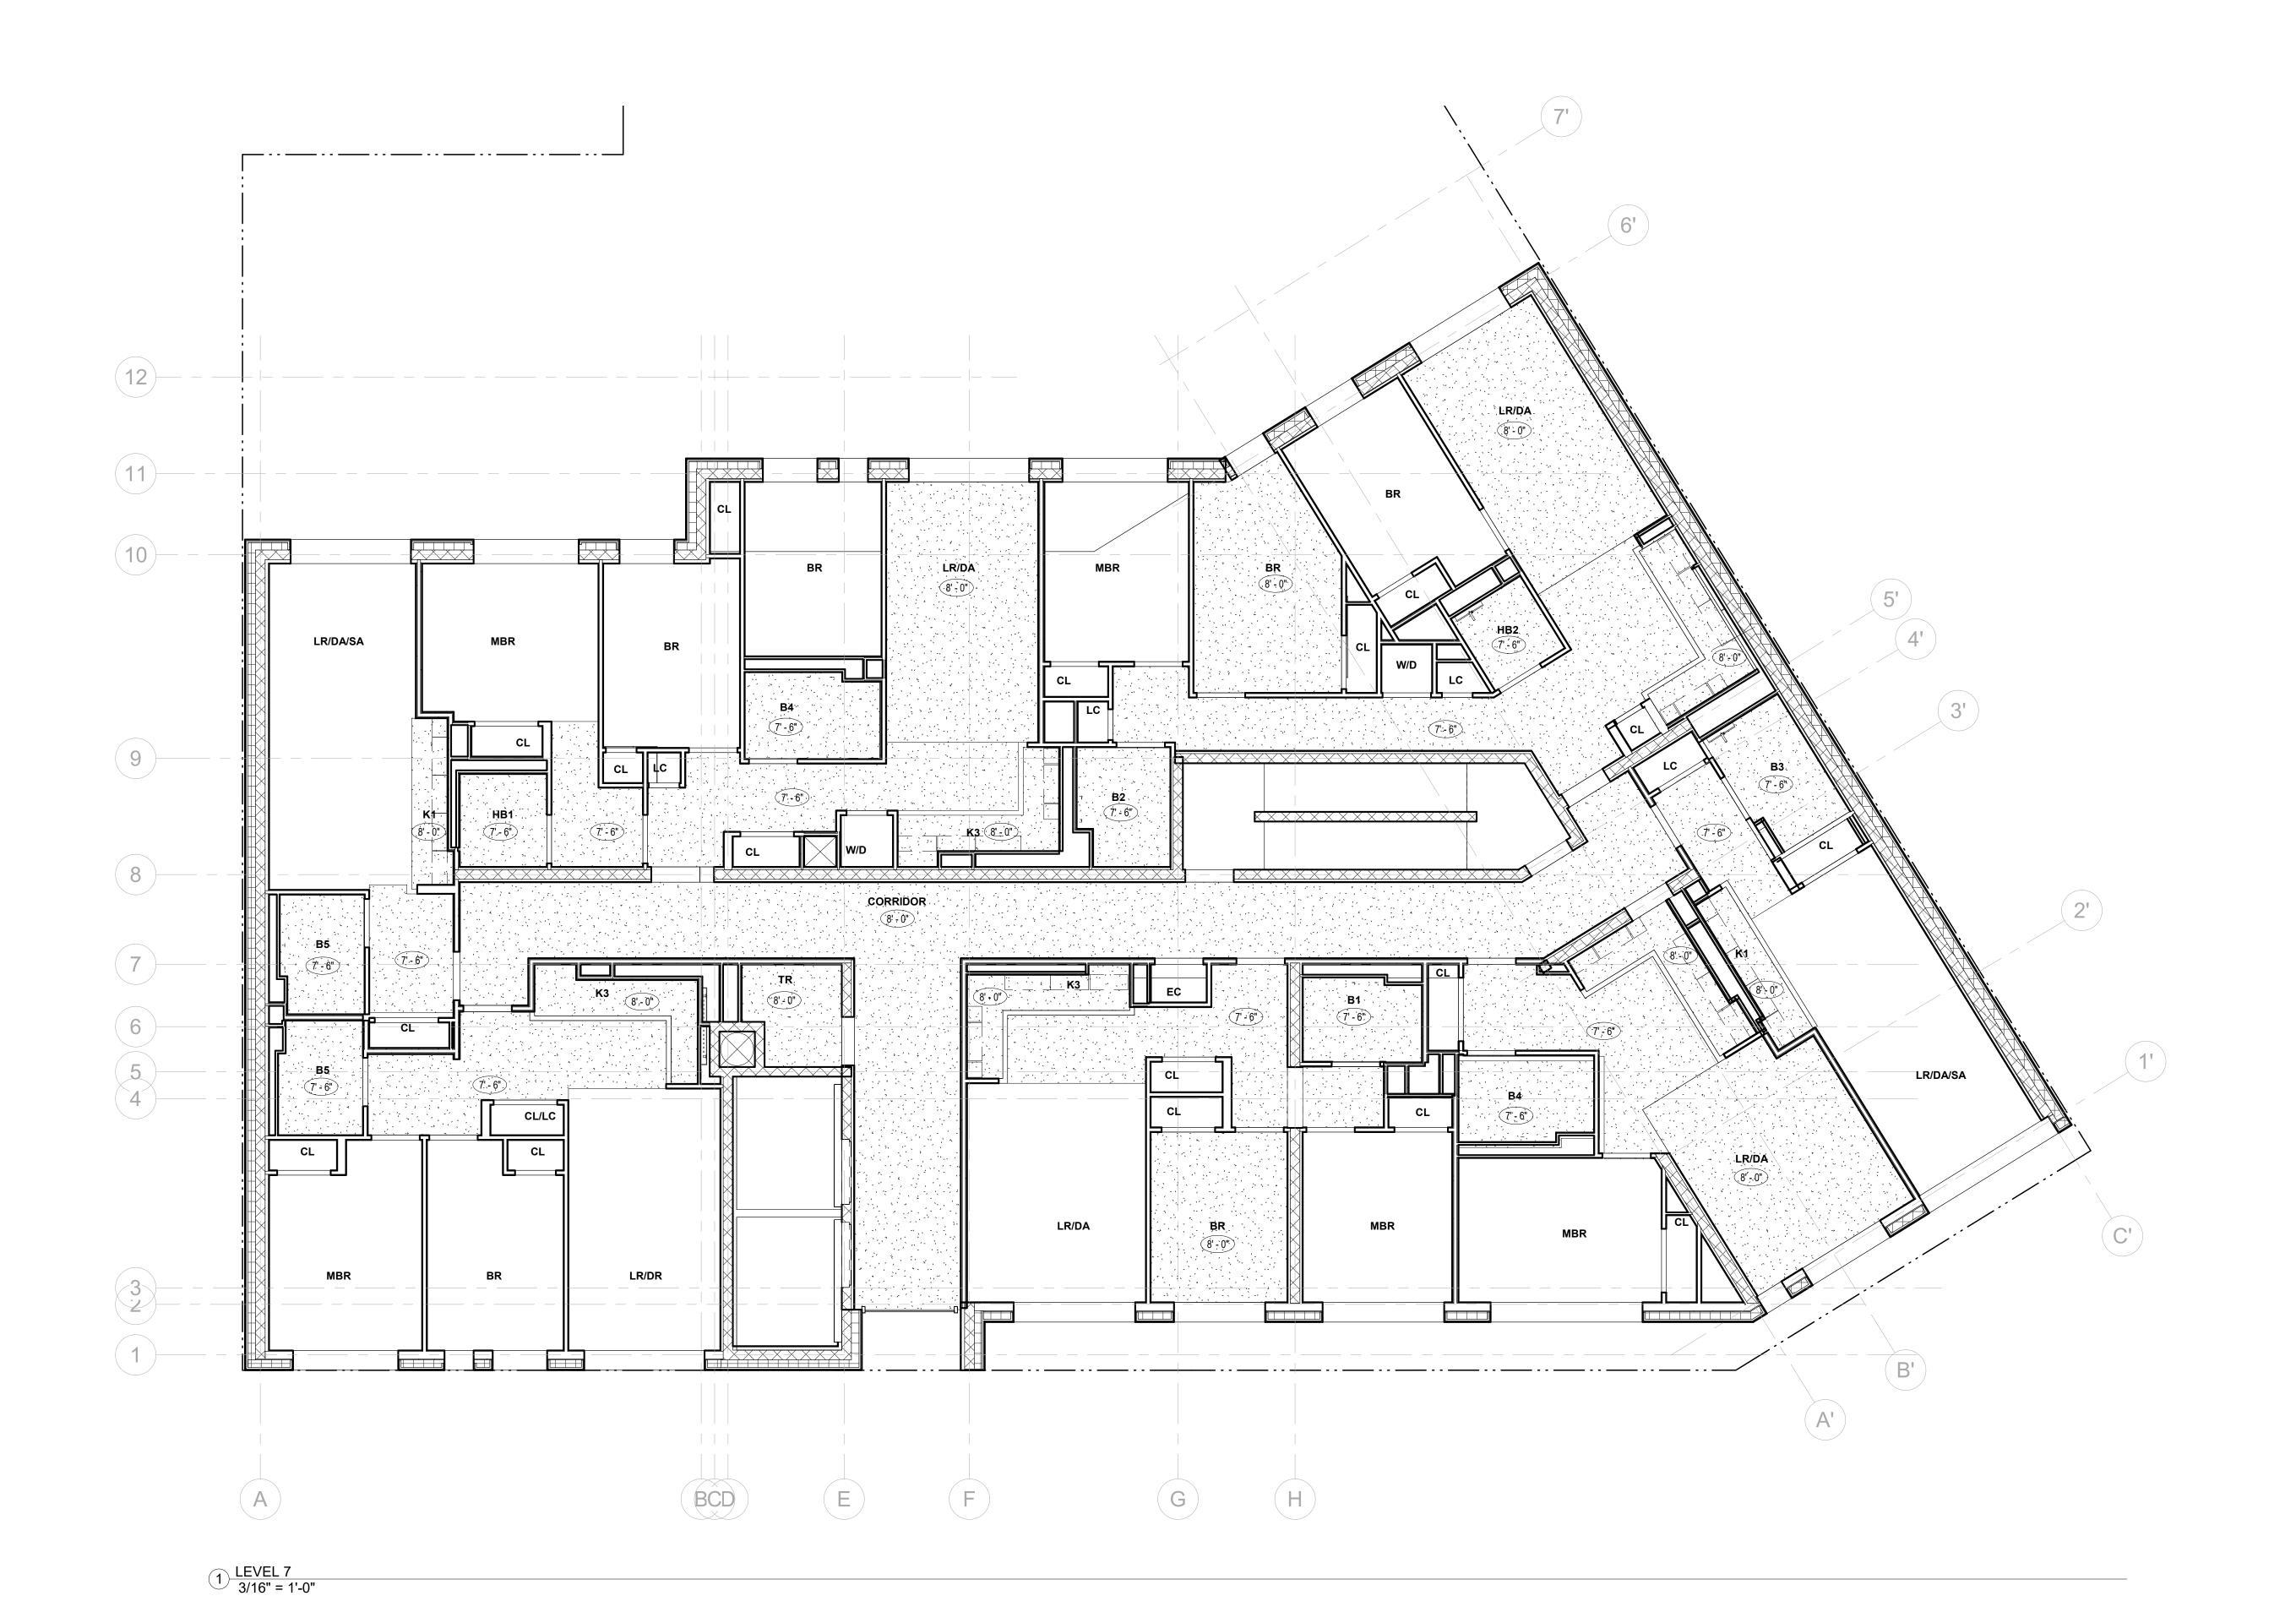

SITE A-1 665 FLUSHING AVE, BROOKLYN NY Owner:



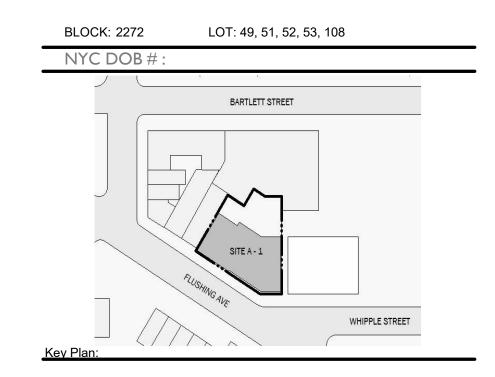

NUMBER DATE DESCRIPTION

Architect:

Magnusson Architecture & Planning PC

42 West 39th Street 15th Floor
New York NY 10018
Tel (212) 253 7820 Fax (212) 253 1276

Structural Engineer:
CityScape Engineering PLLC
8 Haven Ave., Port Washington NY 11050
Tel (631) 978-5000

MEP Engineer:


Landscape Architect:

Client Representative:

Do Not Scale Plans
Contractor to promptly notify Architect of any material variations between field conditions and existing conditions as indicated in Contract documents


7TH FLOOR RCP

SEAL & SIGNATURE:	PROJECT No: 19022
	DRAWING BY: Author
	CHK BY: Checker
	DWG No:
	A-123.00
	SCALE: 3/16" = 1'-0"

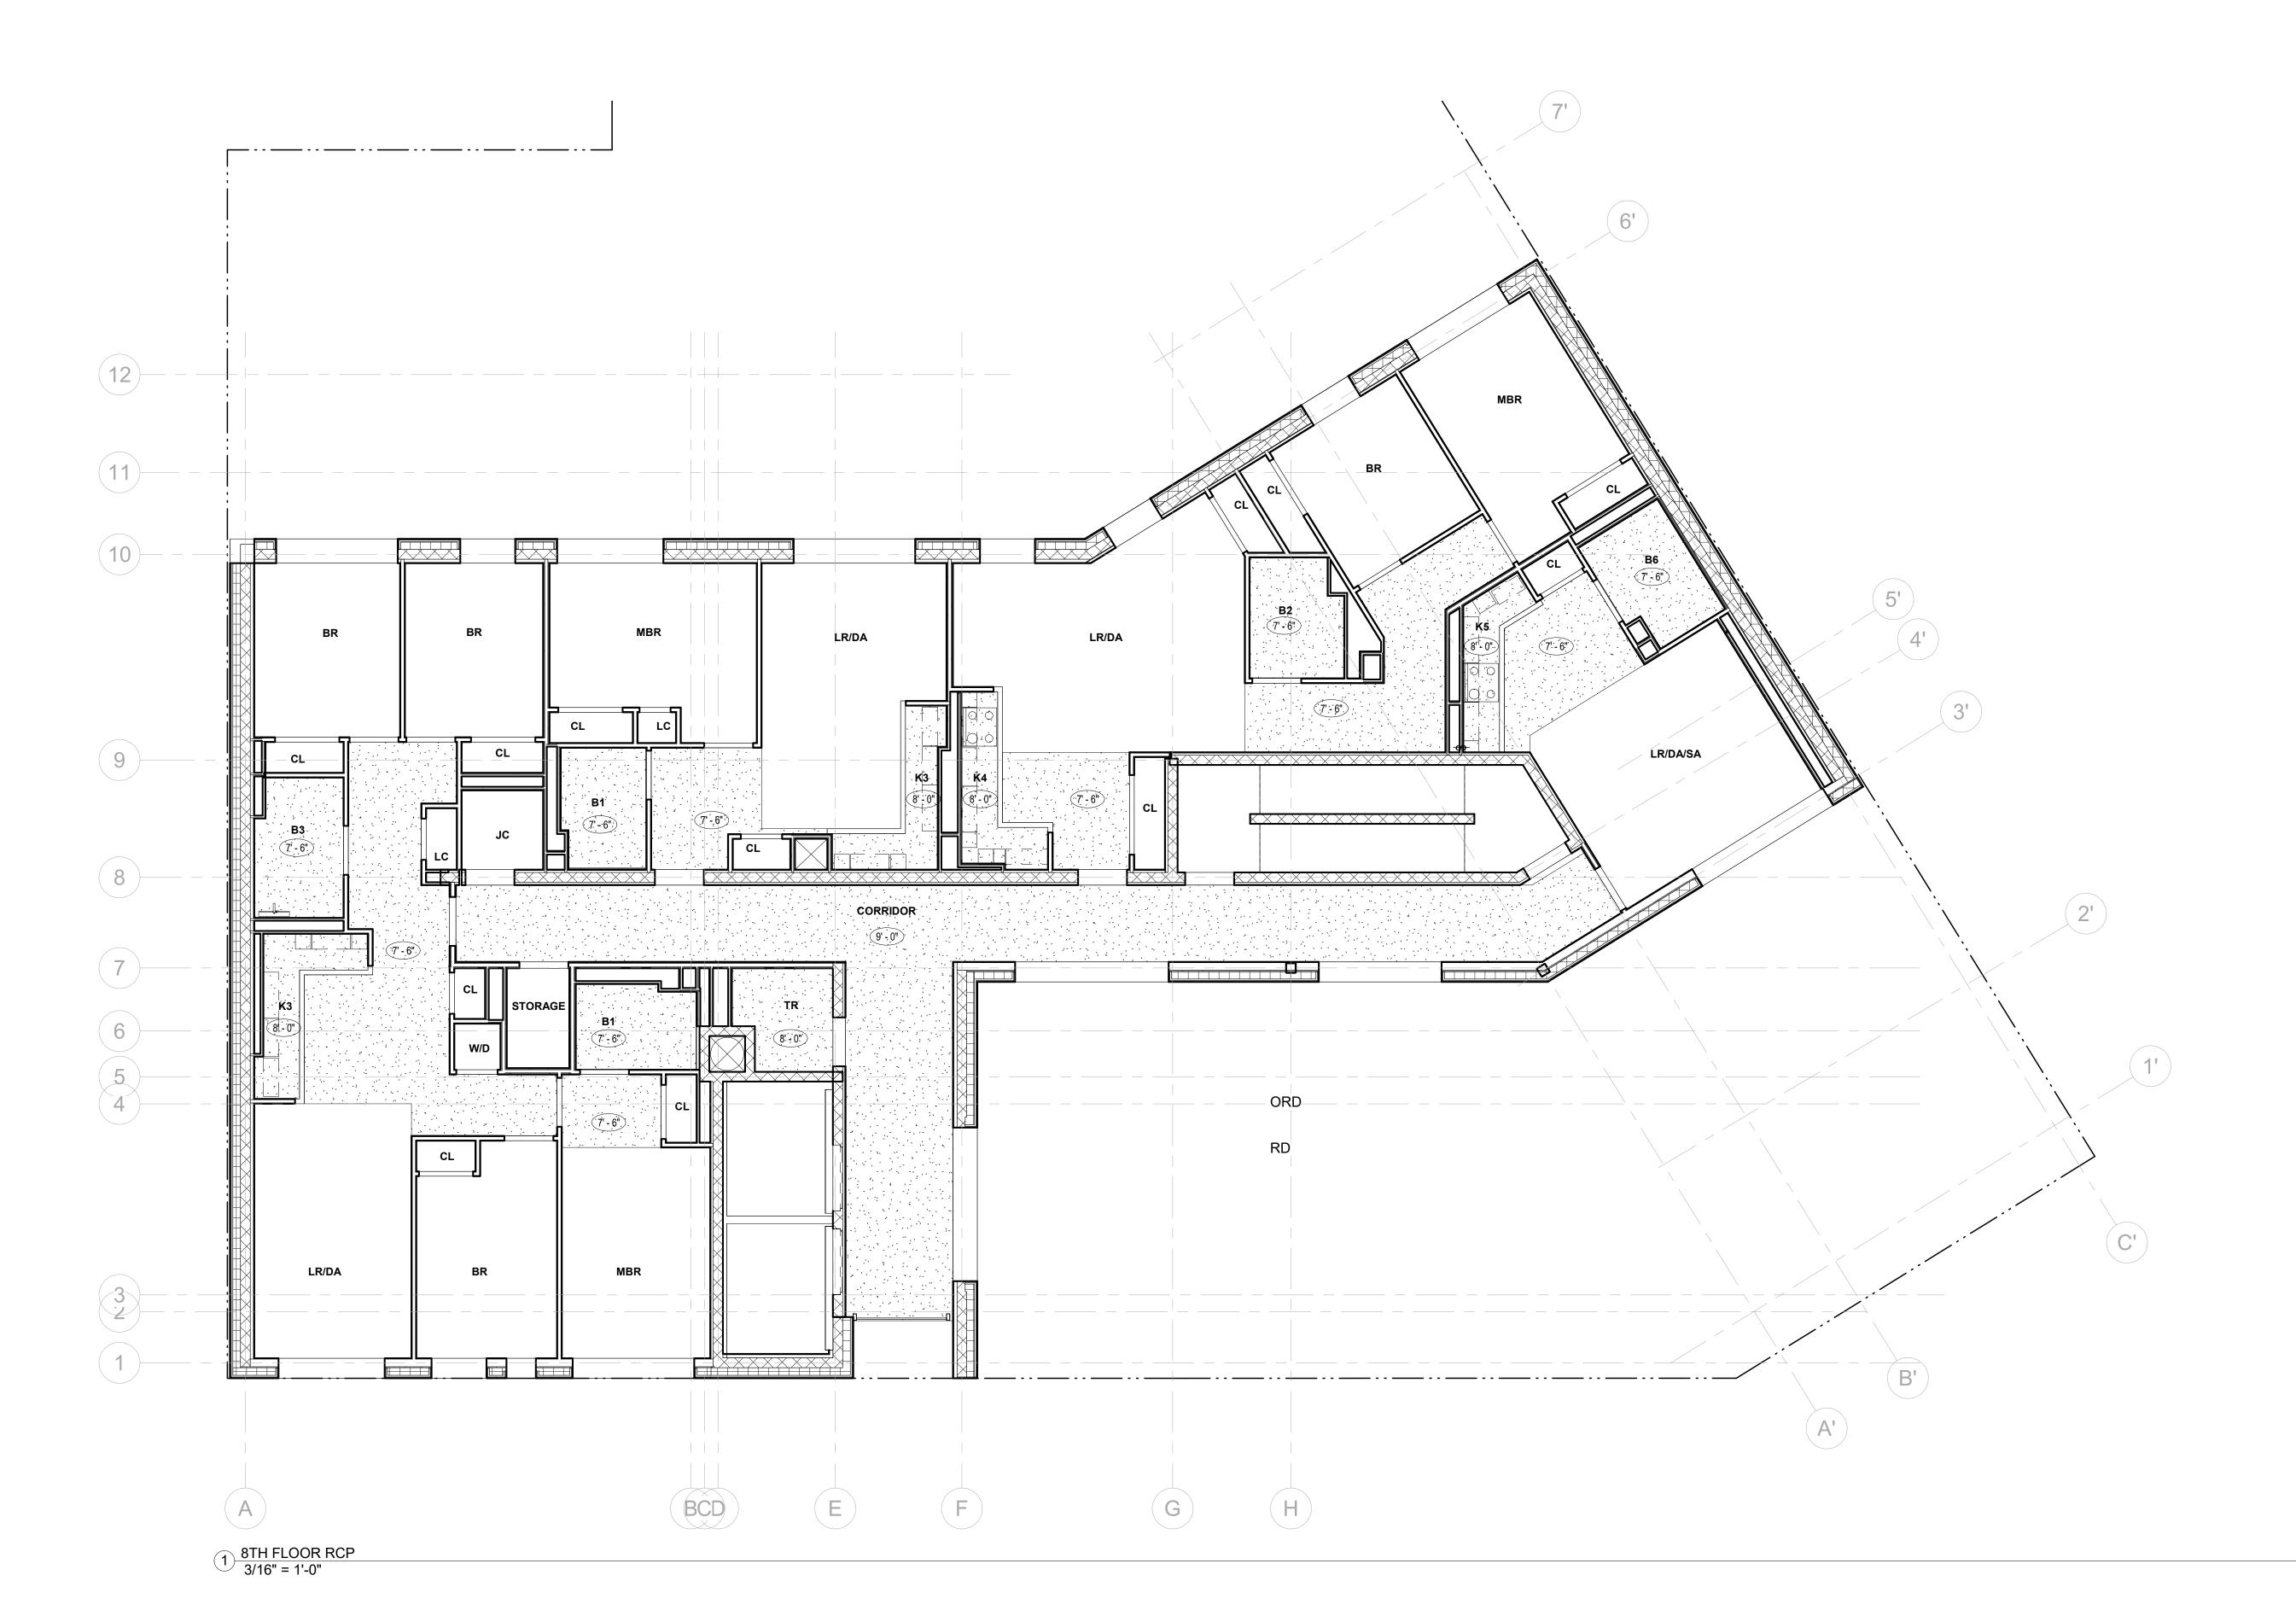

SITE A-1 665 FLUSHING AVE, BROOKLYN NY Owner:



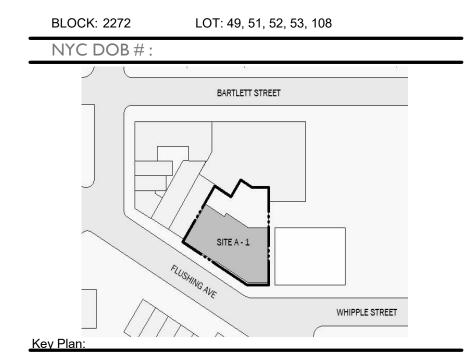

NUMBER DATE DESCRIPTION

MAP

Magnusson Architecture & Planning PC

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New York NY 10018
Tel (212) 253 7820 Fax (212) 253 1276

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Tel (631) 978-5000

MEP Engineer:

Landscape Architect:

Do Not Scale Plans
Contractor to promptly notify Architect of any material variations between field conditions and existing conditions as indicated in Contract documents

8TH FLOOR RCP

Client Representative:

Filing Representative:

SEAL & SIGNATURE:


PROJECT No: 19022

DRAWING BY: Author

CHK BY: Checker


DWG No:

A-124.00

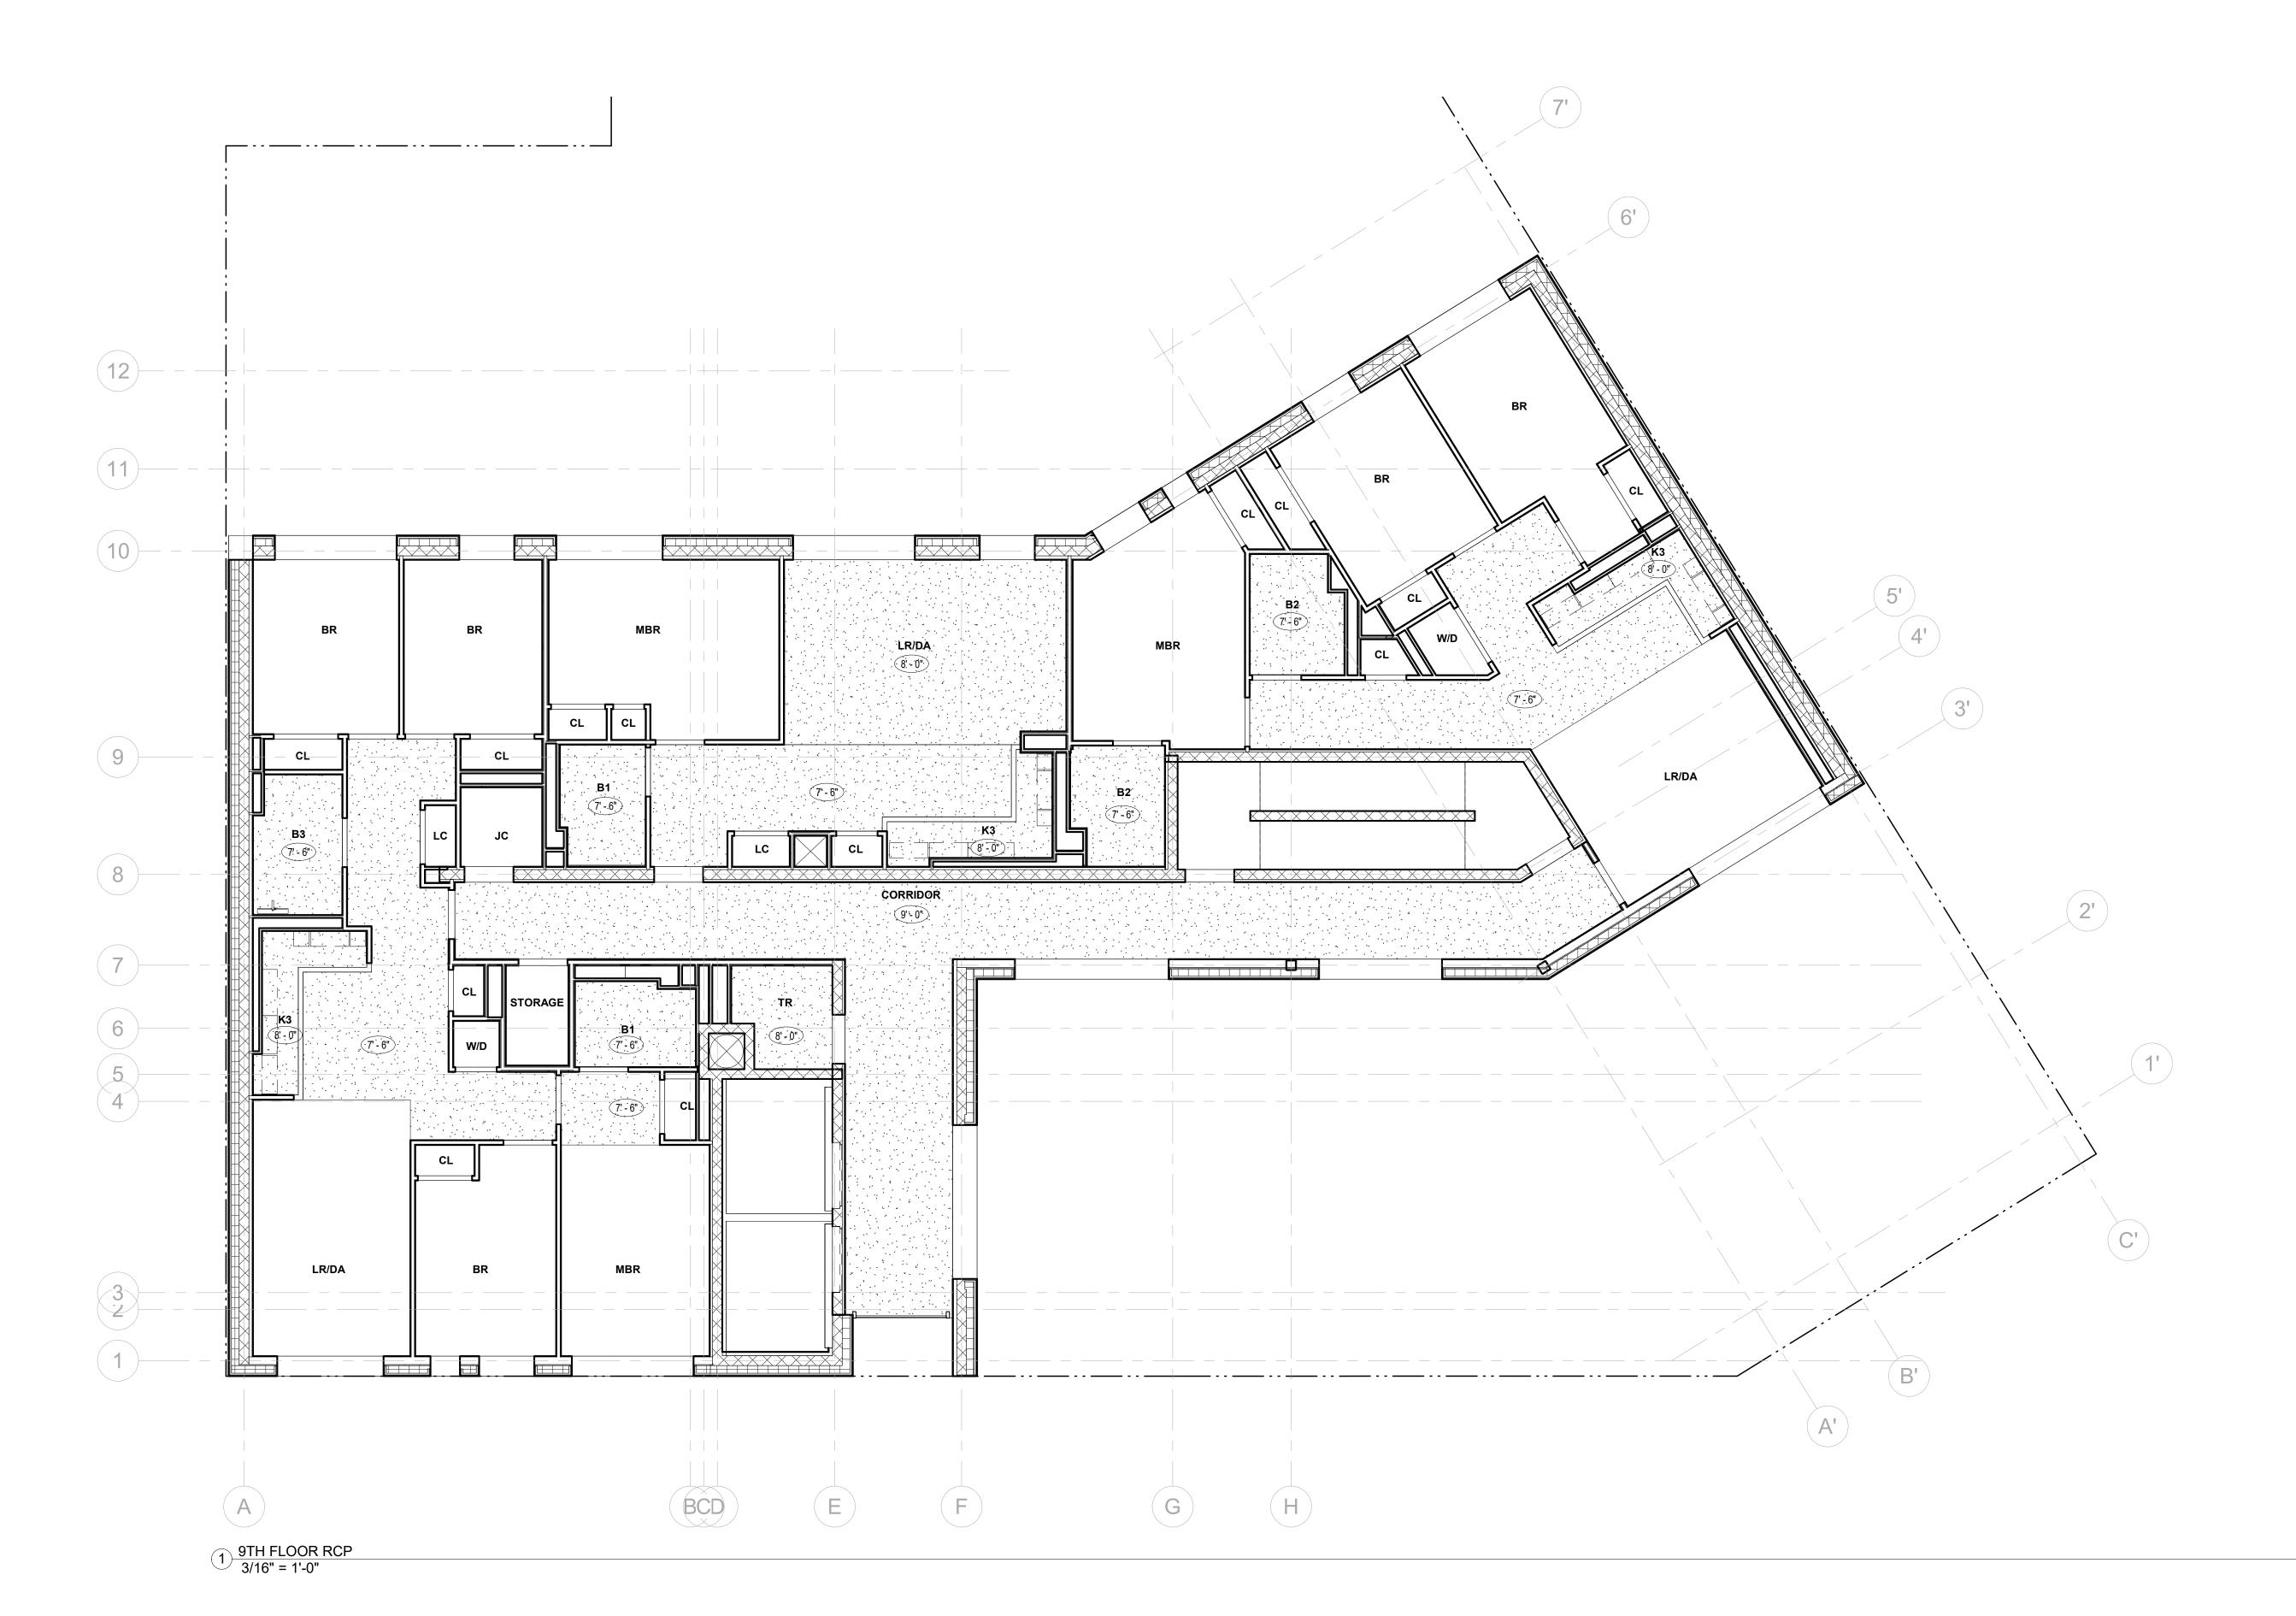

SITE A-1 665 FLUSHING AVE, BROOKLYN NY Owner:



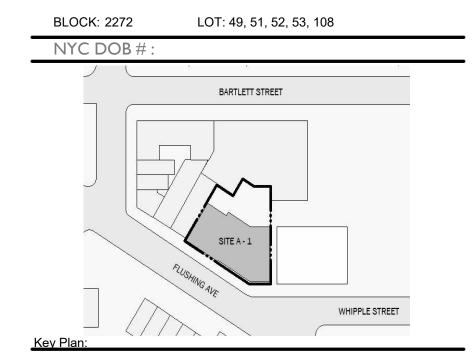

NUMBER DATE DESCRIPTION

Architect:

MAP

Magnusson Architecture & Planning PC

42 West 39th Street 15th Floor
New York NY 10018
Tel (212) 253 7820 Fax (212) 253 1276

Structural Engineer:
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Tel (631) 978-5000

MEP Engineer:

Client Representative:

Landscape Architect:

Filing Representative:

Do Not Scale Plans Contractor to promptly notify Architect of any material variations between field conditions and existing conditions as indicated in Contract documents

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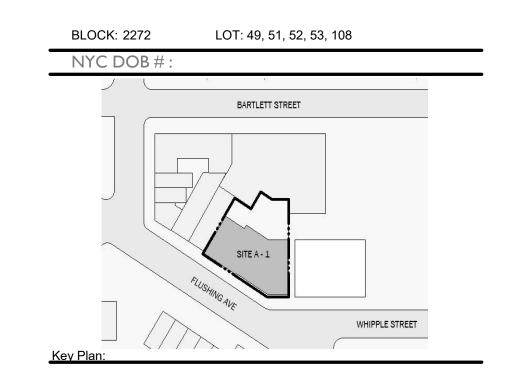
9TH FLOOR RCP

SEAL & SIGNATURE:	PROJECT No: 19022
	DRAWING BY: Author
	CHK BY: Checker
	DWG No:
	A-125.00
	SCALE: 3/16" = 1'-0"



SITE A-1 665 FLUSHING AVE, BROOKLYN NY





NUMBER DATE DESCRIPTION

Architect:

MAP

Magnusson Architecture & Planning PC

42 West 39th Street 15th Floor
New York NY 10018

Tel (212) 253 7820 Fax (212) 253 1276

Structural Engineer:
CityScape Engineering PLLC
8 Haven Ave., Port Washington NY 11050
Tel (631) 978-5000

MEP Engineer:

Landscape Architect:

Client Representative:

Filing Representative:

Do Not Scale Plans
Contractor to promptly notify Architect of any material variations between field conditions and existing conditions as indicated in Contract documents

SOUTH ELEVATION FLUSHING AVE

SEAL & SIGNATURE:	PROJECT No:	19022
	DRAWING BY:	Author
	CHK BY:	Checker
	DWG No:	
	A-20	01.00

SCALE: 1/8" = 1'-0"




1/8" = 1'-0"

BARTLETT CROSSING

SITE A-1 665 FLUSHING AVE, BROOKLYN NY



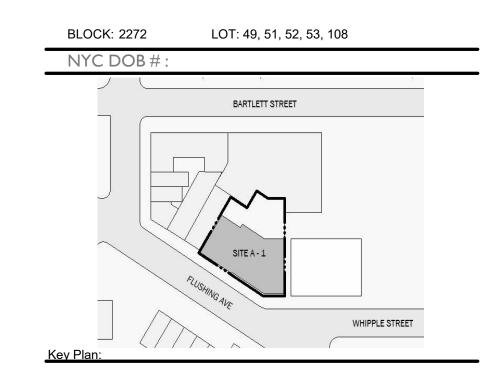

NUMBER DATE DESCRIPTION

Revisions:

Architect:

Magnusson Architecture & Planning PC

42 West 39th Street 15th Floor
New York NY 10018
Tel (212) 253 7820 Fax (212) 253 1276

Structural Engineer:
CityScape Engineering PLLC
8 Haven Ave., Port Washington NY 11050
Tel (631) 978-5000

MEP Engineer:

Landscape Architect:


Client Representative:

Filing Representative:

Do Not Scale Plans
Contractor to promptly notify Architect of any material variations between field conditions and existing conditions as indicated in Contract documents

NORTH ELEVATION

EAL & SIGNATURE:	PROJECT No:	19022
	DRAWING BY:	Author
	CHK BY:	Checker
	DWG No:	
	A-20	02.00
	SCALE: 1/8" = 1'-0"	

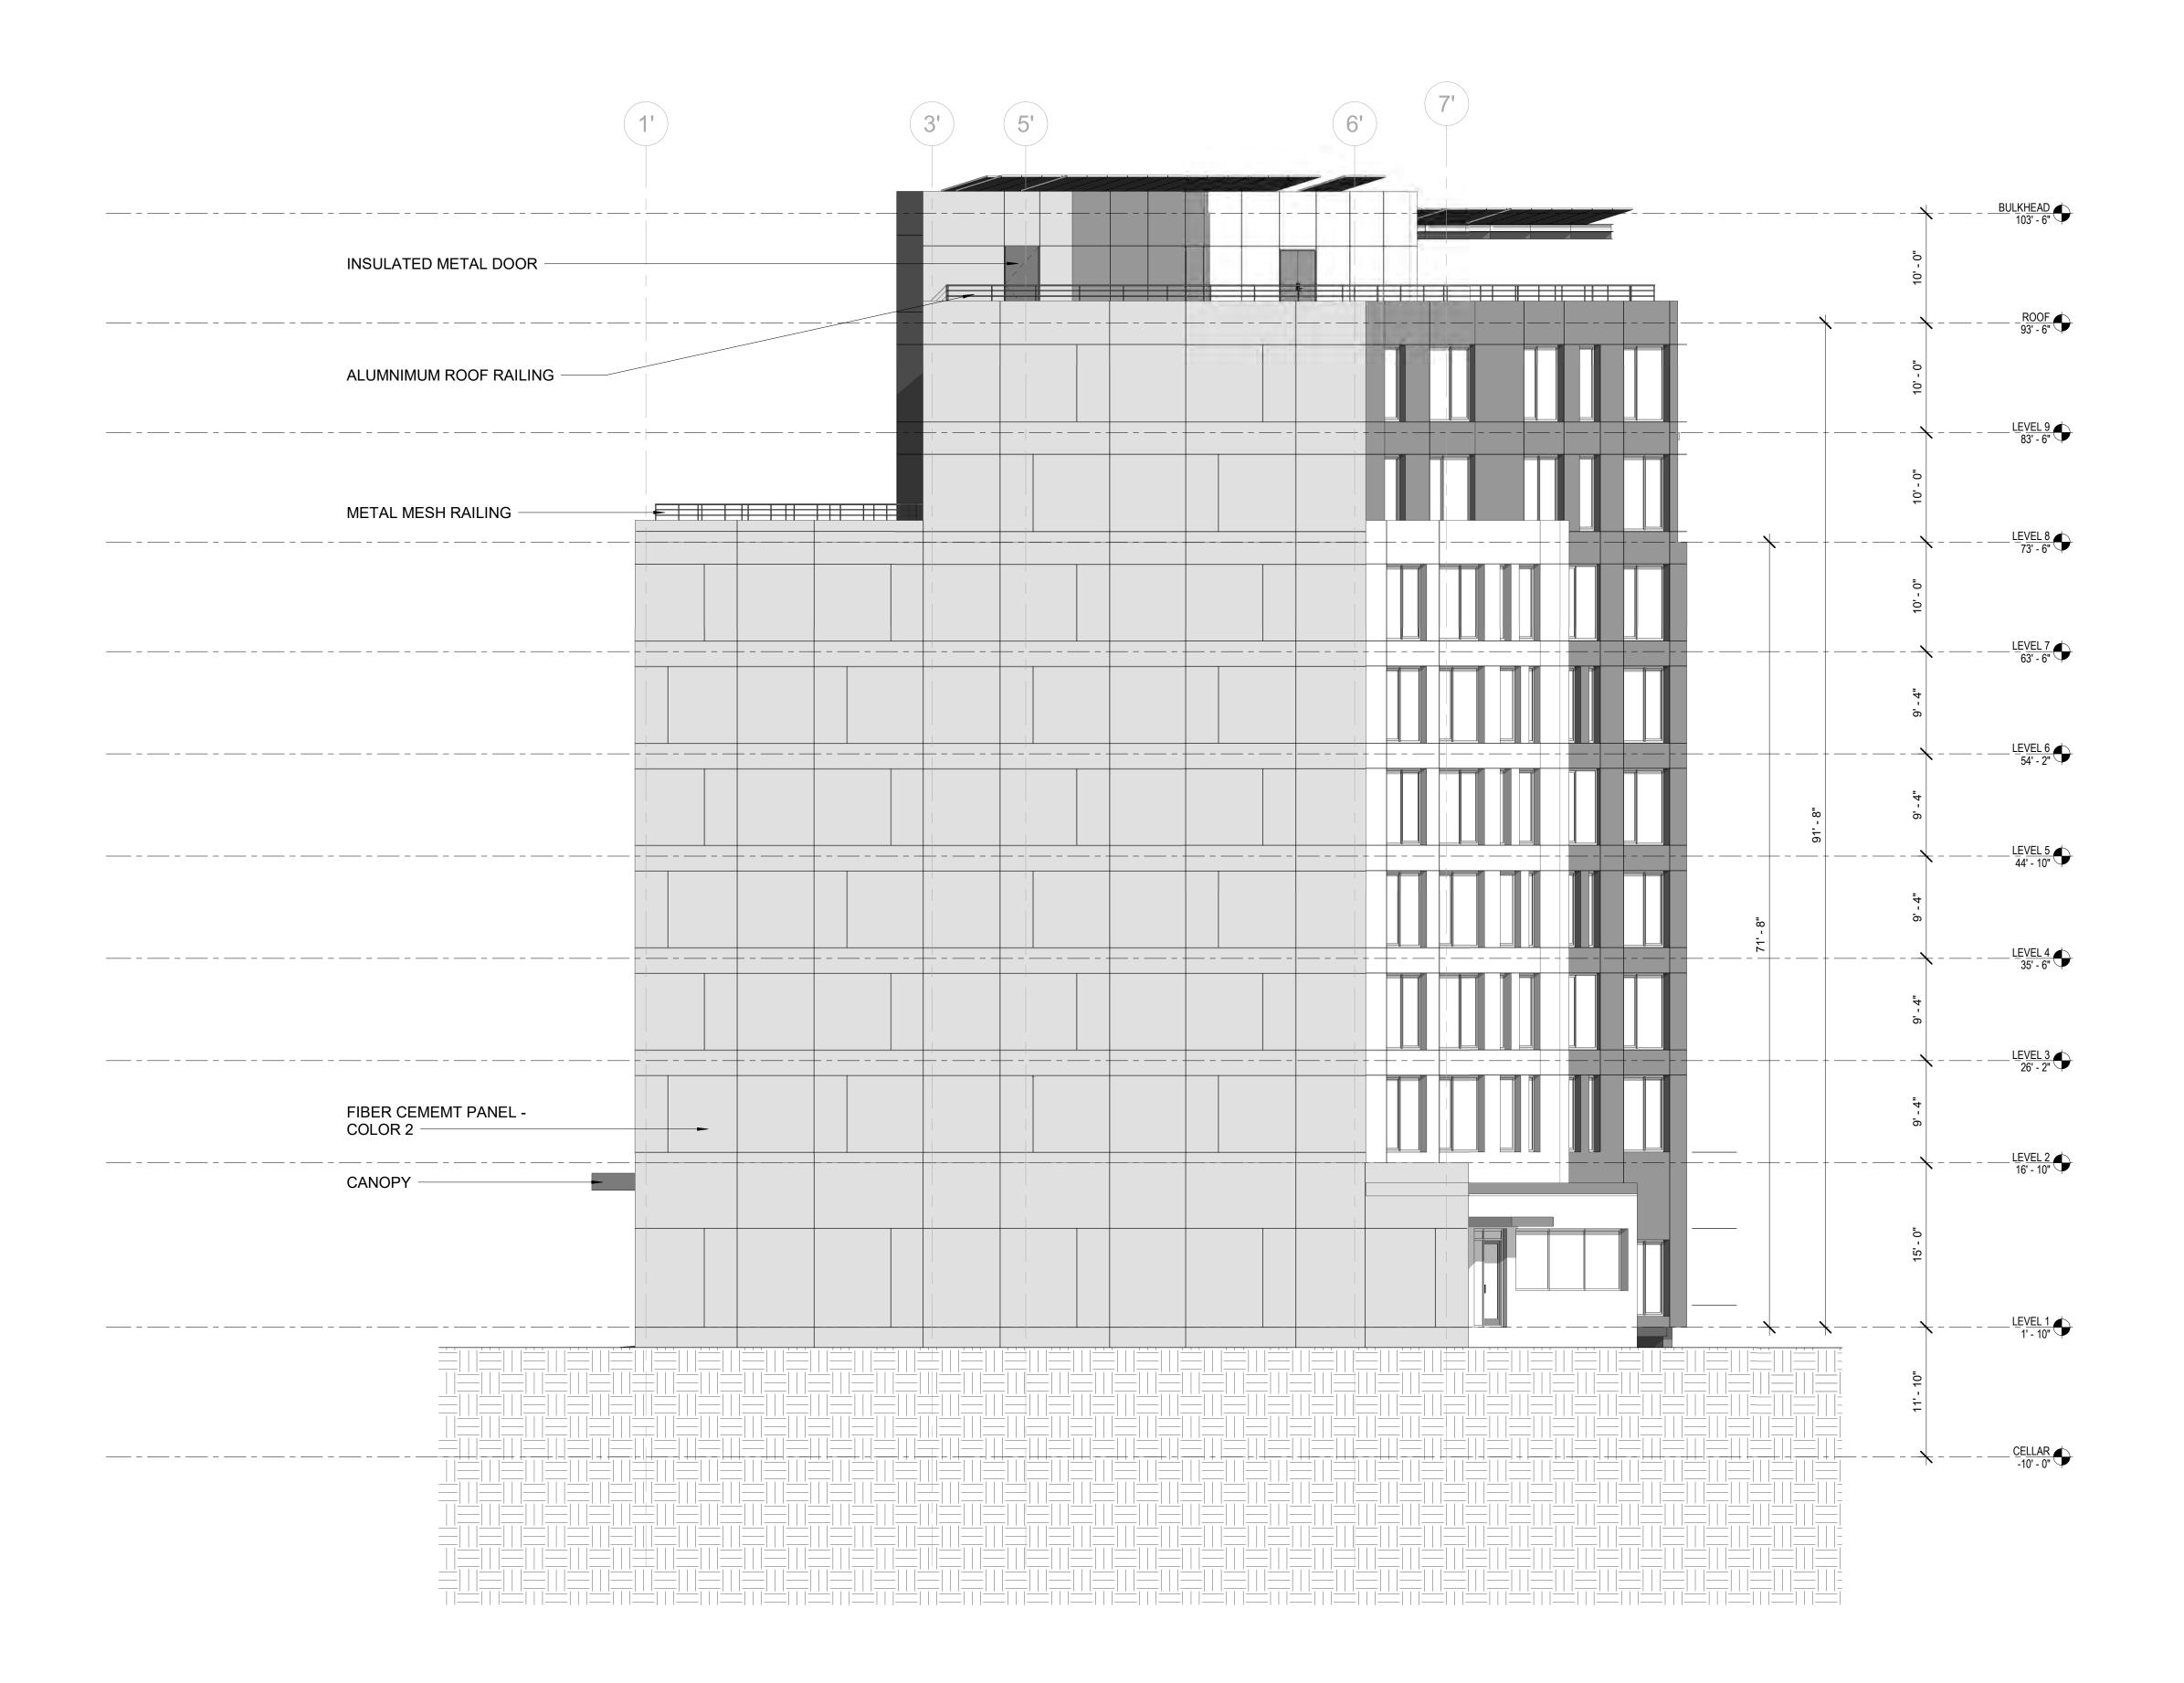

1 EAST ELEVATION 1/8" = 1'-0"

BARTLETT CROSSING

SITE A-1

665 FLUSHING AVE, BROOKLYN

Owner



BLOCK: 2272 LC

Brooklyn NY 11201 Tel (718) 388 5454

NYC DOB#:

Key P

NUMBER DATE DESCRIPT

Revis

Architect:

Magnusson Architecture & Planning PC

42 West 39th Street 15th Floor New York NY 10018 Tel (212) 253 7820 Fax (212) 253 1276

Structural Engineer: CityScape Engineering 8 Haven Avenue, #209 Port Washington NY 11050

Tel (631) 978 5000 Fax (613) 978 0403

MEP Engineer: Loring Consulting Engineers 360 West 31st Street,

360 West 31st Street, New York NY 10001 Tel (646) 674 6100 Fax (212) 563 7382

Landscape Architect: Terrain-NYC 203 Lafayette Street, 5th Floor New York NY 10012

Tel (212) 537 6080

Client Representative:

Filing Representative:


Do Not Scale Plans
Contractor to promptly notify Architect of any material variations between field conditions and existing conditions as indicated in Contract documents

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EAST ELEVATION

DRAWING BY: Author CHK BY: Checker DWG No:		\ \ \ \ \ \ \ \ \ \ \ \ \ \ \ \ \ \ \	72 00
DRAWING BY: Author		DWG No:	
		CHK BY:	Checker
AL & SIGNATURE. PROJECT NO. 19022		DRAWING BY:	Author
AL 9 SIGNATURE: DRO JECT No. 10022	AL & SIGNATURE:	PROJECT No:	19022

SCALE: 1/8" = 1'-0"

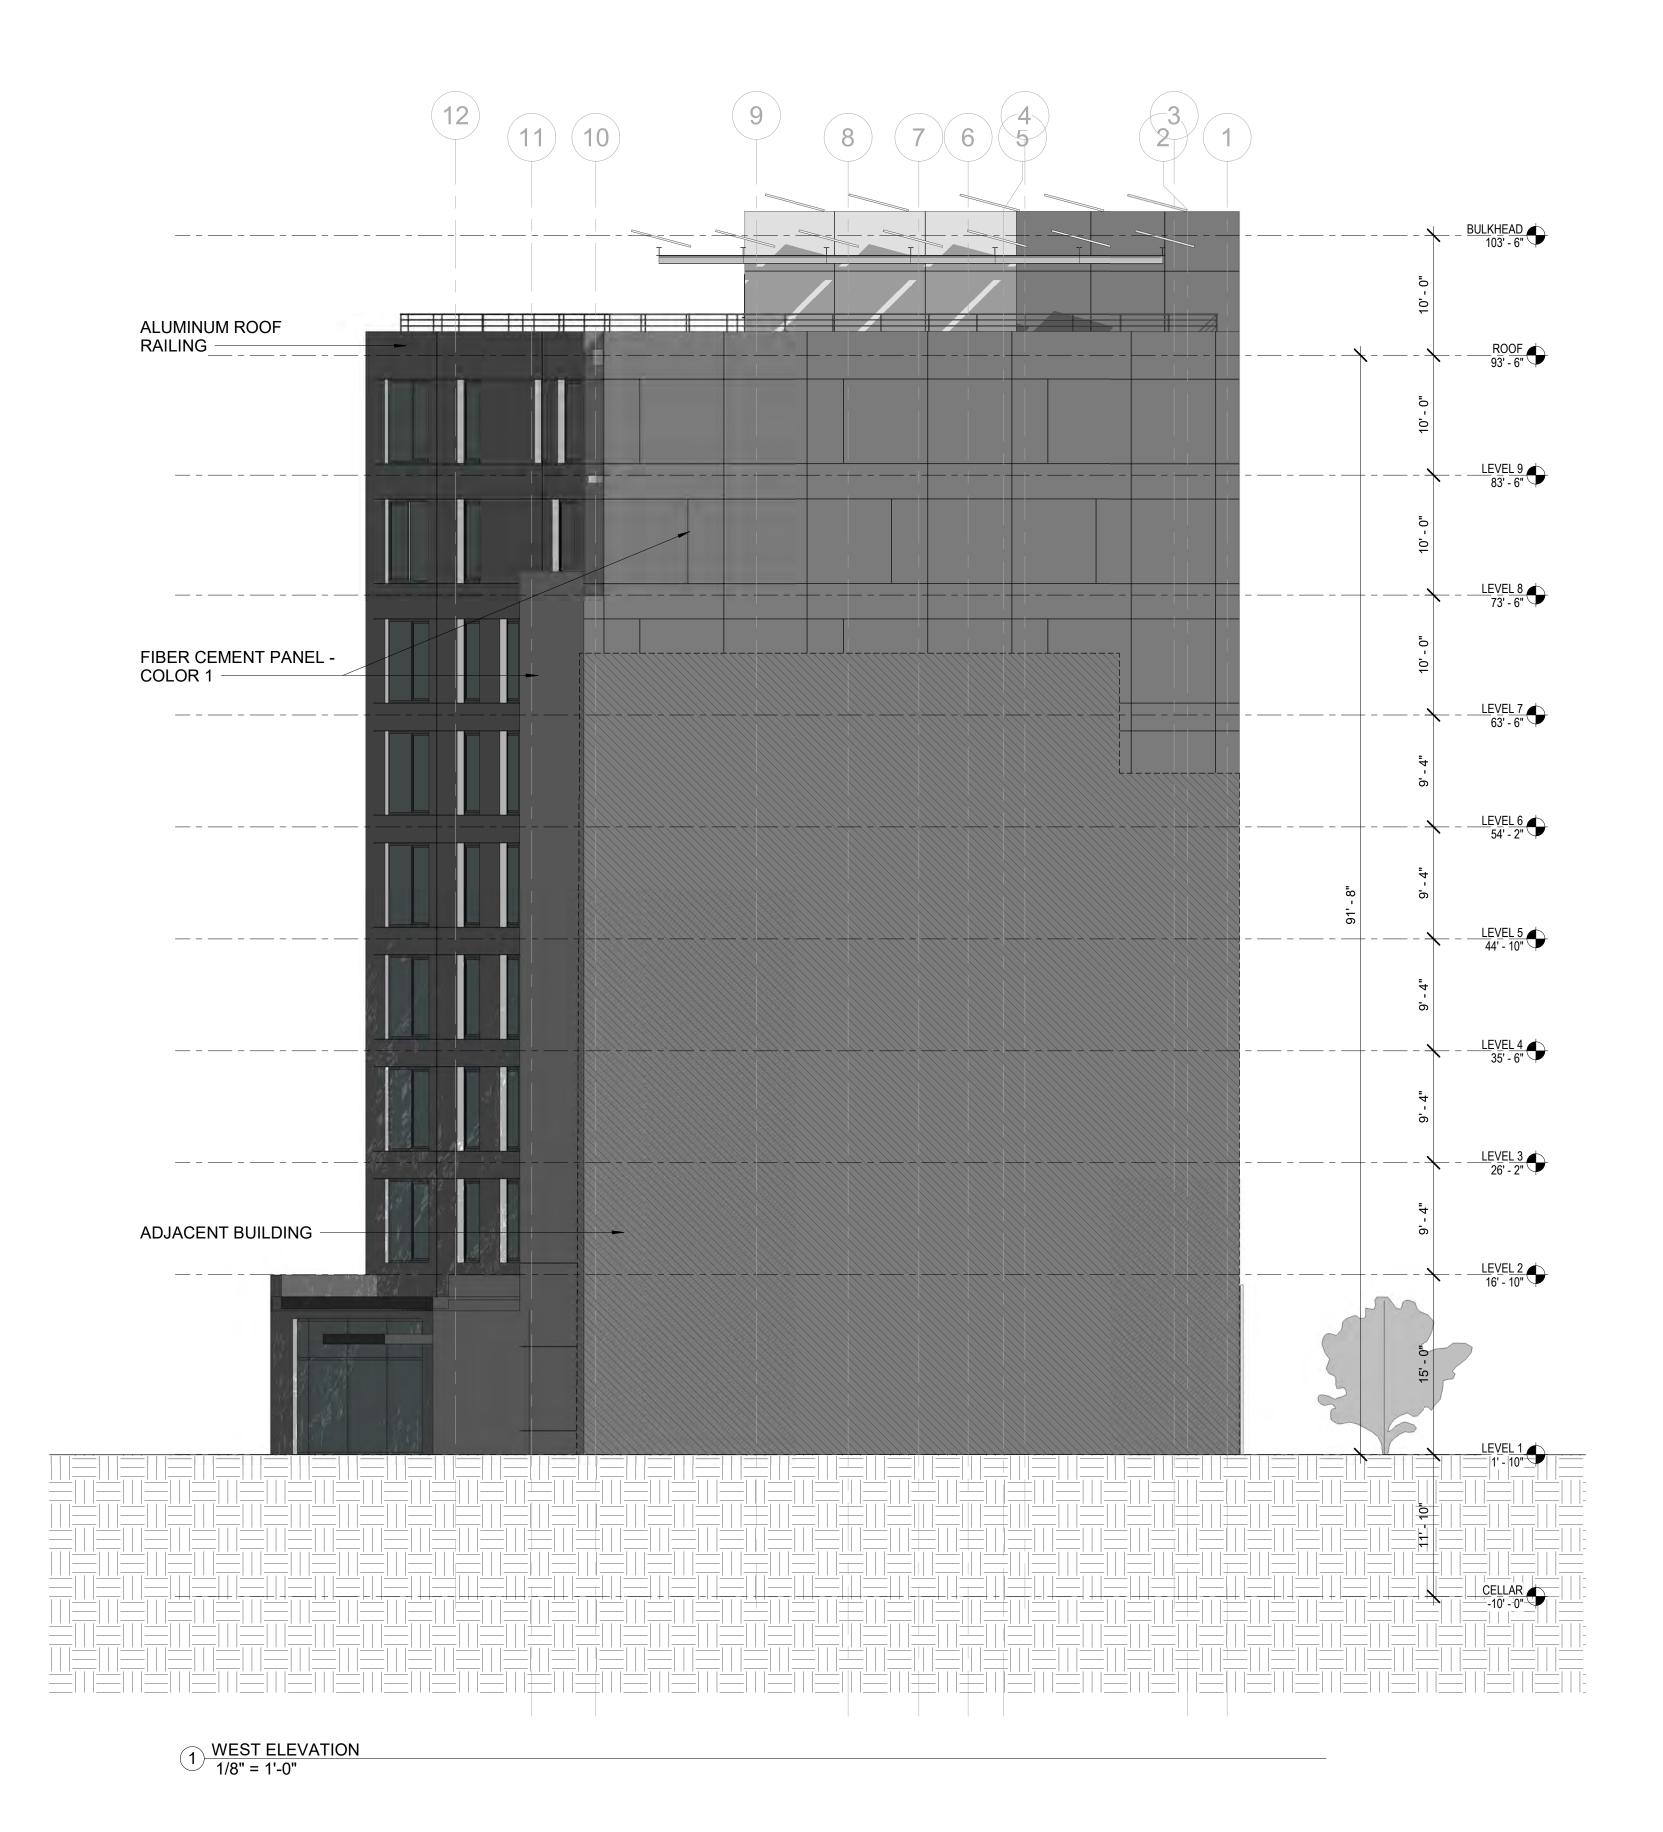

SITE A-1 665 FLUSHING AVE, BROOKLYN

Owner:



BLOCK: 2272 LOT

Tel (718) 388 5454

NYC DOB#:

Key P

NUMBER DATE DESCRIPTION

Revis

Architect:

Magnusson Architecture & Planning PC

42 West 39th Street 15th Floor New York NY 10018 Tel (212) 253 7820 Fax (212) 253 1276

Structural Engineer: CityScape Engineering 8 Haven Avenue, #209

Port Washington NY 11050 Tel (631) 978 5000 Fax (613) 978 0403

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Landscape Architect: Terrain-NYC 203 Lafayette Street, 5th Floor New York NY 10012 Tel (212) 537 6080

Client Representative:

Filing Representative:

Do Not Scale Plans Contractor to promptly notify Architect of any material variations between field conditions and existing conditions as indicated in Contract documents

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WEST ELEVATION

SEAL & SIGNATURE:

PROJECT No: 19022

DRAWING BY: Author

CHK BY: Checker

DWG No:


A-204.00

SCALE: 1/8" = 1'-0"




SITE A-1 665 FLUSHING AVE, BROOKLYN NY Owner:



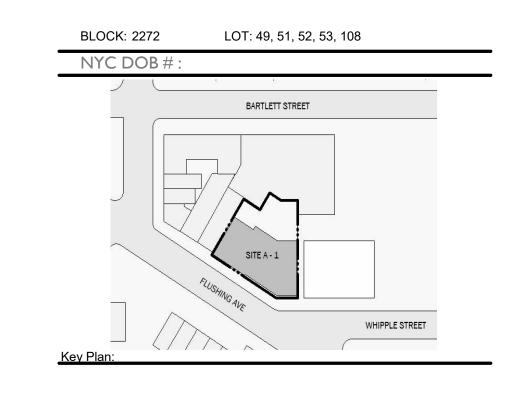

NUMBER DATE DESCRIPTION

ENLARGED SOUTH ELEVATION
(GROUND FL)

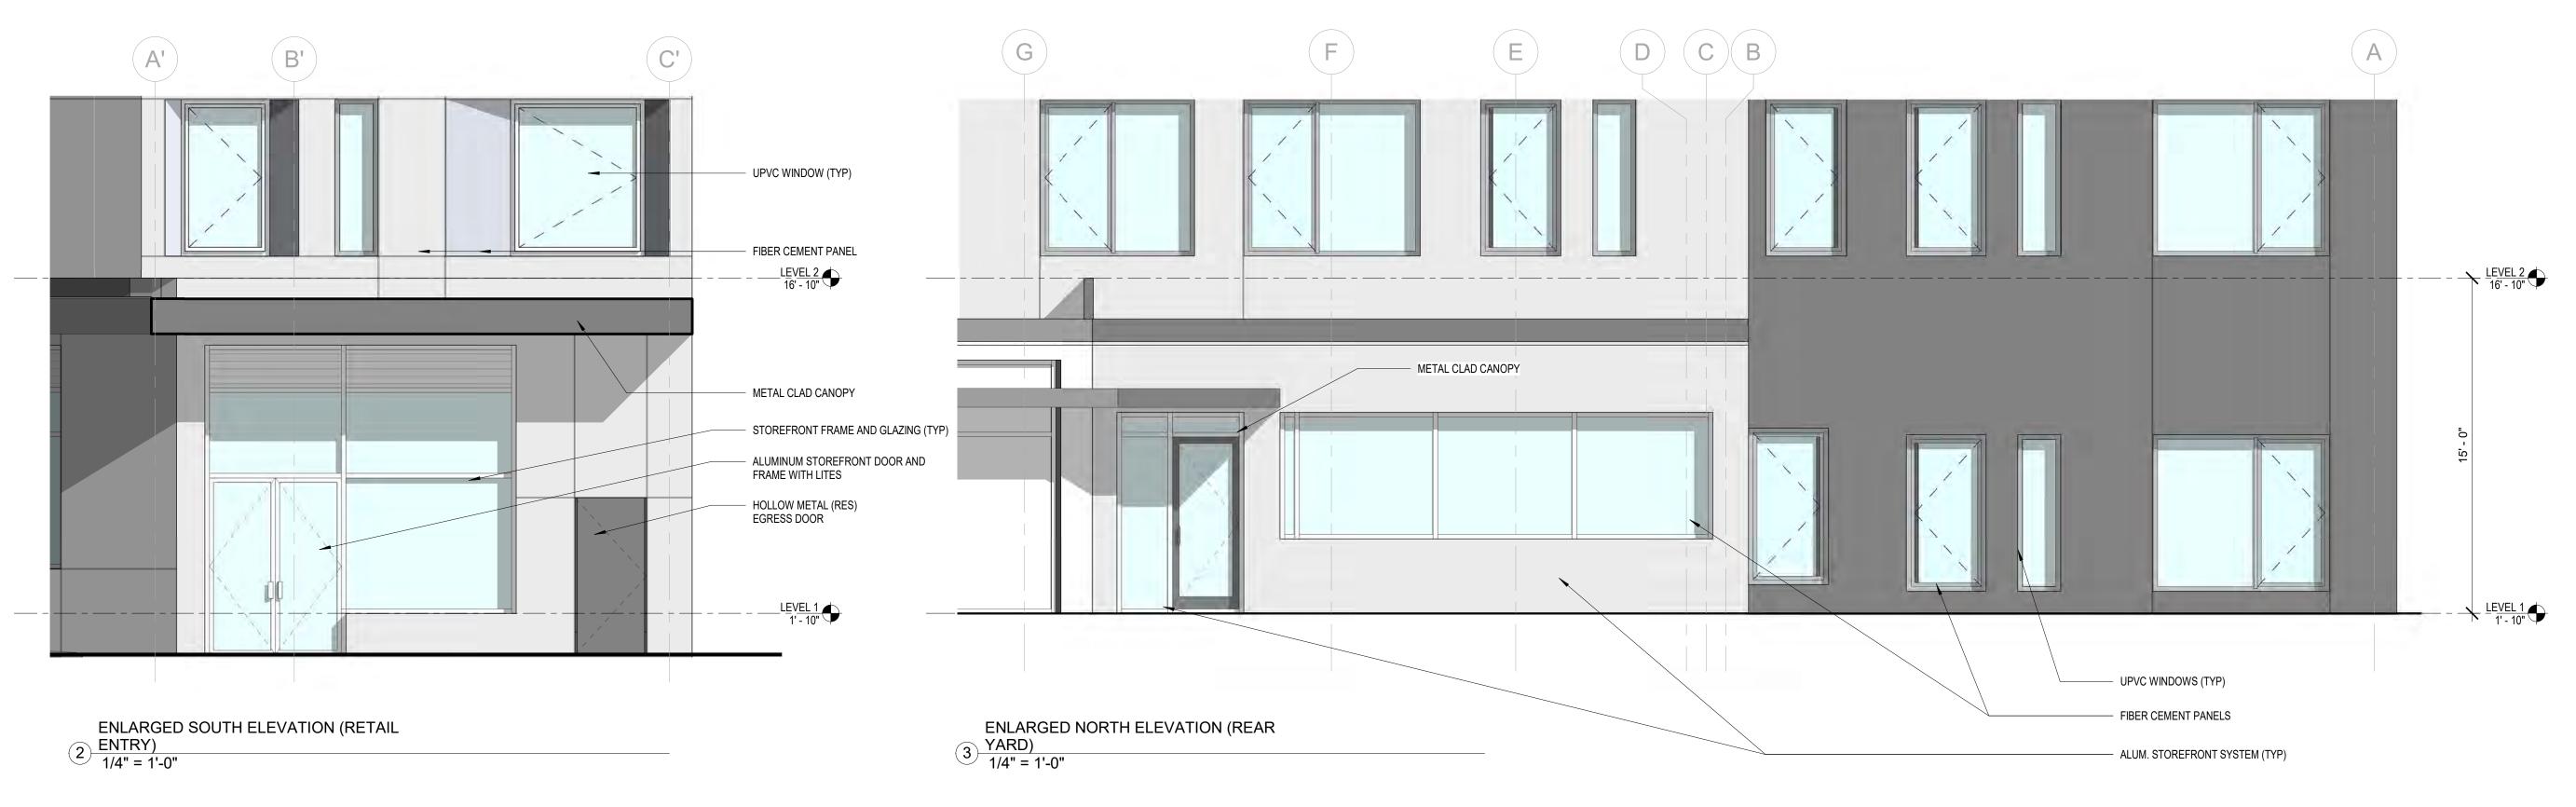

Revisions:

Architect:

Magnusson Architecture & Planning PC
42 West 39th Street 15th Floor
New York NY 10018
Tel (212) 253 7820 Fax (212) 253 1276

Structural Engineer:
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8 Haven Ave., Port Washington NY 11050
Tel (631) 978-5000

MEP Engineer:

Landscape Architect:


Client Representative:

Do Not Scale Plans
Contractor to promptly notify Architect of any material variations between field conditions and existing conditions as indicated in Contract documents

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ENLARGED ELEVATIONS

SEAL & SIGNATURE:	PROJECT No:	19022
	DRAWING BY:	Author
	CHK BY:	Checker
	DWG No:	
	A-2	10.00

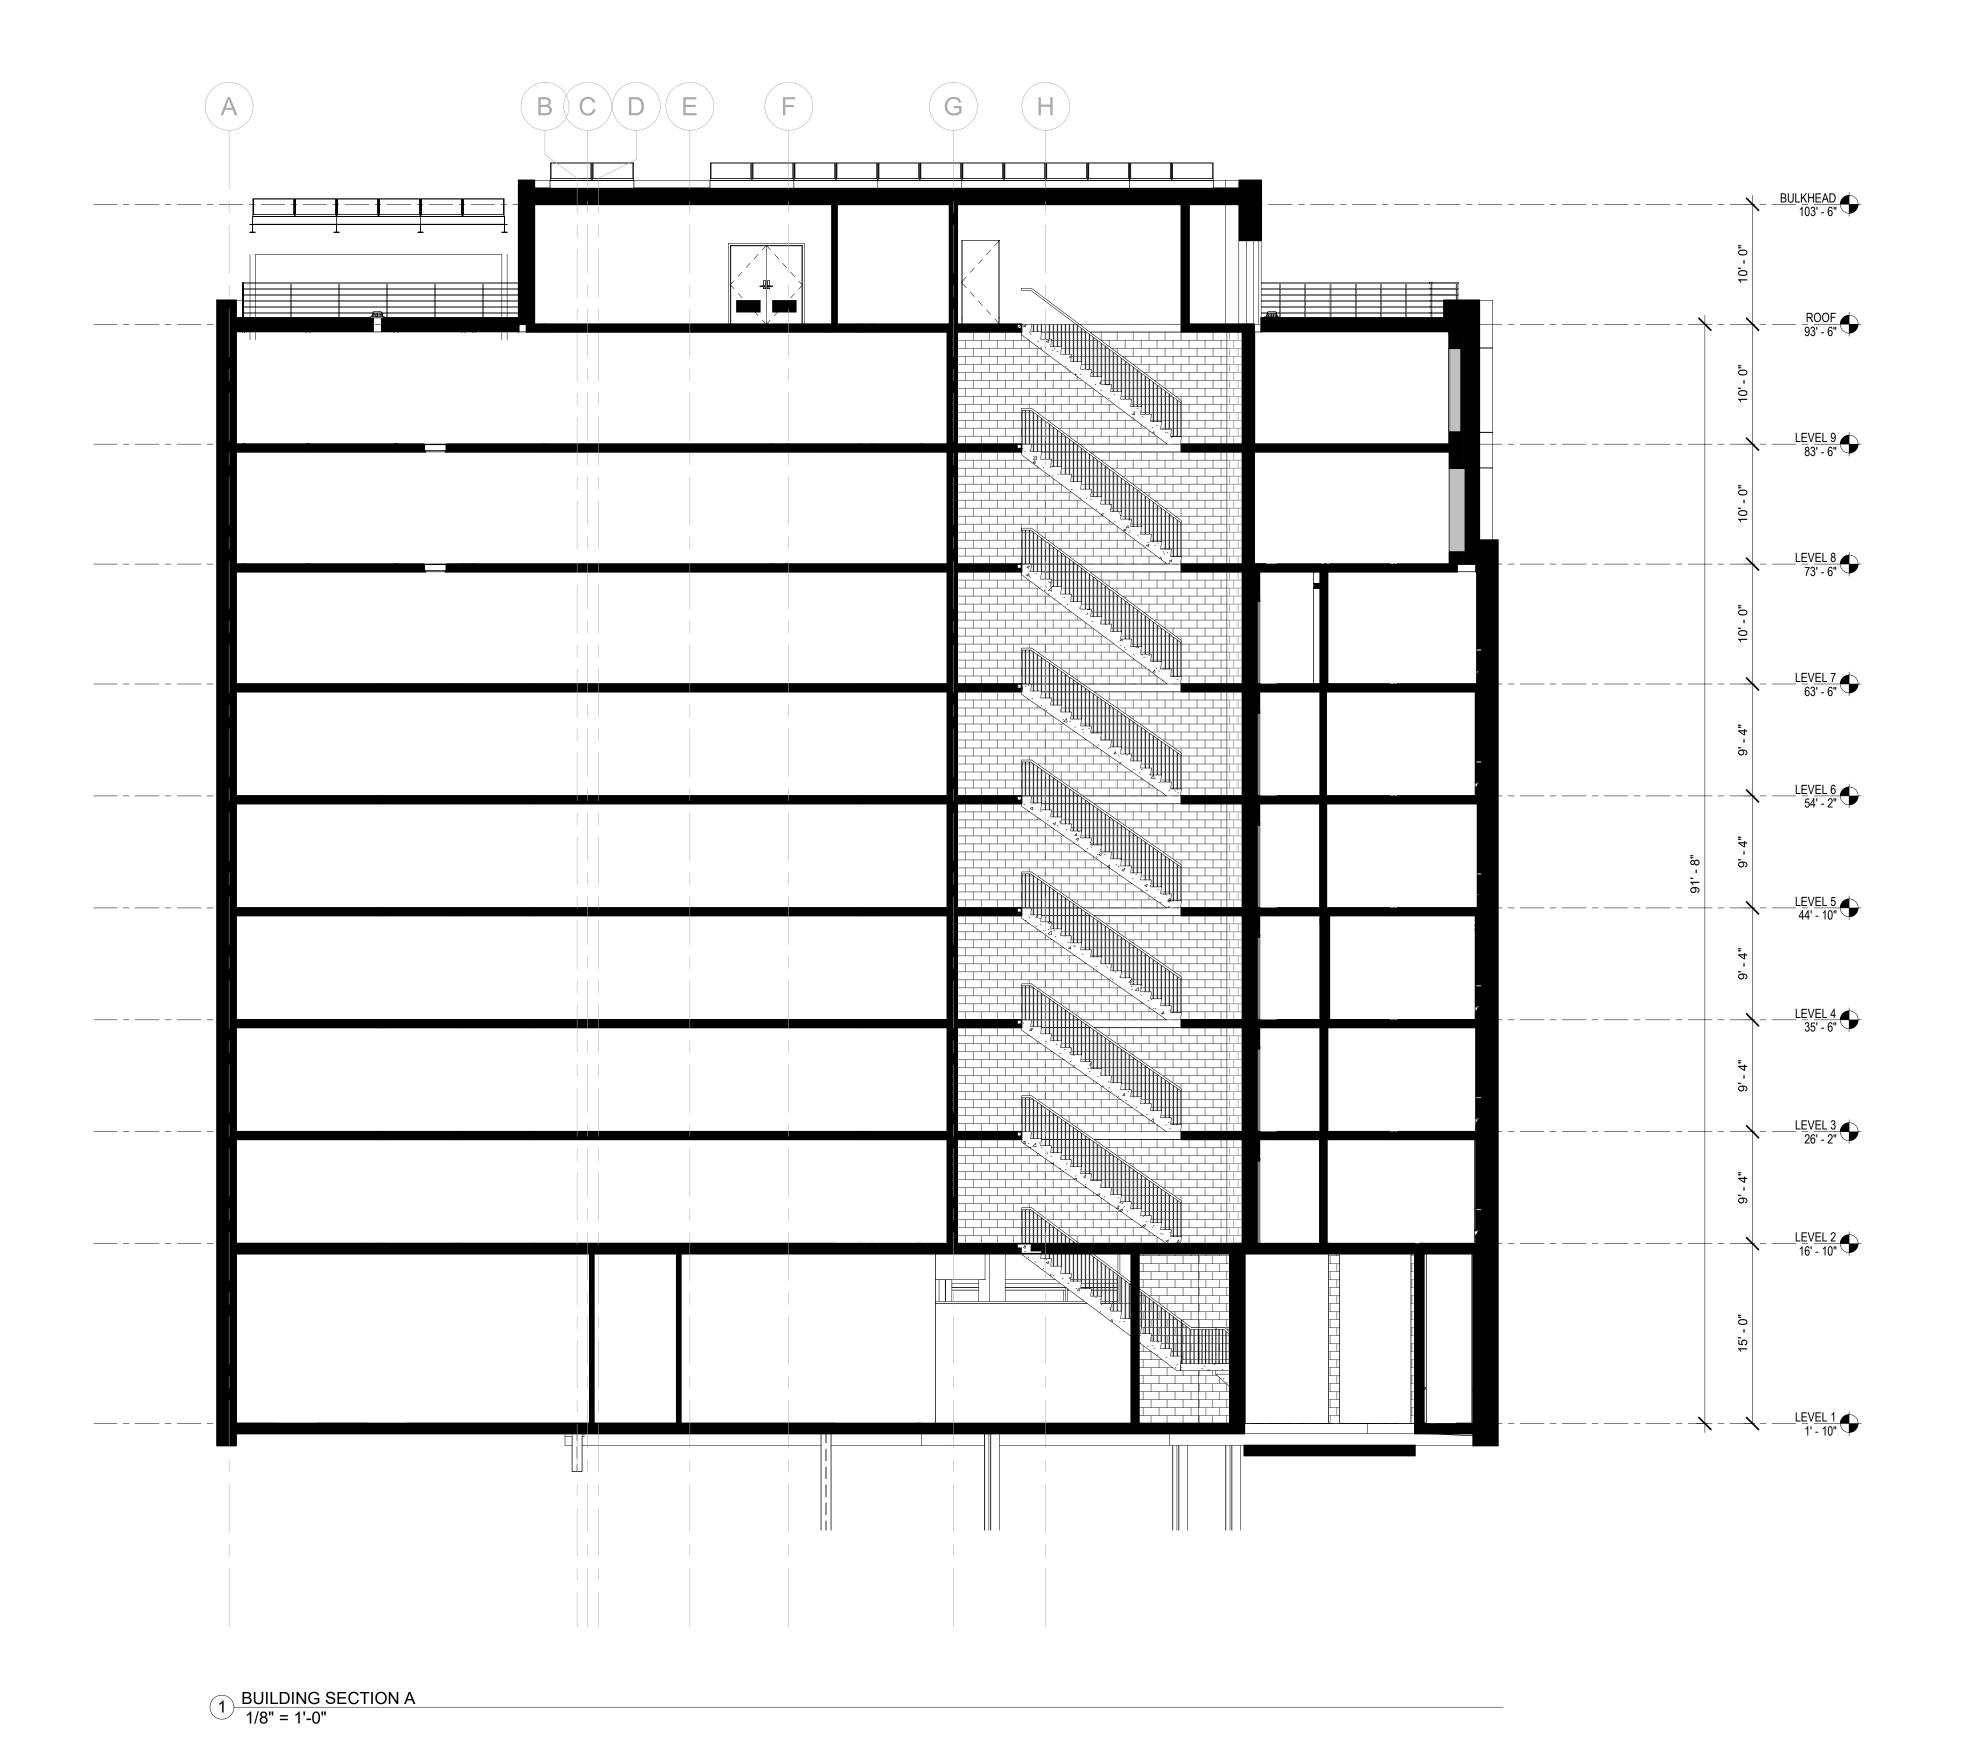

SITE A-1 665 FLUSHING AVE, BROOKLYN NY Owner:




NYC DOB #:	LOCK: 2272	BLOCK: 2272	LOT: 49, 51, 52, 5	3, 108	
	IYC DOB#:	NYC DOB#:			
DARILETI STREET			100	*	
SITE A-1 **CUSHING AVE WHIPPLE STREET Key Plan:			SITE A-1	WHIPPLE STREET	

NIIMRED	DATE	DESCRIPTIO

Architect:		
and the same		
MAP		
Magnuss	on Architecture & Planning PC	
_	Street 15th Floor	
New York N	Y 10018	
Tel (212) 25	7820 Fax (212) 253 1276	
Structural E	gineer:	
CityScape E	ngineering PLLC	
	., Port Washington NY 11050	
Tel (631) 97	5-5000	
MEP Engine	er:	
MEP Engine		
Landscape <i>i</i>	rchitect:	
	architect: sentative:	
Landscape	architect: sentative:	
Landscape A	architect: sentative:	
Landscape A	sentative:	
Landscape A Client Repre	sentative:	otus co

BUILDING SECTION

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	CHK BY:	Checker
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SITE A-1 665 FLUSHING AVE, BROOKLYN NY Owner:

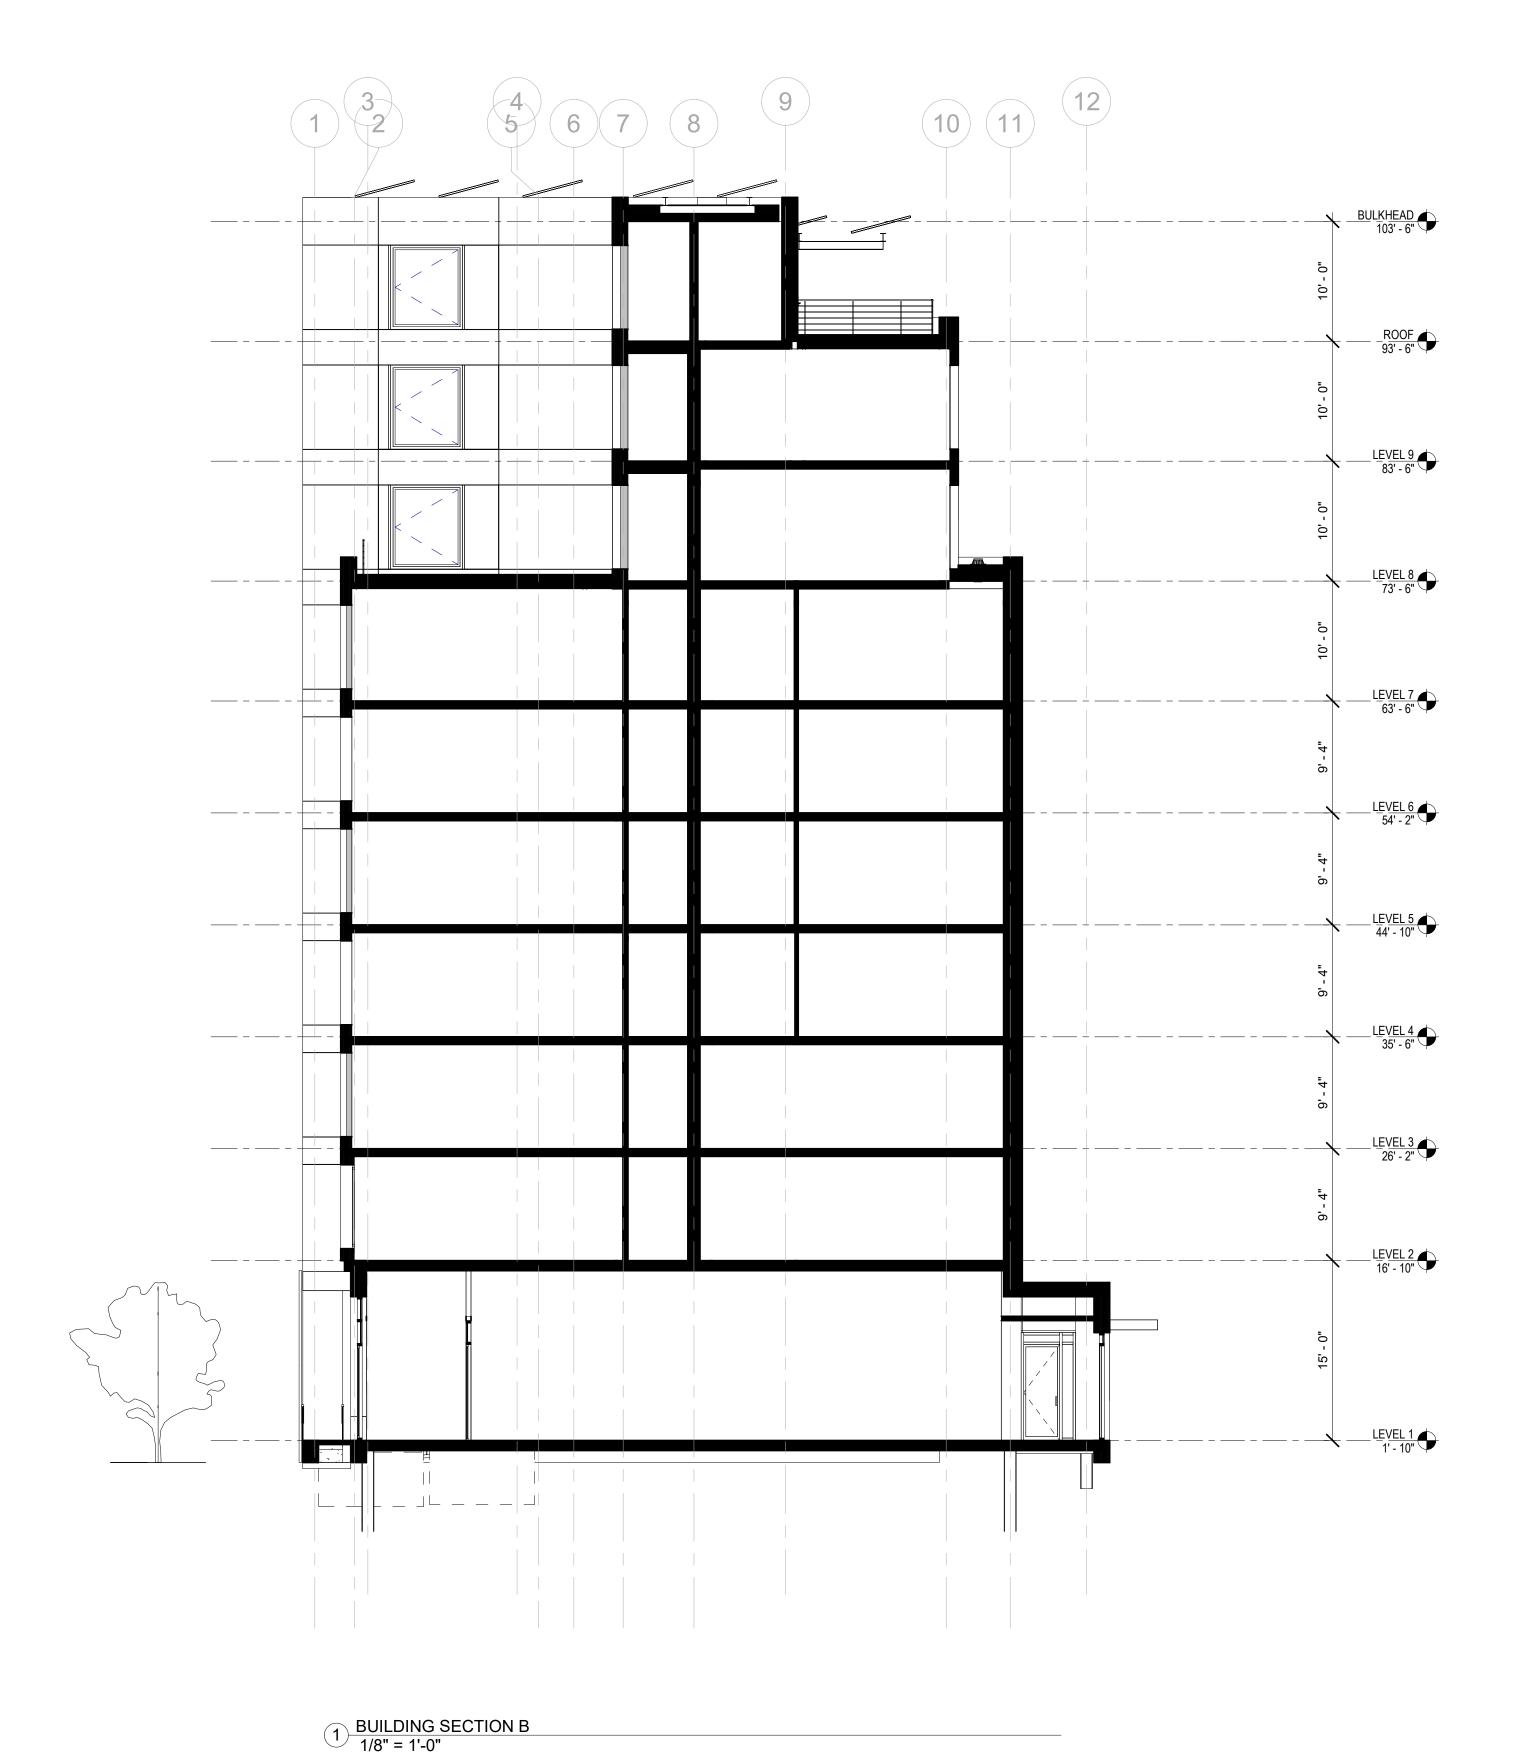


BLOCK: 2272	LOT: 49, 51, 52, 53, 108	
NYC DOB#:		
	BARTLETT STREET	
	SITE A-1 FLUSHING AVE WHIPPLE STREET	
Kev Plan:		


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Revision	s:
Architect MAP	
42 West New Yor	Isson Architecture & Planning PC 39th Street 15th Floor k NY 10018 253 7820 Fax (212) 253 1276
CityScap 8 Haven	al Engineer: ne Engineering PLLC Ave., Port Washington NY 11050 1978-5000
MEP Eng	gineer:
Landscap	pe Architect:
Client Re	epresentative:
Filing Re	presentative:
Contracto	scale Plans or to promptly notify Architect of any material variations between ditions and existing conditions as indicated in Contract documents


BUILDING SECTION

PROJECT No:	19022
CHK BY:	Author Checker
DWG No:	
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SCALE: 1/8" = 1'-0"	
	DRAWING BY: CHK BY: DWG No: A-3(SCALE:



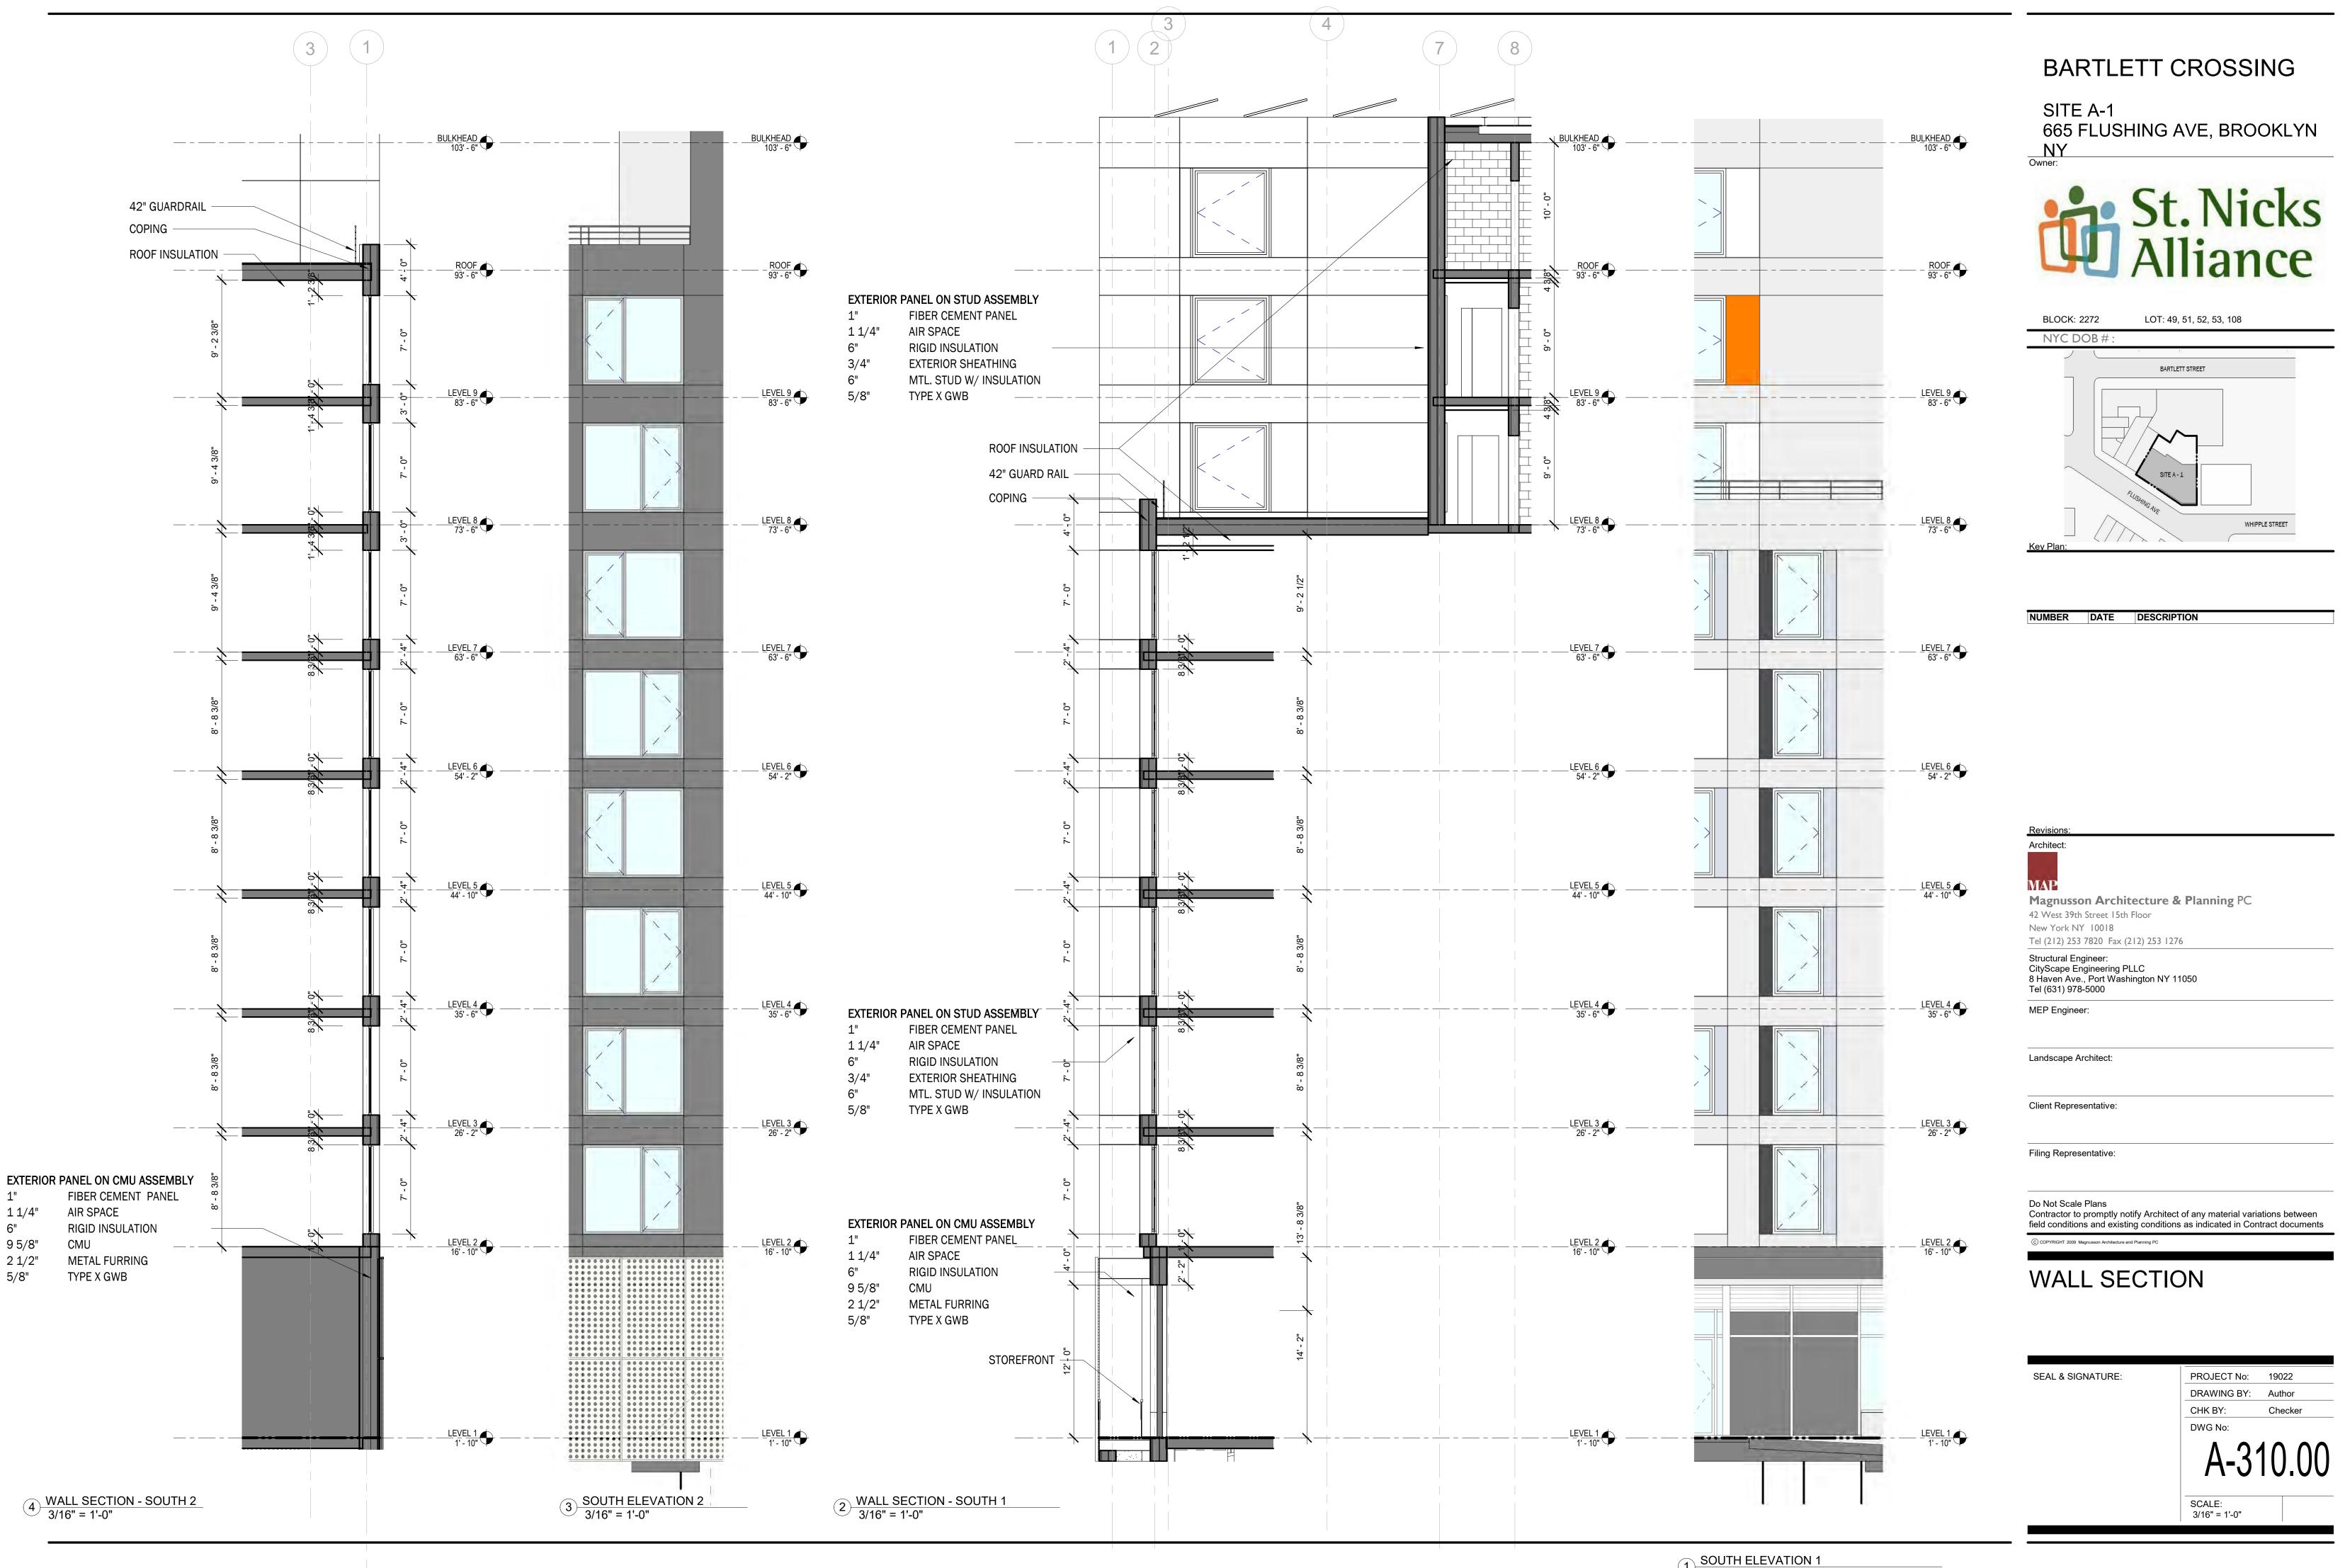

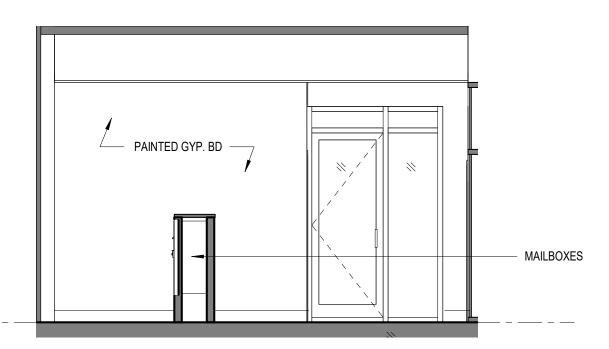
2 ELEVATION - MAIL 1/4" = 1'-0"

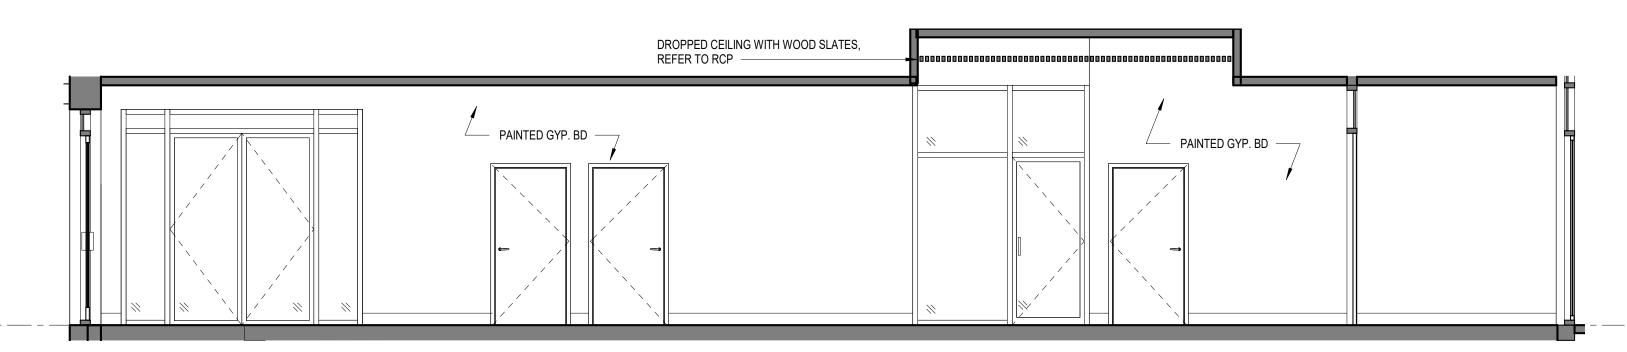


3 ELEVATION - LOBBY 1/4" = 1'-0"



4 ELEVATION - LOBBY 2 1/4" = 1'-0"

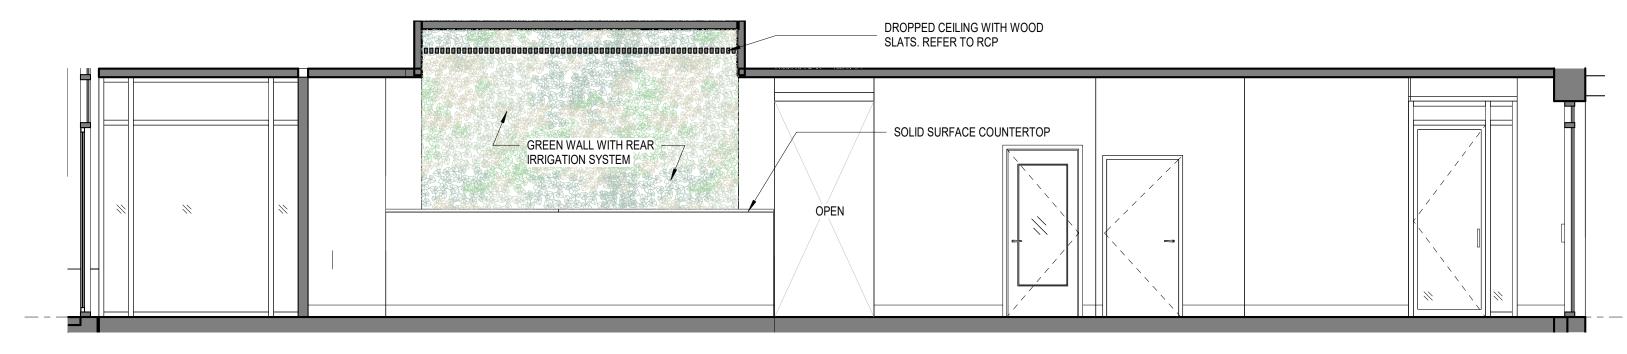

5 ELEVATION - LOBBY/MAIL
1/4" = 1'-0"

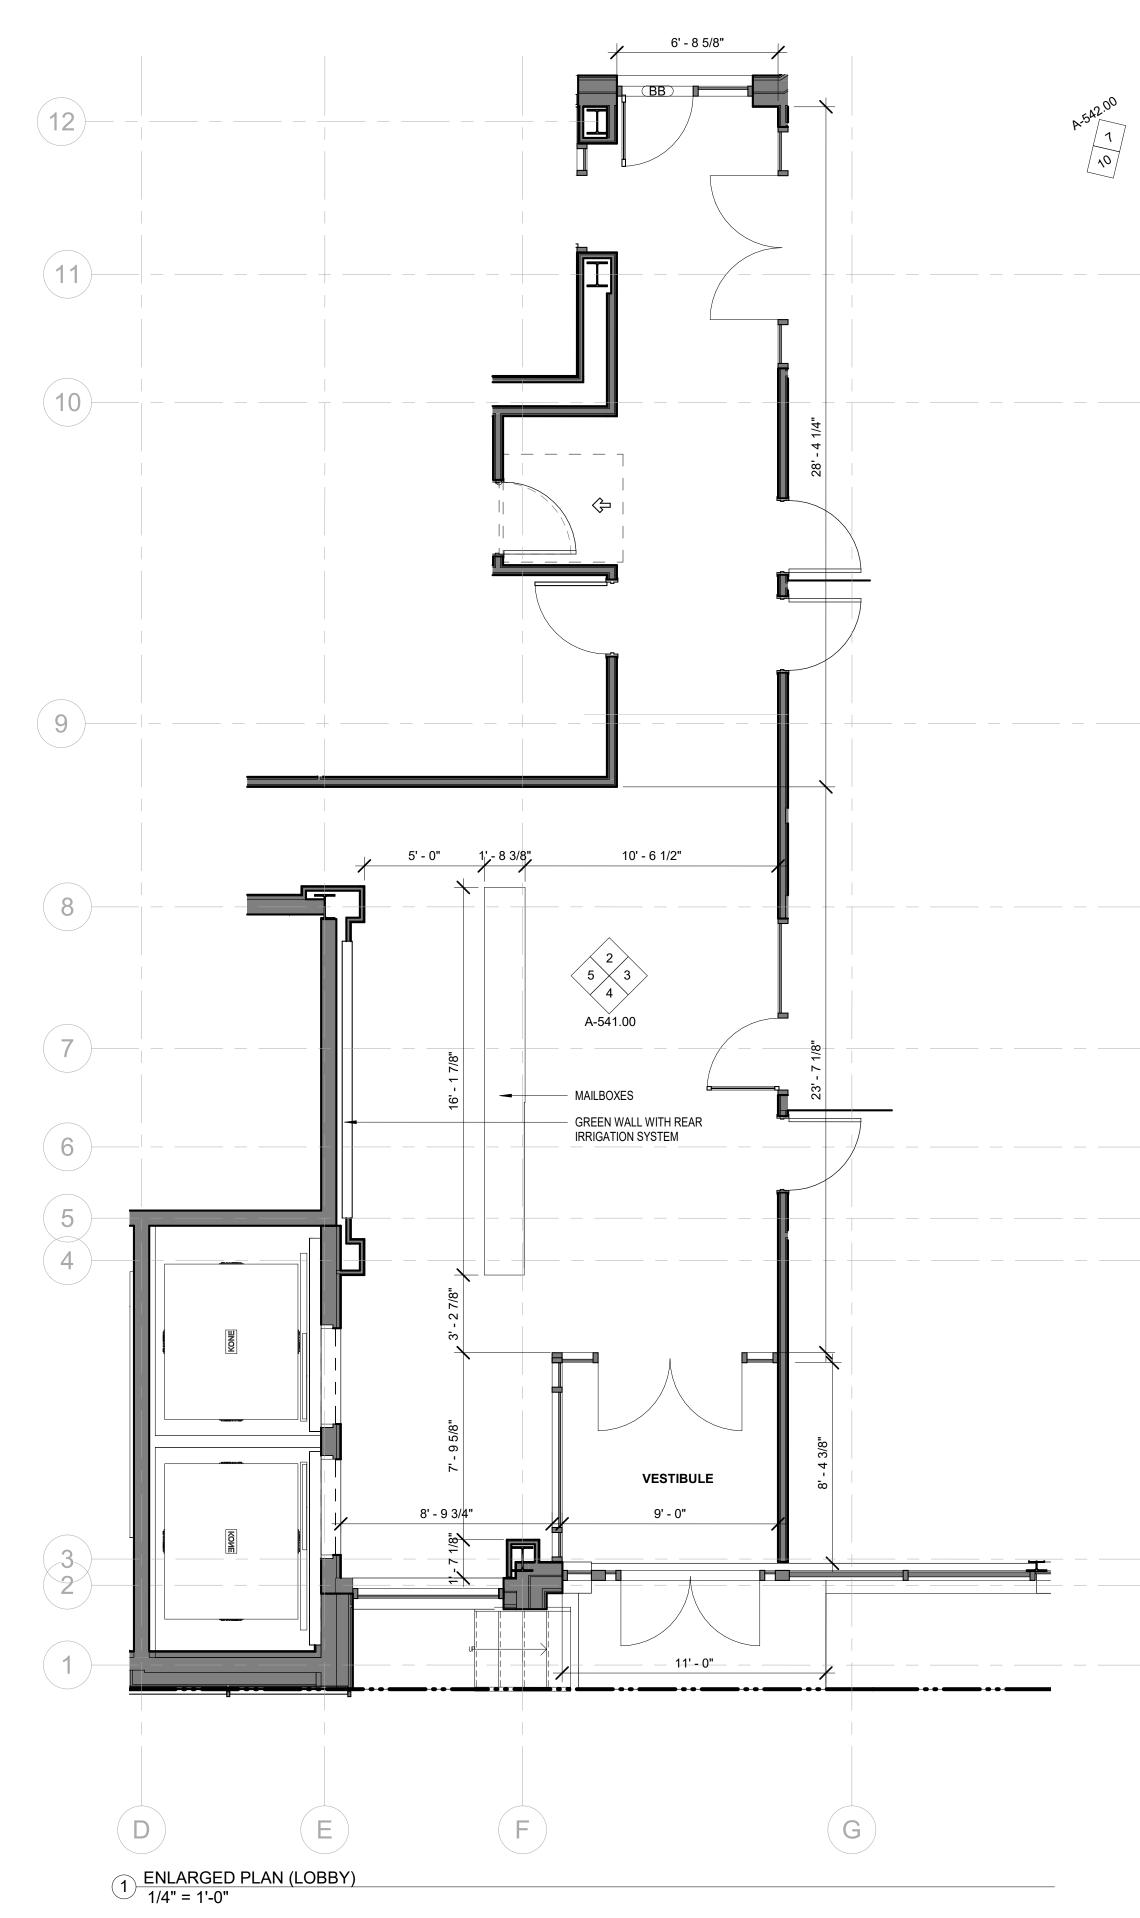

BARTLETT CROSSING

SITE A-1 665 FLUSHING AVE, BROOKLYN NY



BARTLETT STREET SITE A - 1 FLUSHING AVE WHIPPLE STREET	BLOCK: 2272	LOT: 49, 51, 52, 53, 108
BARTLETT STREET SITE A - 1 FLUSHING AVE WHIPPLE STREET	NYC DOB#:	
SITE A-1 FLUSHING AVE WHIPPLE STREET		N N
FLUSHING AVE WHIPPLE STREET		BARTLETT STREET
IZ Di	Kov Plan:	FLUSHINGAVE

NUMBER DATE DESCRIPTION

Revisions:
Architect:
MAP
Magnusson
42 West 39th Str

Magnusson Architecture & Planning PC
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New York NY 10018

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Structural Engineer:
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Tel (631) 978-5000

MEP Engineer:

Landscape Architect:

Client Representative:

Filing Representative:

Do Not Scale Plans

Contractor to promptly notify Architect of any material variations between field conditions and existing conditions as indicated in Contract documents

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LOBBY & MAIL FLOOR PLANS AND ELEVATIONS

SEAL & SIGNATURE:

PROJECT No: 19022


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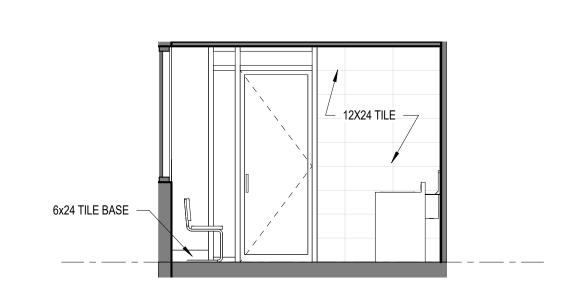
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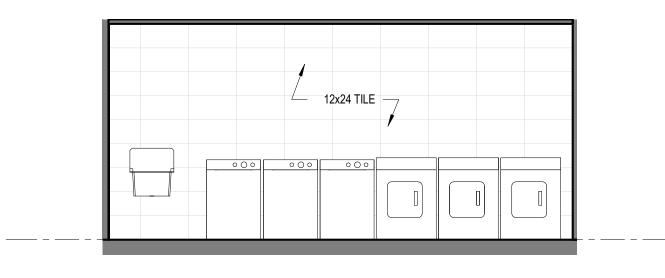
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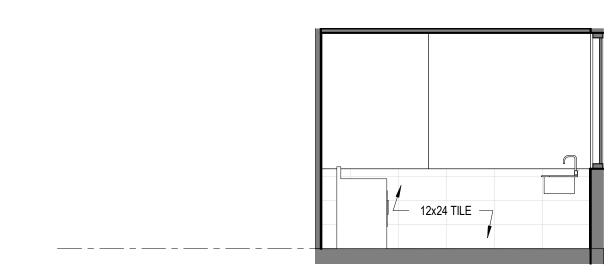
SCALE: 1/4" = 1'-0"







4 ELEVATION 2 - LAUNDRY 1/4" = 1'-0"



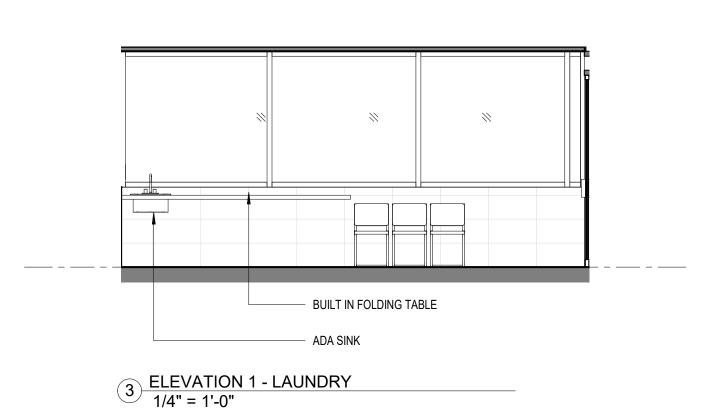

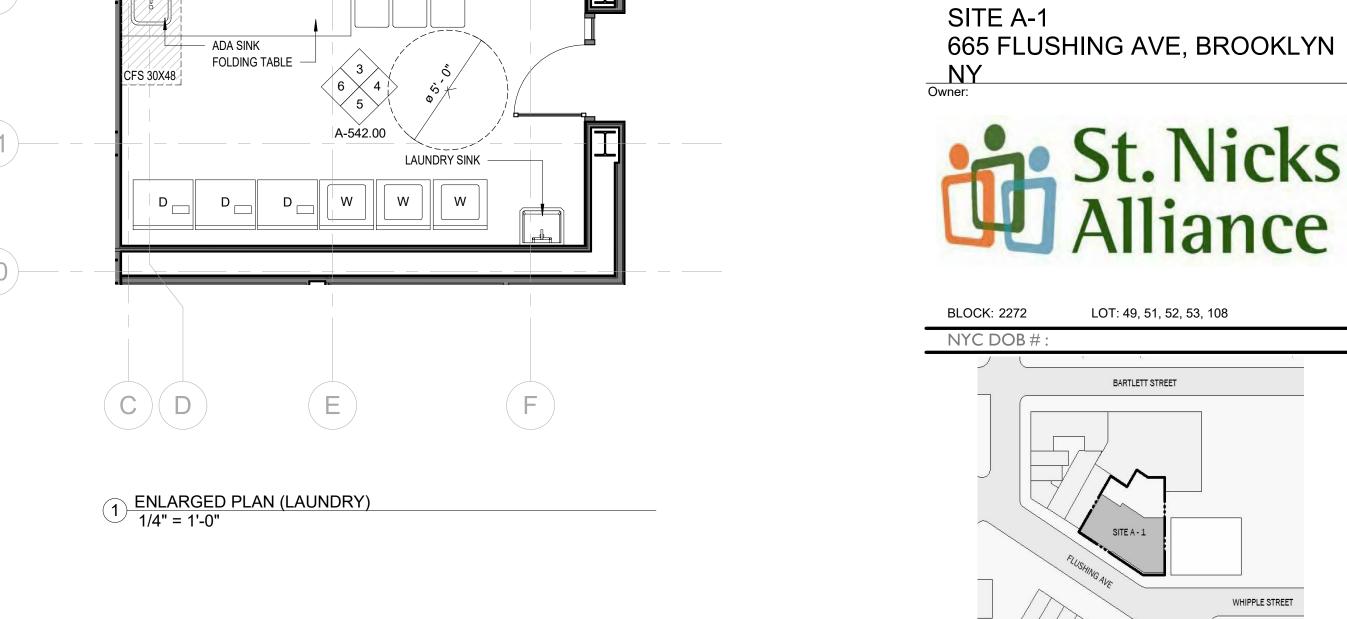


5 <u>ELEVATION 3 - LAUNDRY</u> 1/4" = 1'-0"

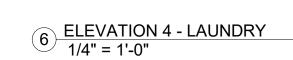





COMMUNITY ROOM

B'

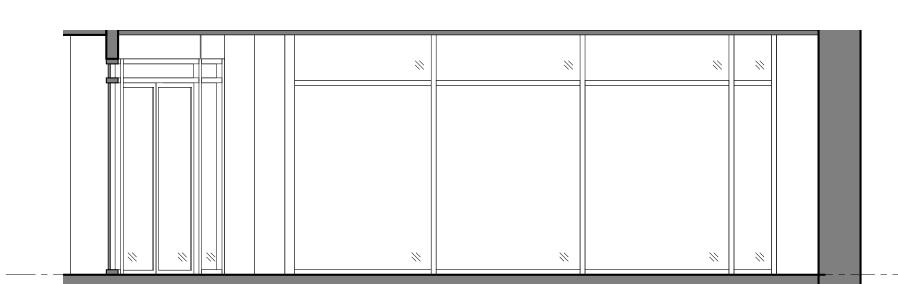

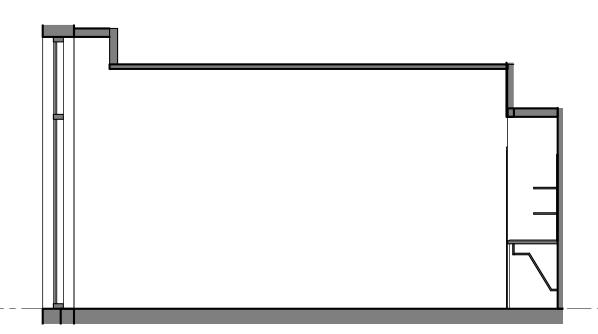

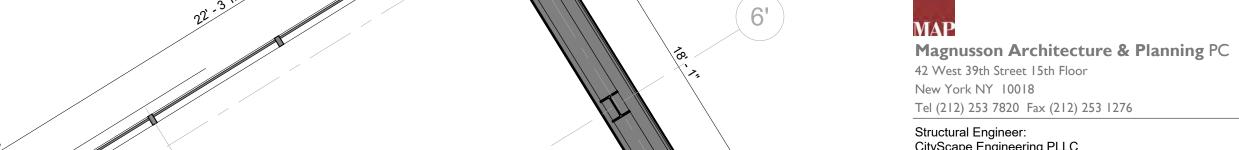

7 ELEVATION 1 - COMMUNITY ROOM 1/4" = 1'-0"


10 ELEVATION 4 - COMMUNITY ROOM 1/4" = 1'-0"

Structural Engineer: CityScape Engineering PLLC 8 Haven Ave., Port Washington NY 11050

NUMBER DATE DESCRIPTION

Tel (631) 978-5000 MEP Engineer:

Architect:

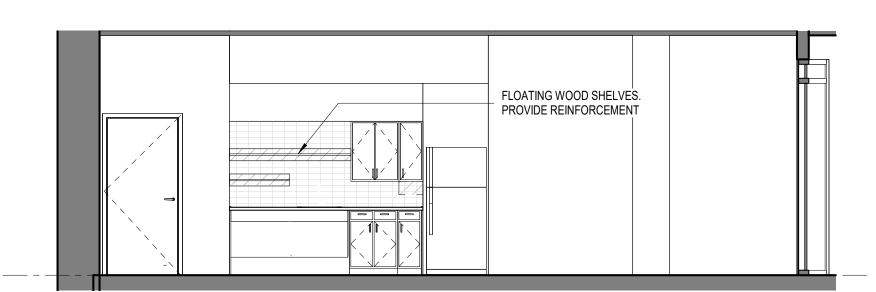



Client Representative:

Landscape Architect:


Filing Representative:

G

Do Not Scale Plans Contractor to promptly notify Architect of any material variations between field conditions and existing conditions as indicated in Contract documents

BARTLETT CROSSING

9 ELEVATION 3 - COMMUNITY ROOM 1/4" = 1'-0"

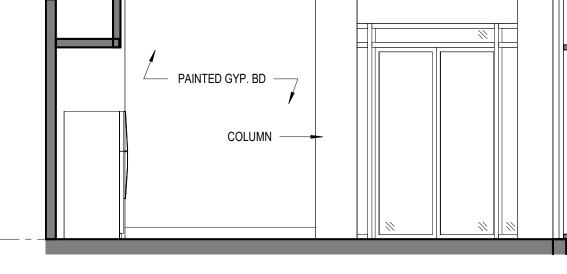


2 ENLARGED PLAN (COMMUNITY ROOM)
1/4" = 1'-0"

LAUNDRY ROOM AND COMMUNITY ROOM PLANS & ELEVATIONS

SEAL & SIGNATURE:

PROJECT No: 19022 DRAWING BY: Author CHK BY: DWG No:

SCALE: 1/4" = 1'-0"

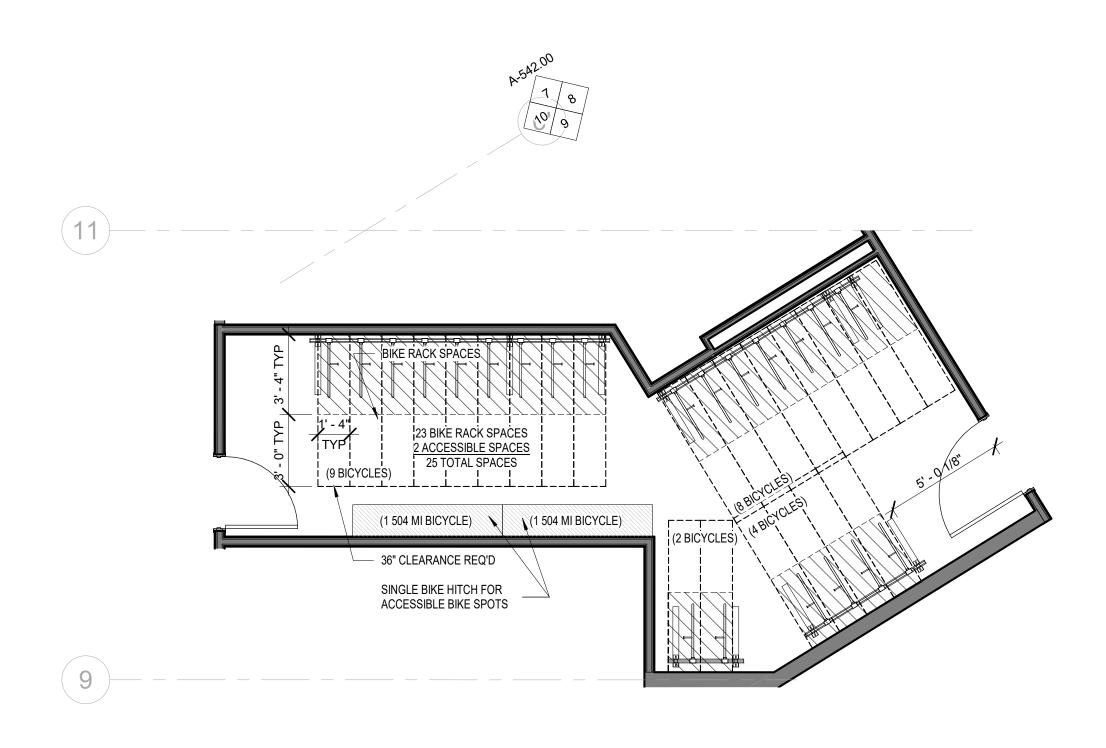

ZONING CALCULATIONS FOR RESIDENTIAL BIKE ROOM

PER ZR 25-811 MIN. REQUIRED RESIDENTIAL ENCLOSED BICYCLE PARKING 1 PER 2 DWELLING UNITS NUMBER OF DWELLING UNITS: 50 UNITS REQUIRED NUMBER OF SPACES: 25 SPACES NUMBER OF SPACES PROVIDED: 25 SPACES

PER ZR 25-83 MIN. SIZE OF BIKE STORAGE ROOM REQUIRED SQUARE FOOTAGE:

PROPOSED SQUARE FOOTAGE:


15SF PER BICYCLE 15SF PER BICYCLE X 25 SPACES = 375 SF 275 SF

MAP TO REQUEST REQUIRED SIZE WAIVER

BARTLETT CROSSING

SITE A-1 665 FLUSHING AVE, BROOKLYN NY



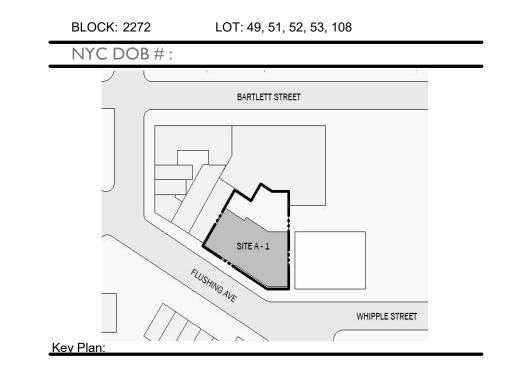

NUMBER DATE DESCRIPTION

Architect:

Magnusson Architecture & Planning PC

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New York NY 10018
Tel (212) 253 7820 Fax (212) 253 1276

Structural Engineer:
CityScape Engineering PLLC
8 Haven Ave., Port Washington NY 11050
Tel (631) 978-5000

MEP Engineer:

Landscape Architect:

Client Representative:

BIKE STORAGE ROOM

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DWG No:

A-543.00

SCALE:
1/4" = 1'-0"



SITE A-2 31 BARTLETT ST, BROOKLYN NY March 11, 2021


Revised HPD BLDS Design Consultation - Ground Floor Transparency

BARTLETT CROSSING

SITE A-2 31 BARTLETT ST, BROOKLYN NY

Own



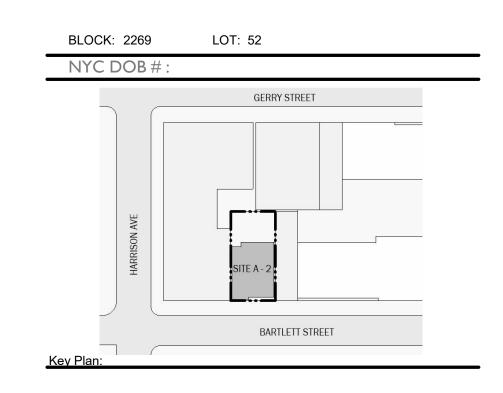

NUMBER DATE DESCRIPTION

Revisions:

Architect:

MAP

Magnusson Architecture & Planning PC

42 West 39th Street 15th Floor
New York NY 10018
Tel (212) 253 7820 Fax (212) 253 1276

Structural Engineer:

MEP Engineer:

Landscape Architect:

Client Representative:

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Cover Page

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PROJECT No: 19022

DRAWING BY: Author

CHK BY: Checker

DWG No:

C-001.00

SCALE:


	Property Information			
Address	31 Bartlett Street, Brooklyn, NY 11206			
Block	2269			
Lot	52			
BIN	3061452			
Zoning Map	13b			
Zoning District	R7A			
Commercial Overlay	C2-4 (Partial)			
Community District	Brooklyn I			
Special Districts	N/A			
	All of Community District Within Transit Zone (Appendix I)			
	Bartlett Street is a narrow street			
	This site is not in a Special Flood Hazard Area (3604970204F)			
	This site is in the Inclusionary Housing Designated Area (Appendix F)			
	Site Description			
	Lot Area (50.00' x 100.00')	5,000.00		
		Permitted	Dunnand	DWGS
	Use Regulations		Proposed	DWGS
ZR 22-10	Use Permitted	1, 2, 3, 4	2	
ZR 32-10	Use Permitted	5, 6, 7, 8, 9, 14	2	D-D4 6-3-5
	FAR (Under Quality Housing Program ZR28-01)	Permitted	Proposed	DWGS
ZR 23-153	Max Residential FAR - Narrow Street	4.60	4.52	
ZR 23-154	Max Allowable Residential SF	23,000	22,623	
				4 - 1
	Density	Permitted	Proposed	DWGS
ZR 23-22	Density Factor Use Group 2	680 (34 Residential units permitted)	29	
	Lot Coverage	Permitted	Proposed	DWGS
ZR 23-153	Max Lot Coverage	65%	62%	
	Max Allowable Lot Coverage	3,250.00	3,105	
	Yard Regulations	Required	Proposed	DWGS
ZR 23-45	Front Yard	Not Required	N/A	
ZR 23-462(c),	Side Yards	0 or 8'	0	
ZR 23-47	Rear Yard	30'-0" min	34'-6"	
	Bulk Regulations	Permitted	Proposed	DWGS
0.7 27 0.	Minimum Base Height - IH	Min 40'	68'-10"	
ZR 23-662,	Maximum Base Height - IH (Narrow Street)	Max 75'	68'-10"	
ZR 23-664	Maximum Building Height - IH (Narrow Street)	Max 90'	88'-10"	
	Maximum Number of Stories - IH (Narrow Street)	Max 9	9	
ZR 23-662 (c)(1)	Min Required Setback distance beyond max base height (Narrow Street)	Min 15'	18'-8"	
ZR 23-661 (b)(1)	Street Wall Location	No closer to street line than exist, adj. bldg	Complies	
ZR 23-621 (c)	Dormer width = <60% of width of street wall, minus 1% of height	Max: 22' - 4 9/16" at Roof Level	21' - 11"	
21(23-021 (c)	Parking Regulations		Proposed	DWGS
ZR 25-251	Min Req accessory parking for Residential Uses	Required N/A, Within Transit Zone	. roposeu	D1103
Transfer and the second			0	
ZR 25-33	Waiver of requirements for Spaces below minimum number	< 40 Spaces	- '	D14/00
	Bicycle Parking Regulations	Required	Proposed	DWGS
	Min Req Use Group 2 (1 per 2 DU)	14.5 = 15	15	
	Street Tree Planting	Required	Proposed	DWGS
ZR 23-03, 26-41	Street Tree Requirement	I per 25ft of street frontage = 2	2 New	
ZR 23-03, 26-42	Planting Strip Requirement	N/A		
	Quality Housing Program	Required	Proposed	DWGS
ZR 28-12	Refuse Storage Room (2.9 cu. ft. per unit)	2.9 cu ft x 29 units = 84.1 cu ft	2385 cu ft	
20.00	Refuse Disposal Room	Not less than 12sf/ each residential story	Complies	
ZR 28-13	Laundry Facility Equipment	I washer / 20 units = 2 washers	3	
		I dryer / 40 units = I dryers	3	
ZR 28-14	Daylight in Corridors	Windows min 20 sf glazed area	N/A	
ZR 28-21	Required Recreation Space: Accessible indoor and outdoor (3.3% of FA) (sf)	747	2,060 SF	
ZR 28-31	Density	Max. 11 dwelling units per story	Complies	
		za www. And warming and part of ZiV.		

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SITE

- 11			DEDUC	TIONS / GSF EXEMPT FRO	OM ZFA						
	Residential (GSF)	Total Gross Floor Area	QUALITY HOUSING ZR 28-12, 28-13, 28-14, 28- 21, 28-31	RESIDENTIAL EXT WALL ZR 12-10 "Floor Area" (12)	RESIDENTIAL MECH & BULKHEAD ZR 12-10 "Floor Area" (1), (2), (8),(11(i))	Residential ZFA	Res 0 BR	Res 1BR	Res 2BR	Total DU	
FLOOR		, id				_					FLOOR
G	3,106	3,106	-861	-152	-637	1,456	0	0	0	0	G
2	3,105	3,105	-80	-152	-67	2,806	1	2	1	4	2
3	3,105	3,105	-80	-152	-67	2,806	1	2	1	4	3
4	3,105	3,105	-80	-152	-67	2,806	1	2	1	4	4
5	3,105	3,105	-80	-152	-67	2,806	1	2	1	4	5
6	3,105	3,105	-80	-152	-67	2,806	1	2	1	4	6
7	3,105	3,105	-80	-152	-67	2,806	1	2	1	4	7
8	2,680	2,680	-501	-152	-68	1,959	0	1	1	2	8
9	2,680	2,680	-90	-152	-66	2,372	1	1	1	3	9
R	794	794	0	0	-794	0	0	0	0	0	R
TOTAL	27,890	27,890	-1,932	-1368	-1,967	22,623	7	14	8	29	TOTAL



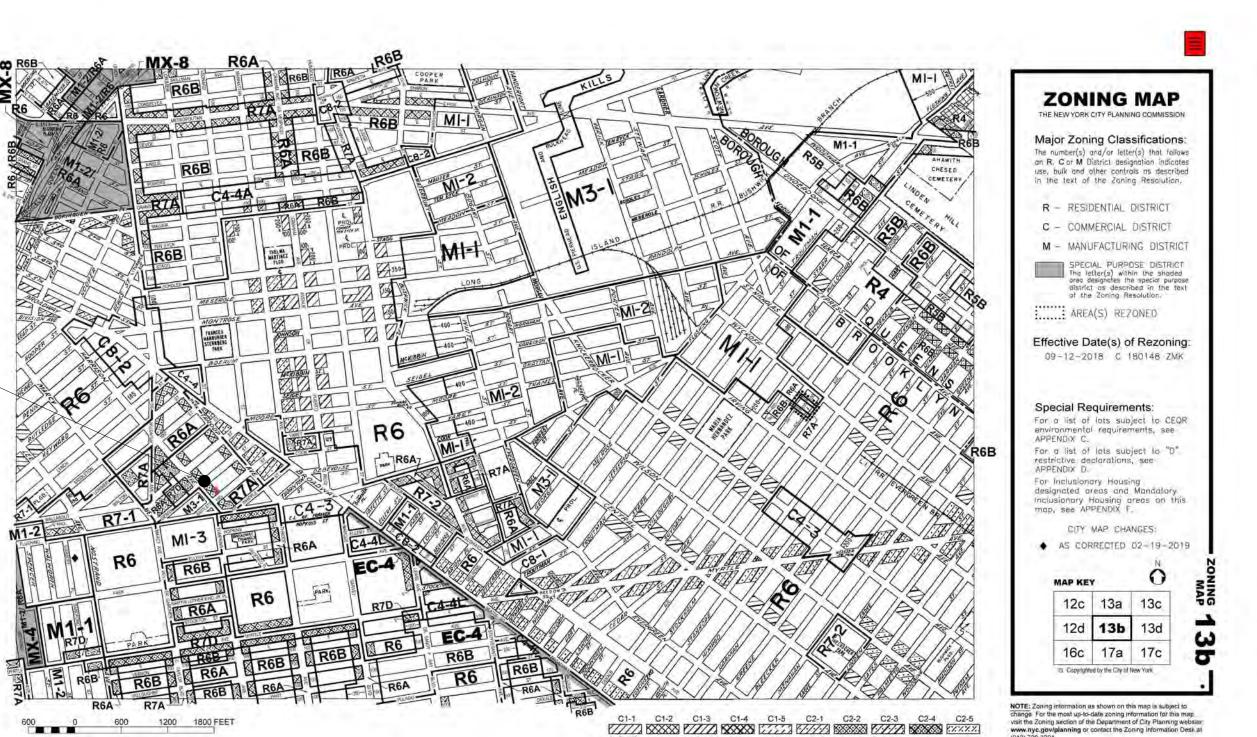


BARTLETT CROSSING

SITE A-2 31 BARTLETT ST, BROOKLYN NY

Owner:



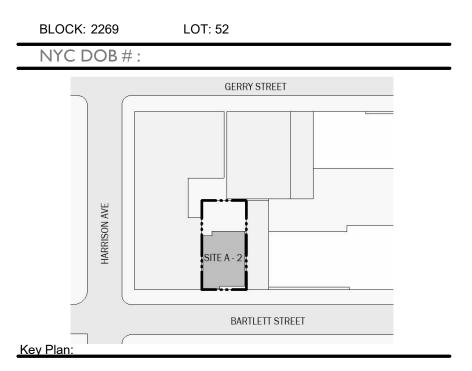

NUMBER DATE DESCRIPTION

Revisions:

Architect:

Magnusson Architecture & Planning PC

42 West 39th Street 15th Floor New York NY 10018 Tel (212) 253 7820 Fax (212) 253 1276

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Loring Consulting Engineers
360 West 31st Street, New York, NY 10001
Tel (646) 674-6100

Landscape Architect:
Terrain-NYC Landscape Architects
203 Lafayette Street, New York, NY 10012
Tel (212) 537-6080

Client Representative:

Filing Representative:

Do Not Scale Plans
Contractor to promptly notify Architect of any material variations between field conditions and existing conditions as indicated in Contract documents

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ZONING ANALYSIS

SEAL & SIGNATURE:

PROJECT No: 19022

DRAWING BY: Author

CHK BY: Checker

DWG No:

7 004 00

Z-001.00

CHAPTER 3: USE AND OCCUPANCY CLASSIFICATION

OCCUPANCY SCHEDULE

OCCUPANCY GROUP

RESIDENTIAL

STORAGE ROOM OVER 100 SF TRASH COMPACTOR ROOM MECHANICAL AND/OR ELECTRICAL EQUIP. ROOM LAUNDRY ROOM OVER 100 SF

INCIDENTAL USE PER

INCIDENTAL USE PER TABLE 509 INCIDENTAL USE PER TABLE 509 INCIDENTAL USE PER TABLE 509

CHAPTER 5: GENERAL BUILDING HEIGHTS AND AREAS; SEPARATION OF OCCUPANCIES

TABLE 503: ALLOWABLE HEIGHT AND BUILDING AREAS CONSTRUCTION TYPE I-B = UNLIMITED; FULLY SPRINKLERED BLDG **PROPOSED**

BC 508: INCIDENTAL USE AREAS AND MIXED OCCUPANCIES:

TABLE 509 INCIDENTAL USE AREAS

ROOM OR AREA

FIRE SEPARATION PROTECTION PROVIDED

RESIDENTIAL

STORAGE OVER 100 SF TRASH COMPACTOR ROOM MECHANICAL AND/OR ELECTRICAL EQUIP. ROOM LAUNDRY OVER 100 SF

TABLE 508.4 REQUIRED SEPARATION OF OCCUPANCIES (HOURS)

1HR BETWEEN R-2 AND S-1 TENANCIES BETWEEN R-2 AND B TENANCIES 1HR

CHAPTER 6: TYPES OF CONSTRUCTION

TYPE I NON-COMBUSTIBLE (FROM TABLE 601 & TABLE 602)	CLASS <u>1-B</u>
---	------------------

ABLE 601: FIRE RESISTANCE RATING FOR BUILDING ELEMENTS	RATING IN HOURS
STRUCTURAL FRAME	2
BEARING WALLS	
EXTERIOR	2*
INTERIOR	2
NONBEARING WALLS AND PARTITIONS	
EXTERIOR *	1
NONBEARING WALLS AND PARTITIONS	
NTERIOR	0
FLOOR CONSTRUCTION	
NCLUDING SUPPORTING BEAMS AND JOISTS	2
ROOF CONSTRUCTION	1

* BASED ON TABLE 602, FOR FIRE SEPERATION DISTANCE < 5FT FIRE RESISTANCE RATING FOR EXTERIOR WALLS FOR OCCUPANCY R = 1 HR

CHAPTER 7: FIRE RESISTANCE RATED CONSTRUCTION

TABLE 705.8: MAXIMUM AREA OF EXTERIOR WALL OPENINGS

LOT LINE WINDOWS ALONG EAST ELEVATION

FIRE SEPARATION DISTANCE	DEGREE OF OPENING PROTECTION	ALLOWABLE AREA
0'	UNPROTECTED, SPRINKLERED	10% PER STORY

NOTE: THESE OPENINGS DO NOT CREDIT TOWARDS MEETING ANY MANADATORY NATURAL LIGHT OR VENTILATION REQUIREMENTS.

CHAPTER 8: INTERIOR FINISH FLAME SPREAD INDEX

TABLE 803.1 INTERIOR WALL AND CEILING FINISH REQUIREMENTS BY OCCUPANCY

		SPRINKLERED	
GROUP	VERTICAL EXITS AND EXIT PASSAGEWAYS	EXIT ACCESS CORRIDORS AND OTHER EXITWAYS	ROOMS AND ENCLOSED SPACES
R-2	В	В	С

CHAPTER 10: MEANS OF EGRESS

TABLE 1004.1.1: MAXIMUM FLOOR AREA ALLOWANCES PER OCCUPANT

USE OF SPACE	(SF)	OCCUPANT LOAD (FLOOR AREA PER OCCUPANT PER TABLE 1004.1.1)
RESIDENTIAL = 200 GROSS SF WITHIN DV	WELLING UNITS	
1ST FLOOR	1,004	5
2ND FLOOR	3,105	15
3RD FLOOR	3,105	15
4TH FLOOR	3,105	15
5TH FLOOR	3,105	15
6TH FLOOR	3,105	15
7TH FLOOR	3,105	15
8TH FLOOR	2,680	13
9TH FLOOR	2,680	13
EXTERIOR RECREATION SPACE = 15 GROS	SS	
REAR YARD	1,725	115
8TH FLOOR	306	20
COMMUNITY ROOM = 15 GROSS		
1ST FLOOR (COMMUNITY ROOM)	335	22
RESIDENTIAL LAUNDRY = 100 GROSS SF		
8TH FLOOR LAUNDRY ROOM	429	4

INCIDENTAL USE AREAS			
ACCESSORY STORAGE AREAS, M	ECHANICAL EQUIPMENT ROOMS (300	GROSS SF PER P	ERSON)
FOR ACCESSORY STORAGE AREA	S, TRASH COMPACTION ROOM, MECI	1. AND EQUIP. RMS	S.)
1ST FLOOR	1,069	4	

EXIT AND ACCESS REQUIREMENTS PART I MAXIMUM EXIT ACCESS TRAVEL CORRIDORS DISTANCE (FT) - TABLE 1016.1 MAX. DEAD END (LENGTH WIDTH IN FT) (IN.) SECTION SECTION 1018.4 R-2 **RESIDENTIAL** 150 200

EXIT AND ACCESS REQUIREMENTS PART II

			REQUIRED W INCH - BC		WIDTHS	PROVIDED
FLOOR	(SEPARATE MEANS OF EGRESS FOR EACH OCCUPANCY)	GROUP DESIGNATION	OTHER EGRESS COMPONENTS (0.2" PER OCCUPANT SERVED) * EXIT DOOR WIDTH OF 36" - CAPCITY OF 180 PPL CORRIDOR WIDTH OF 60" - CAPCITY OF 120 PPL	STAIRWAYS (0.3" PER OCCUPANT SERVED) (2) STAIRS WITH WIDTH OF 36" EACH - CAPCITY OF 120 PPL PER EACH STAIR	STAIRWAYS	OTHER EGRESS COMPONENTS (MIN)
9TH FL	.00R	R2	2.6	3.9	(2) 36	36
8TH FL	.00R	R2	7.4	11.1	(2) 36	36
2ND-7	TH FLOOR	R2	3.0	4.5	(2) 36	36
FIRST F	FLOOR	R2	29.2	NA	NA	36

CHAPTER 10: MEANS OF EGRESS - CONT

TABLE 1015.1 NUMBER OF EXITS

OCCUPANCY	MAXIMUM OCCUPANTS ALLOWED IN SPACES WITH ONE MEANS OF EGRESS	MAXIMUM OCCUPANCY OF PROVIDED SPACES	NUMBER OF MEANS OF EGRESS PROVIDED
R-2	20	51	2

ACCESSIBILITY

UNIT TYPE	MOBILITY IMPAIRED	HEARING/VISION IMPAIRED
0 BEDROOM	N/A	3A
1 BEDROOM	2B	N/A
2 BEDROOM	4C	N/A

SPECIAL INSPECTIONS

ALL METHODS AND CONSTRUCTION COMPONENTS / ASSEMBLIES REQUIRING SPECIAL INSPECTION SHALL BE INSPECTED AND TESTED WHEN REQUIRED TO VERIFY COMPLIANCE WITH THE BUILDING CODE. ALL REQUIRED SPECIAL INSPECTIONS AND TESTS SHALL BE CONDUCTED BY OR SUPERVISED BY AN ARCHITECT OR PROF. ENGINEER AUTHORIZED BY THE DEPARTMENT OF BUILDINGS ON BEHALF OF THE OWNER AND AS IDENTIFIED BY THE DESIGN ARCHITECT OF RECORD. ALL SPECIAL INSPECTIONS AND TESTS SHALL BE RECORDED AND MADE AVAILABLE TO THE DEPT. OF BUILDINGS FOR AT LEAST 6 YEARS.

INSPECTION	SECTION
STRUCTURAL STEEL - WELDING	BC 1704.3.1
STRUCTURAL STEEL - DETAILING	BC 1704.3.2
STRUCTURAL STEEL - HIGH STRENGTH BOLTING	BC 1704.3.3
STRUCTURAL COLD-FORMED STEEL	BC 1704.4
CONCRETE - CAST IN PLACE	BC 1704.4
CONCRETE - PRECAST	BC 1704.4
MASONRY	BC 1704.5
WALL PANELS, CURTAIN WALLS, AND VENEERS	BC 1704.10
SPRAYED FIRE-RESISTANT MATERIALS	BC 1704.11
MECHANICAL SYSTEMS	BC 1704.16
PRIVATE ON-SITE STORM WATER DRAINAGE DISPOSAL SYSTEMS, AND	BC 1704.21.2
DETENTION FACILITIES INSTALLATION	
SPRINKLER SYSTEMS	BC 1704.23
STANDPIPE SYSTEMS	BC 1704.24
HEATING SYSTEMS	BC 1704.25
CHIMNEYS	BC 1704.26
FIRE-RESISTANT PENETRATIONS AND JOINTS	BC 1704.27
CONCRETE DESIGN MIX	BC 1905.3 BC 1913.5
CONCRETE SAMPLING AND TESTING	BC 1905.6 BC 1913.1

PROGRESS INSPECTIONS

INSPECTION	<u>SECTION</u>
FOOTING AND FOUNDATION	BC 110.3.1
ENERGY CODE COMPLIANCE INSPECTIONS	BC 110.3.5
FIRE-RESISTANCE RATED CONSTRUCTION	BC 110.3.4
	28-116.2.4.2 BC 110.5

ENERGY CODE PROGRESS INSPECTIONS

- PROTECTION OF FOUNDATION INSULATION - INSULATION PLACEMENT AND R VALUES - FENESTRATION THERMAL VALUES AND RATINGS	5000-01(h) (1) and (2 (IA1), (IIA1) (IA2), (IIA2) (IA3), (IIA3) (IA4), (IIA4) (IA5), (IIA5) (IA6), (IIA6)
- INSULATION PLACEMENT AND R VALUES	(IA2), (IIA2) (IA3), (IIA3) (IA4), (IIA4) (IA5), (IIA5) (IA6), (IIA6)
	(IA3), (IIA3) (IA4), (IIA4) (IA5), (IIA5) (IA6), (IIA6)
- FENESTRATION THERMAL VALUES AND RATINGS	(IA4), (IIA4) (IA5), (IIA5) (IA6), (IIA6)
	(IA5), (IIA5) (IA6), (IIA6)
- FENESTRATION RATINGS FOR AIR LEAKAGE	(IA6), (IIA6)
- FENESTRATION AREAS	(IA6), (IIA6)
- AIR SEALING AND INSULATION - VISUAL	(147)
- AIR SEALING AND INSULATION - TESTING	(IA7)
- DAMPERS INTEGRAL TO BUILDING ENVELOPE	(IB2), (IIB2)
- HVAC AND SERVICE WATER HEATING EQUIPMENT	(IB3), (IIB3)
- HVAC AND SERVICE WATER HEATING SYSTEM CONTROLS	(IB4), (IIB4)
- DUCT PLENUM AND PIPING INSULATION AND SEALING	(IB5), (IIB5)
- DUCT LEAKAGE TESTING	(IB6, (IIB6)
- ELECTRICAL METERING	(IC1), (IIC1)
- LIGHTING IN DWELLING UNITS	(IC2), (IIC2)
- INTERIOR LIGHTING POWER	(IIC3)
- EXTERIOR LIGHTING POWER	(IIC4)
- LIGHTING CONTROLS	(IIC5)
- EXIT SIGNS	(IIC6)
- TANDEM WIRING	(IIC7)
- ELECTRICAL MOTORS	(IIC8)
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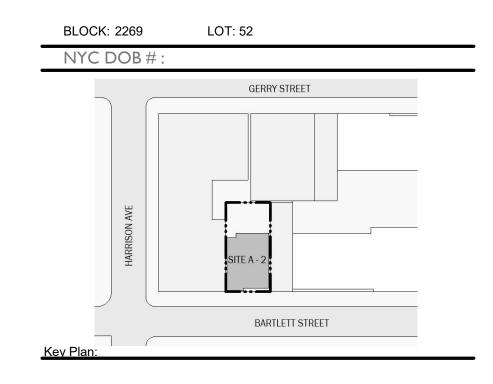
SEISMIC DESIGN CATEGORY

STRUCTURAL OCCUPANCY/RISK CATEGORY AND IMPORTANCE FACTOR II PER NYC BC 1604.5 SEISMIC CATEGORY B

BARTLETT CROSSING

SITE A-2 31 BARTLETT ST, BROOKLYN NY





NUMBER DATE



Architect:

Magnusson Architecture & Planning PC 42 West 39th Street 15th Floor

New York NY 10018 Tel (212) 253 7820 Fax (212) 253 1276 Structural Engineer:

CityScape Engineering PLLC 8 Haven Ave., Port Washington NY 11050 Tel (631) 978-5000 MEP Engineer: Loring Consulting Engineers

360 West 31st Street, New York, NY 10001 Tel (646) 674-6100 Landscape Architect: Terrain-NYC Landscape Architects 203 Lafayette Street, New York, NY 10012

Tel (212) 537-6080 Client Representative:

Filing Representative:

Do Not Scale Plans Contractor to promptly notify Architect of any material variations between field conditions and existing conditions as indicated in Contract documents

NYC BUILDING CODE ANALYSIS

SEAL & SIGNATURE: PROJECT No: DRAWING BY: CHK BY: DWG No:

NOTES TO USERS

This map is for use in administering the National Flood Insurance Program. It does not necessarily identify all areas subject to flooding, particularly from local drainage sources of small size. The **community map repository** should be consulted for possible updated or additional flood hazard information.

To obtain more detailed information in areas where **Base Flood Elevations** (BFEs) and/or **floodways** have been determined, users are encouraged to consult the Flood Profiles and Floodway Data and/or Summary of Stillwater Elevations tables contained within the Flood Insurance Study (FIS) report that accompanies this FIRM. Users should be aware that BFEs shown on the FIRM represent rounded whole-foot elevations. These BFEs are intended for flood insurance rating purposes only and should not be used as the sole source of flood elevation information. Accordingly, flood elevation data presented in the FIS report should be utilized in conjunction with the FIRM for purposes of construction and/or floodplain management.

Coastal Base Flood Elevations (BFEs) shown on this map apply only landward of 0.0' National Geodetic Vertical Datum of 1929 (NGVD 29). Users of this FIRM should be aware that coastal flood elevations are also provided in the Summary of Stillwater Elevations tables in the Flood Insurance Study report for this jurisdiction. Elevations shown in the Summary of Stillwater Elevations tables should be used for construction and/or floodplain management purposes when they are higher than the elevations shown on this FIRM.

Boundaries of the **floodways** were computed at cross sections and interpolated between cross sections. The floodways were based on hydraulic considerations with regard to requirements of the National Flood Insurance Program. Floodway widths and other pertinent floodway data are provided in the Flood Insurance Study report for this jurisdiction.

Certain areas not in Special Flood Hazard Areas may be protected by **flood control structures**. Refer to Section 2.4 "Flood Protection Measures" of the Flood Insurance Study report for information on flood control structures for this jurisdiction.

The **projection** used in the preparation of this map was New York State Plane FIPSZONE 3104. The **horizontal datum** was NAD 83, GRS80 spheroid. Differences in datum, spheroid, projection or State Plane zones used in the production of FIRMs for adjacent jurisdictions may result in slight positional differences in map features across jurisdiction boundaries. These differences do not affect the accuracy of this FIRM.

Flood elevations on this map are referenced to the National Geodetic Vertical Datum of 1929. These flood elevations must be compared to structure and ground elevations referenced to the same **vertical datum**. For information regarding conversion between the National Geodetic Vertical Datum of 1929 and the North American Vertical Datum of 1988, visit the National Geodetic Survey website at http://www.ngs.noaa.gov or contact the National Geodetic Survey at the following address:

NGS Information Services NOAA, N/NGS12 National Geodetic Survey SSMC-3, #9202 1315 East-West Highway Silver Spring, Maryland 20910-3182 (301) 713-3242

To obtain current elevation, description, and/or location information for bench marks shown on this map, please contact the Information Services Branch of the National Geodetic Survey at (301) 713-3242, or visit its website at http://www.ngs.noaa.gov.

Base map information shown on this FIRM was provided in digital format by the Department of Information Technology and Telecommunication, City of New York. This information was derived from digital orthophotos produced at a scale of 1:1,200 with 2-foot pixel resolution from photography dated 2004.

Based on updated topographic information, this map reflects more detailed and up-to-date **stream channel configurations and floodplain delineations** than those shown on the previous FIRM for this jurisdiction. As a result, the Flood Profiles and Floodway Data tables in the Flood Insurance Study Report (which contains authoritative hydraulic data) may reflect stream channel distances that differ from what is shown on this map. Also, the road to floodplain relationships for unrevised streams may differ from what is shown on previous maps.

Corporate limits shown on this map are based on the best data available at the time of publication. Because changes due to annexations or de-annexations may have occurred after this map was published, map users should contact appropriate community officials to verify current corporate limit locations.

Please refer to the separately printed **Map Index** for an overview map showing the layout of map panels for this jurisdiction.

Contact the **FEMA Map Service Center** at 1-800-358-9616 for information on available products associated with this FIRM. Available products may include previously issued Letters of Map Change, a Flood Insurance Study report, and/or digital versions of this map. The FEMA Map Service Center may also be reached by Fax at 1-800-358-9620 and its website at http://msc.fema.gov.

If you have **questions about this map** or questions concerning the National Flood Insurance Program in general, please call **1-877-FEMA MAP** (1-877-336-2627) or visit the FEMA website at http://www.fema.gov.



LEGEND SPECIAL FLOOD HAZARD AREAS SUBJECT TO INUNDATION BY THE 1% ANNUAL CHANCE FLOOD The 1% annual flood (100-year flood), also known as the base flood, is the flood that has a 1% chance of being equaled or exceeded in any given year. The Special Flood Hazard Area is the area subject to flooding by the 1% annual chance flood. Areas of Special Flood Hazard include Zones A, AE, AH, AO, AR, A99, V, and VE. The Base Flood Elevation is the water-surface elevation of the 1% annual chance flood. No Base Flood Elevations determined. ZONE AE Base Flood Elevations determined. Flood depths of 1 to 3 feet (usually areas of ponding); Base Flood Flood depths of 1 to 3 feet (usually sheet flow on sloping terrain); average depths determined. For areas of alluvial fan flooding, velocities also Special Flood Hazard Area formerly protected from the 1% annual chance flood by a flood control system that was subsequently decertified. Zone AR indicates that the former flood control system is being restored to provide protection from the 1% annual chance or greater flood. Area to be protected from 1% annual chance flood by a Federal flood protection system under construction; no Base Flood Elevations Coastal flood zone with velocity hazard (wave action); no Base Flood Coastal flood zone with velocity hazard (wave action); Base Flood FLOODWAY AREAS IN ZONE AE The floodway is the channel of a stream plus any adjacent floodplain areas that must be kept free in flood heights. OTHER FLOOD AREAS Areas of 0.2% annual chance flood; areas of 1% annual chance flood with ZONE X average depths of less than 1 foot or with drainage areas less than 1 square mile; and areas protected by levees from 1% annual chance flood. OTHER AREAS Areas determined to be outside the 0.2% annual chance floodplain. ZONE X Areas in which flood hazards are undetermined, but possible. COASTAL BARRIER RESOURCES SYSTEM (CBRS) AREAS OTHERWISE PROTECTED AREAS (OPAs) CBRS areas and OPAs are normally located within or adjacent to Special Flood Hazard Areas. 1% annual chance floodplain boundary 0.2% annual chance floodplain boundary Floodway boundary Zone D boundary CBRS and OPA boundary Boundary dividing Special Flood Hazard Area Zones and boundary dividing Special Flood Hazard Areas of different Base Flood Elevations, flood depths or flood velocities. Base Flood Elevation line and value; elevation in feet* ~~~ 513 ~~~ Base Flood Elevation value where uniform within zone; elevation * Referenced to the National Geodetic Vertical Datum of 1929

Cross section line

FIRM panel)

MAP REPOSITORY Refer to listing of Map Repositories on Map Index

June 28, 1974

FLOOD HAZARD BOUNDARY MAP REVISIONS

FLOOD INSURANCE RATE MAP EFFECTIVE

November 16, 1983

FLOOD INSURANCE RATE MAP REVISIONS

September 5, 2007 - to update map format, to change Special Flood Hazard Areas, and to reflect updated topographic information

River Mile

Geographic coordinates referenced to the North American

1000-meter Universal Transverse Mercator grid values, zone

5000-foot grid ticks: New York State Plane coordinate system, Long Island zone (FIPSZONE 3104), Lambert Conformal Conic

Bench mark (see explanation in Notes to Users section of this

Datum of 1983 (NAD 83), Western Hemisphere


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87°07'45", 32°22'30"

2476000mN

600000 FT

DX5510 ×

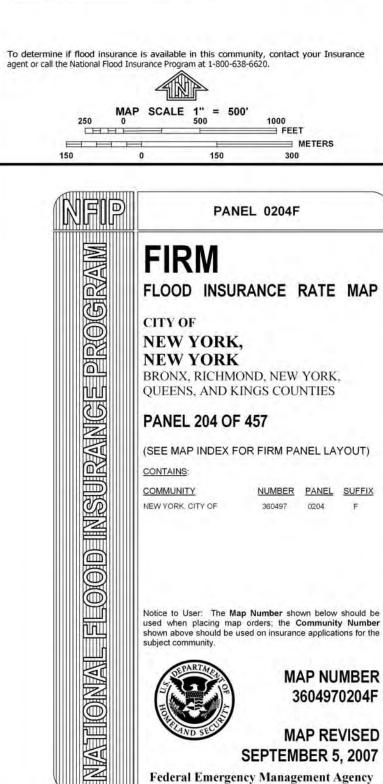

BARTLETT CROSSING SITE A-2 31 BARTLETT ST, BROOKLYN NY Owner: BLOCK: LOT: NYC DOB#: NUMBER DATE DESCRIPTION



Client Representative:

Landscape Architect:

Filing Representative:

Do Not Scale Plans
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FEMA FLOOD MAP


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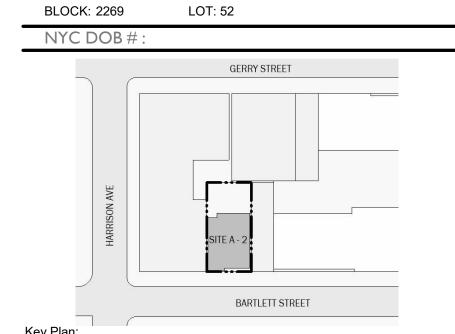
DWG No:



SITE A-2 31 BARTLETT ST, BROOKLYN NY

Owne



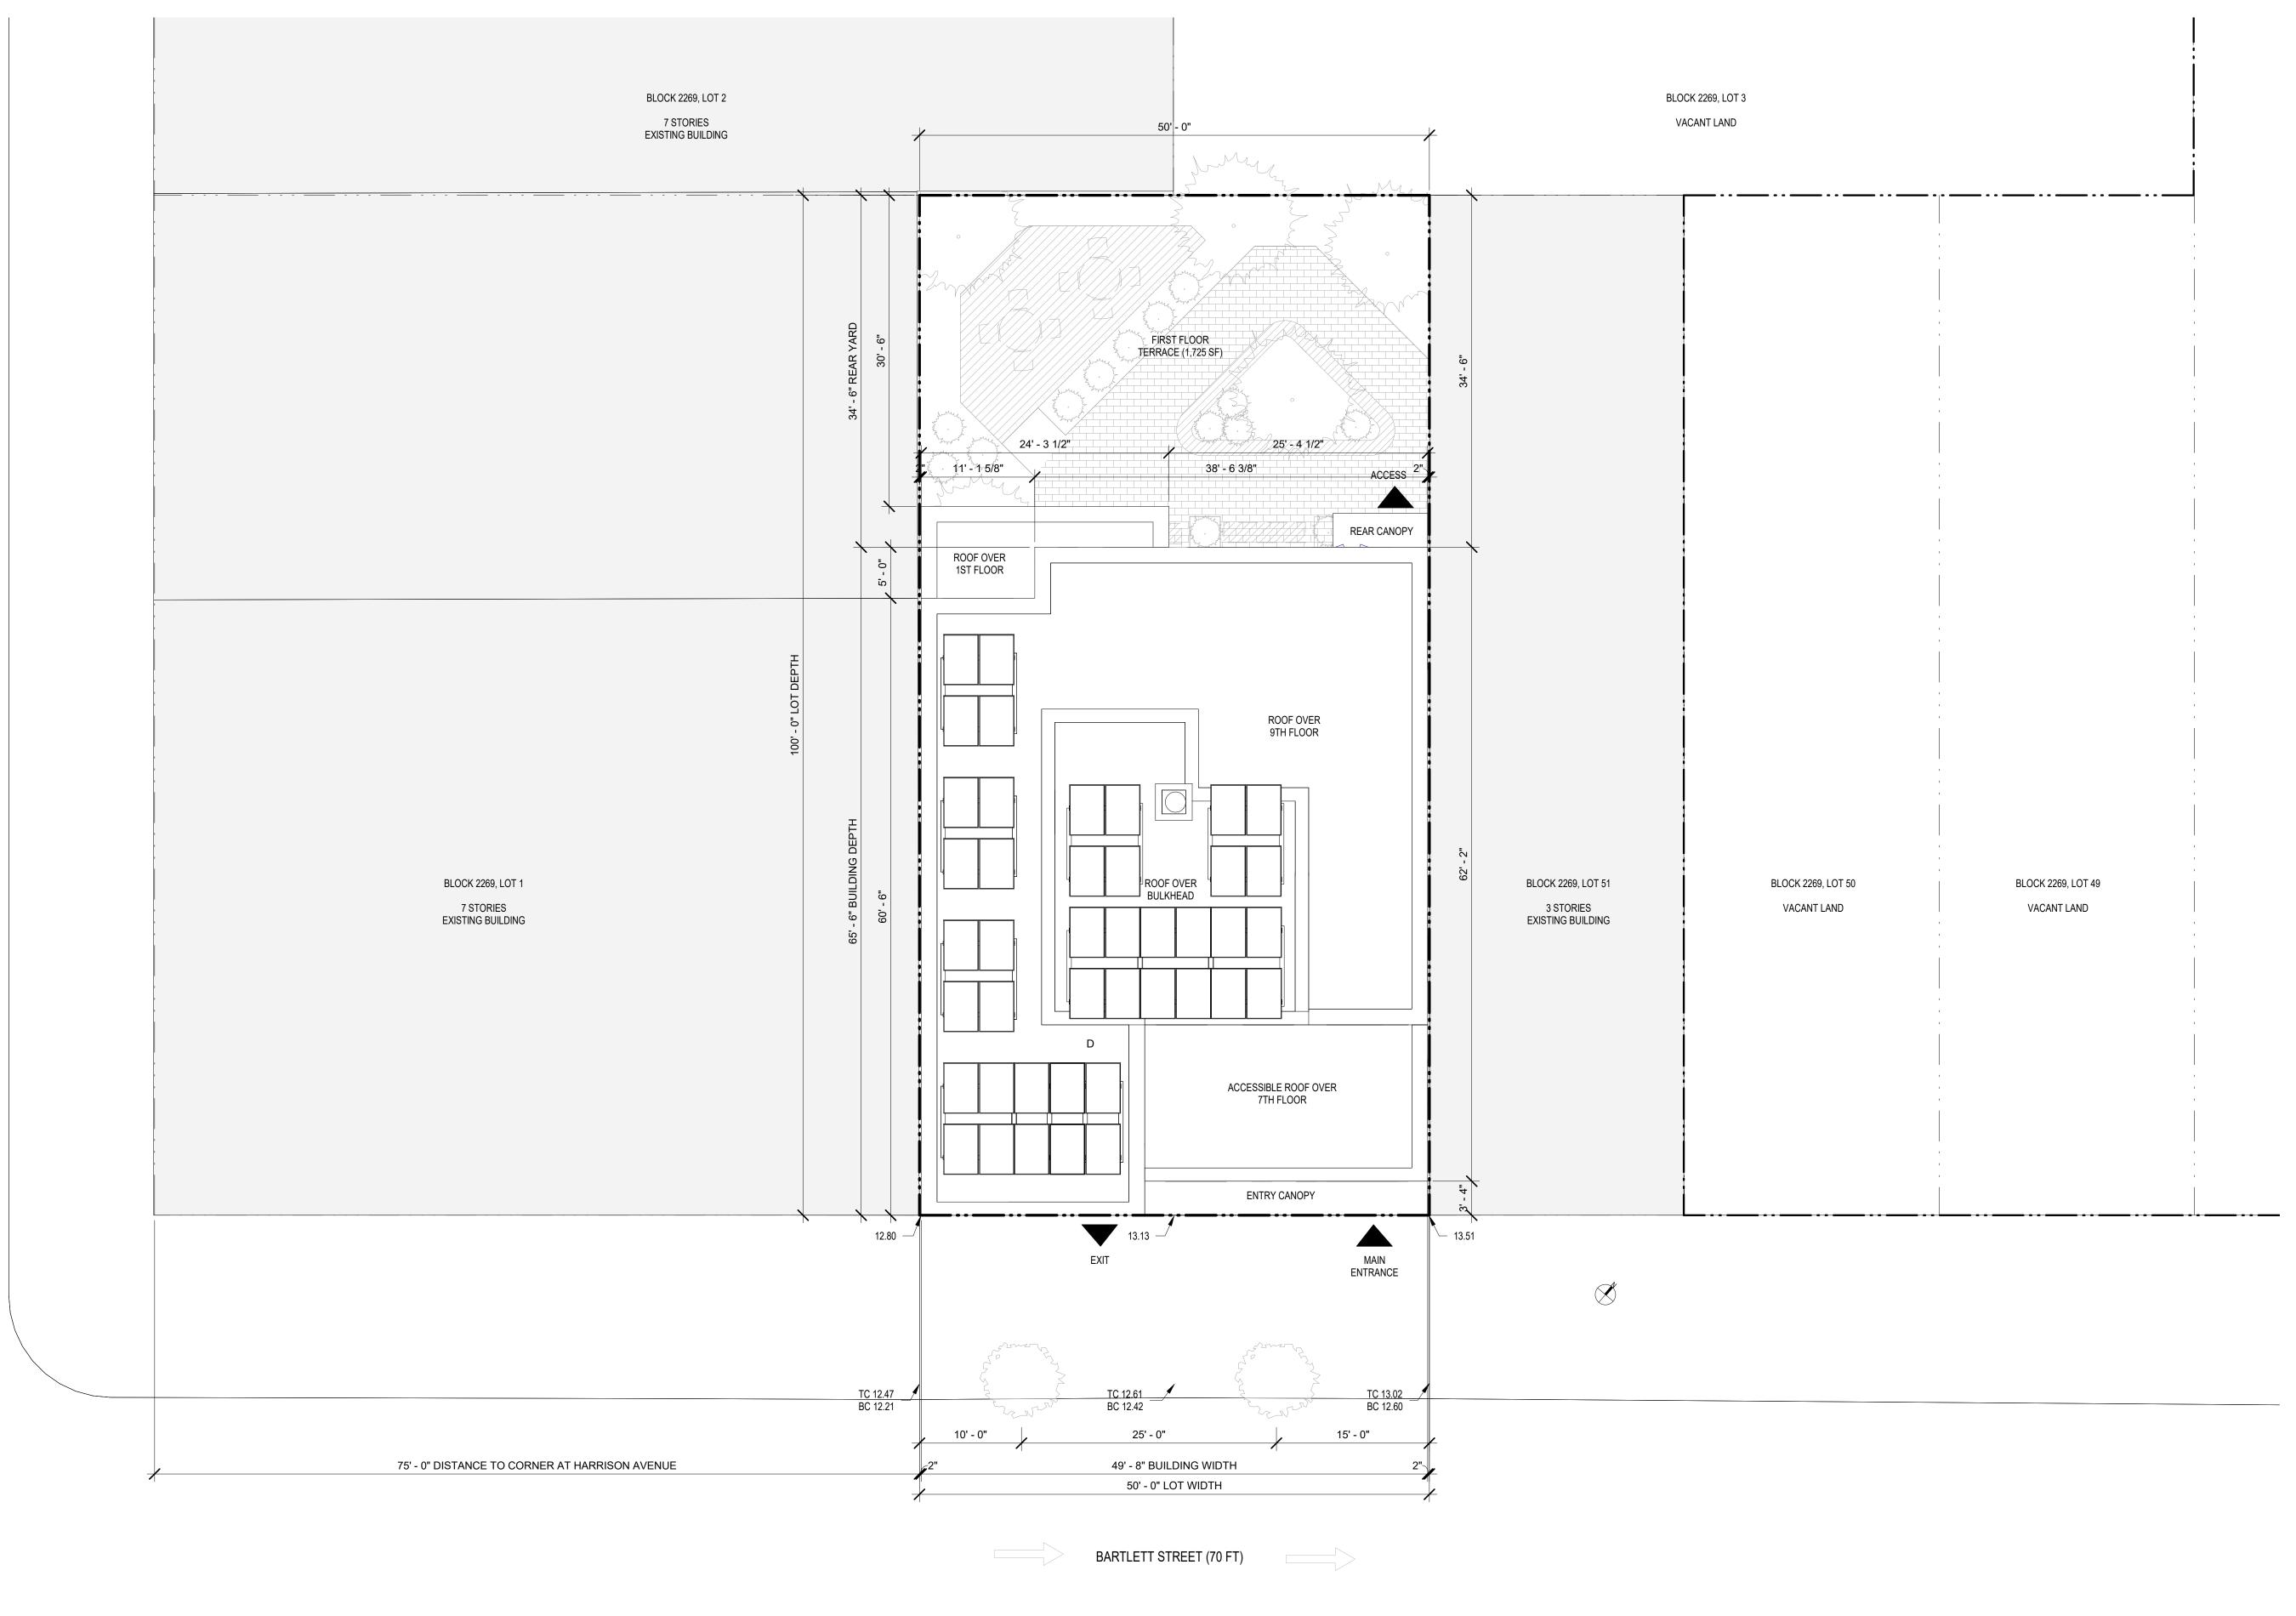

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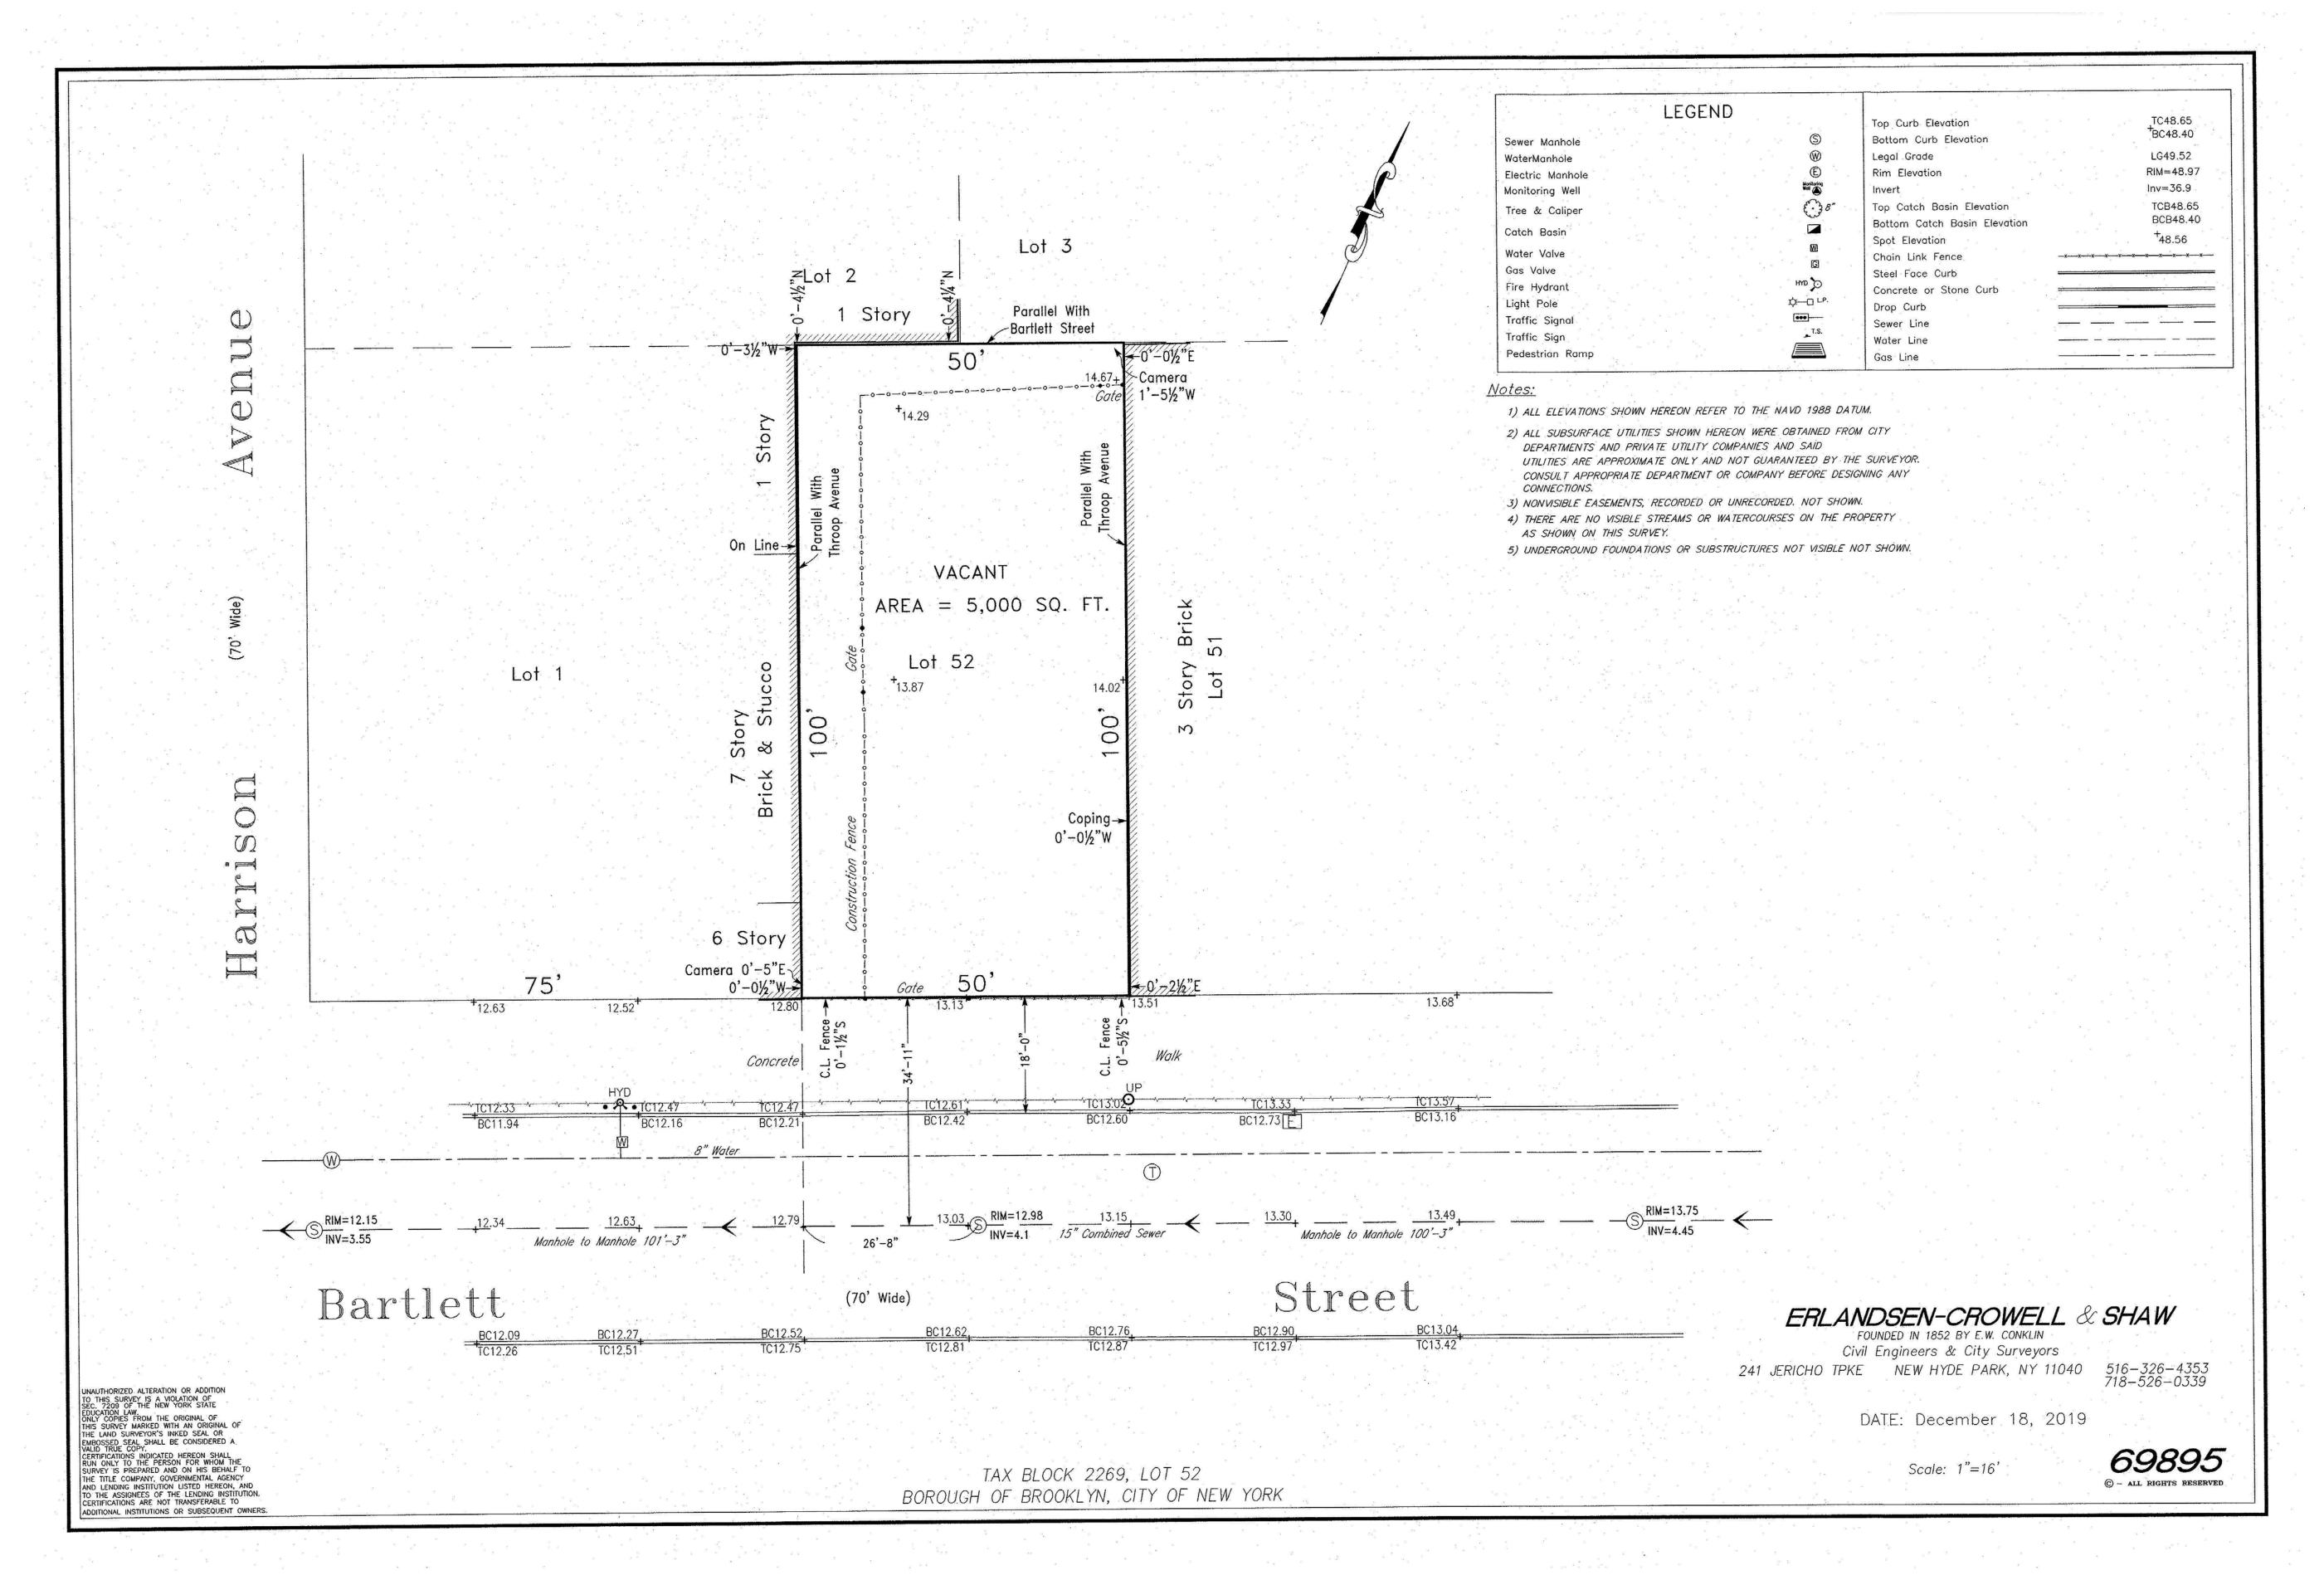
SITE PLAN

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	DWG No:	
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SCALE: 1/8" = 1'-0"

1 SITE PLAN 1/8" = 1'-0"


0' 4' 8' 16'



SITE A-2 31 BARTLETT ST, BROOKLYN NY

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SITE SURVEY

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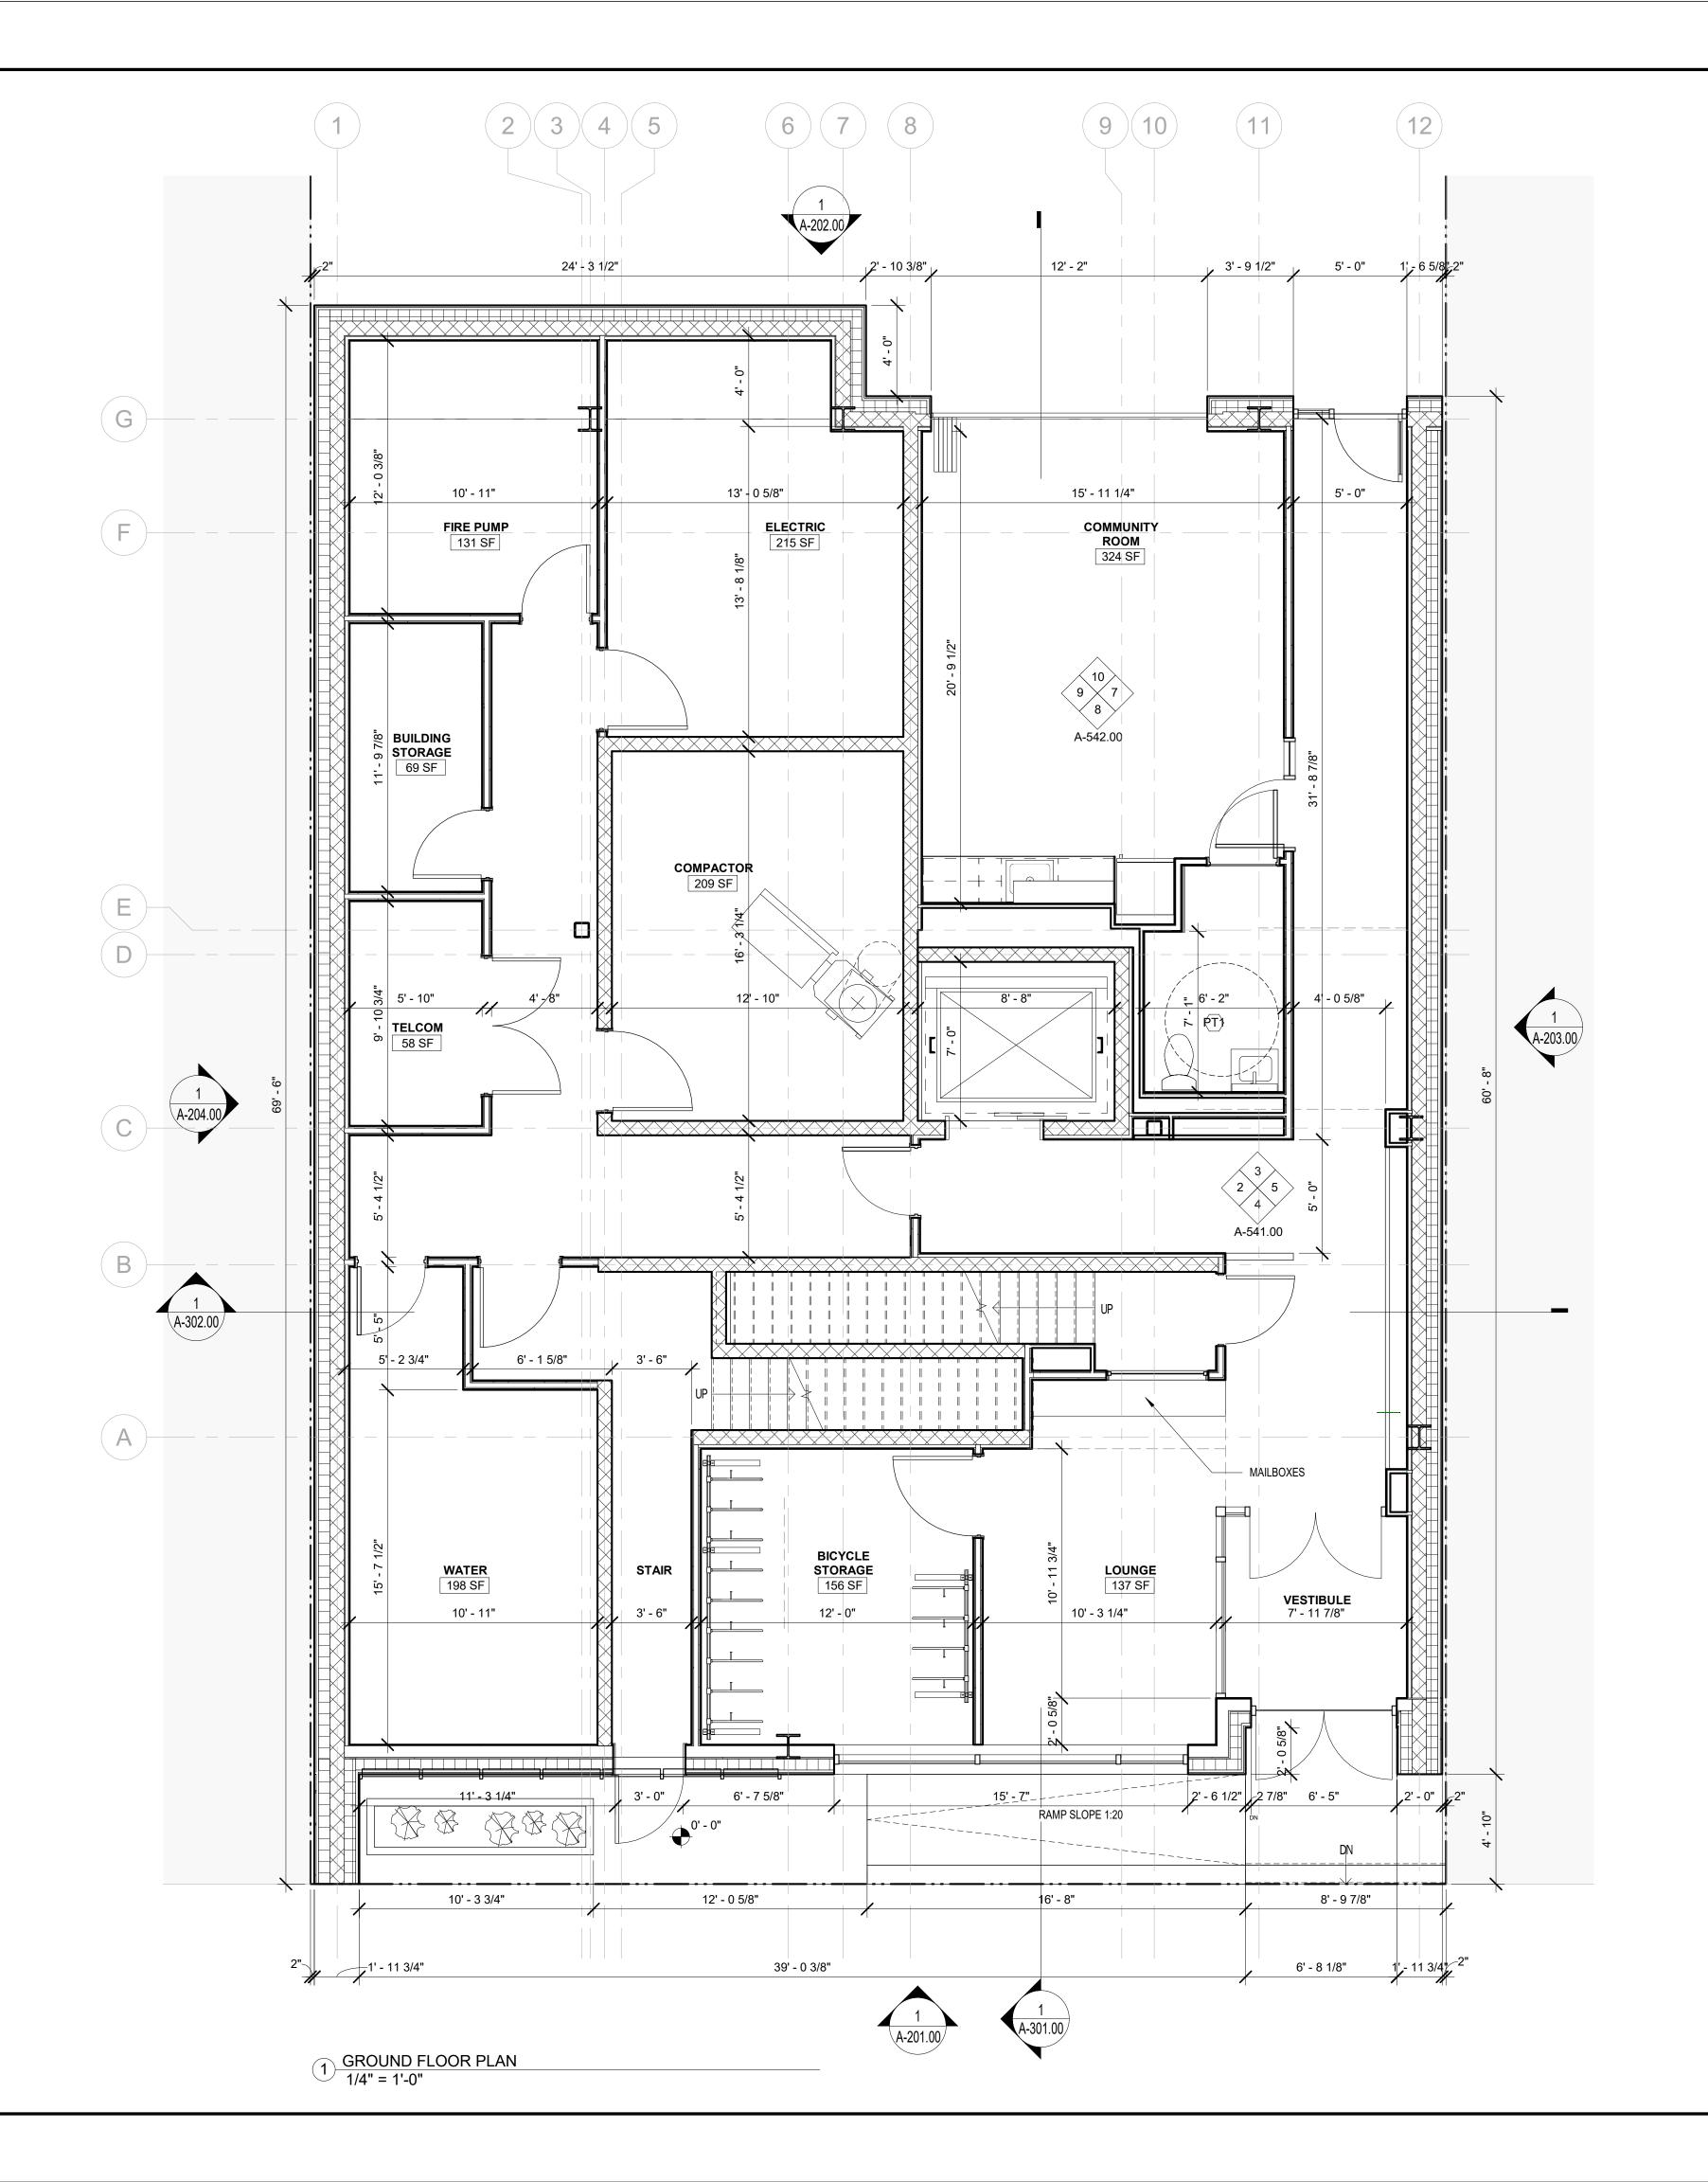
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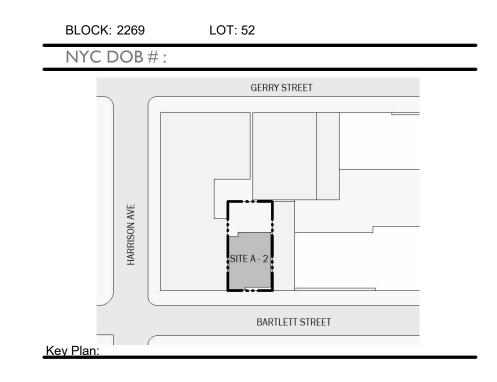
SCALE:

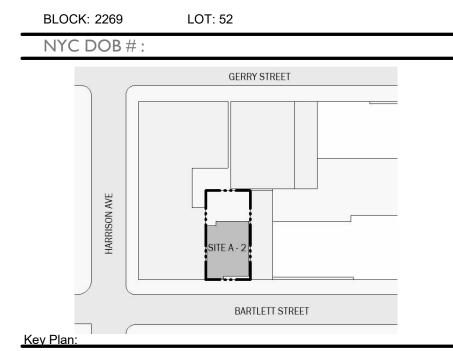

SITE A-2 31 BARTLETT ST, BROOKLYN NY

Owner





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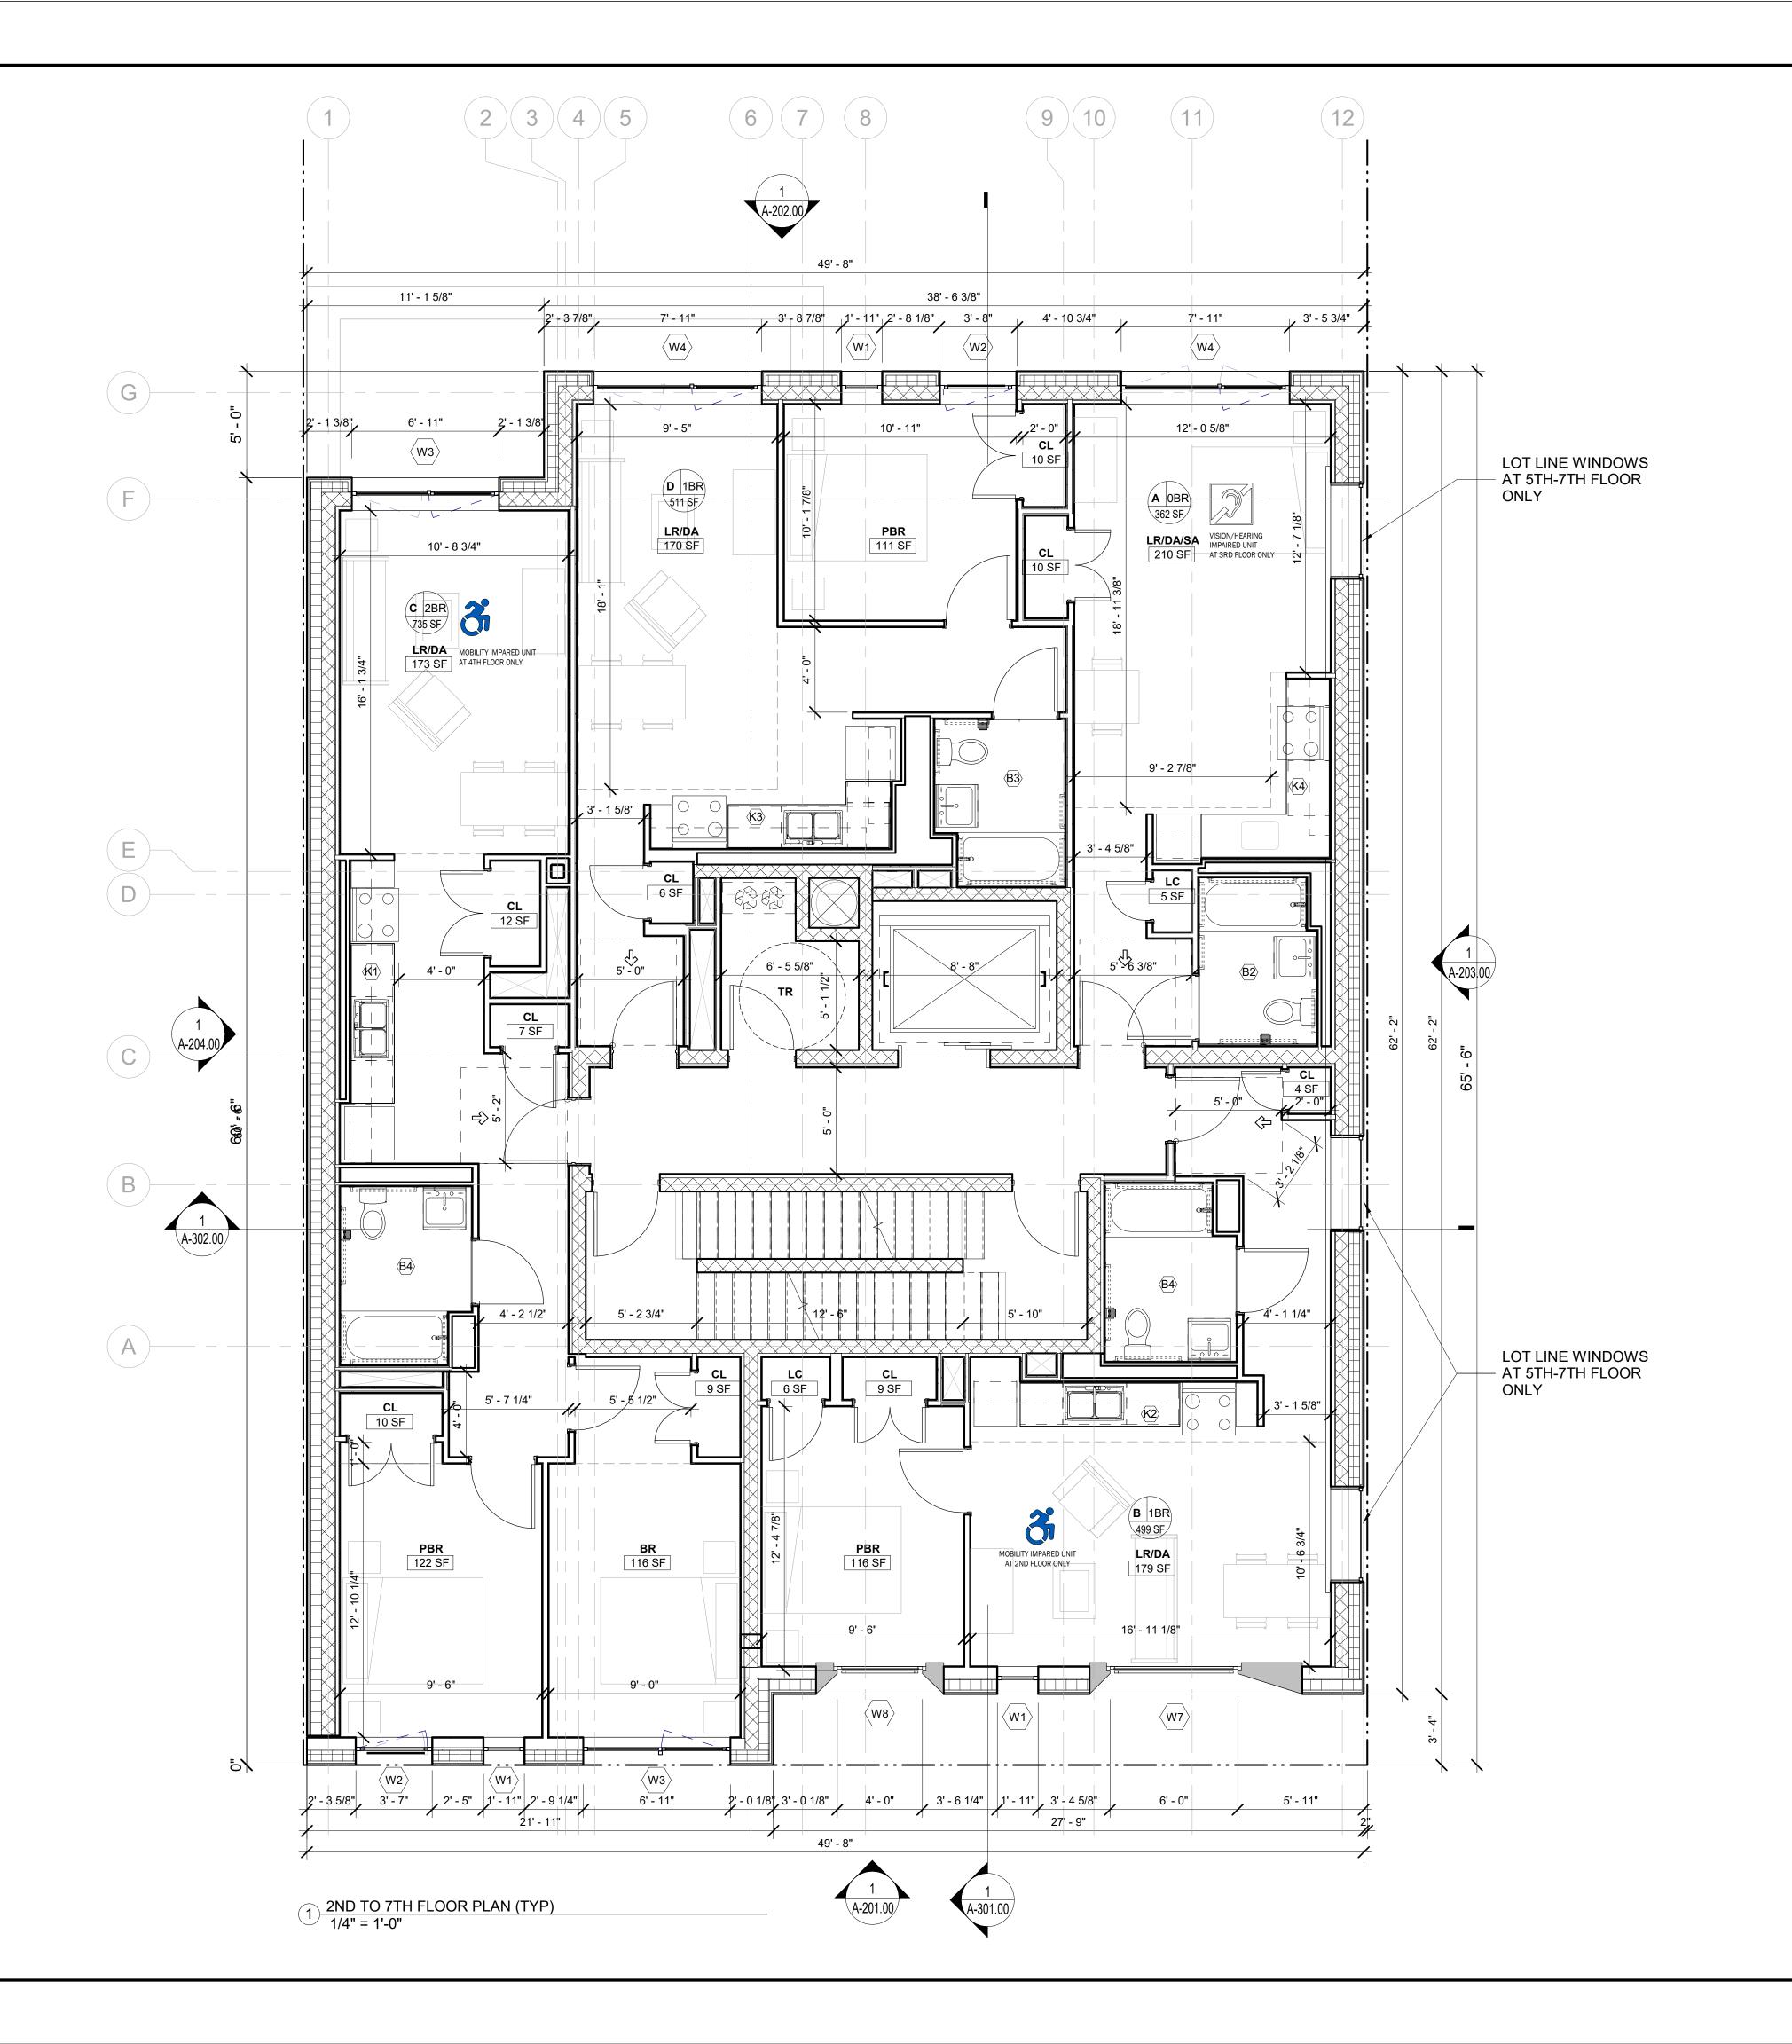
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GROUND FLOOR PLAN


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SITE A-2 31 BARTLETT ST, BROOKLYN NY

Owner





NUMBER DATE DESCRIPTION

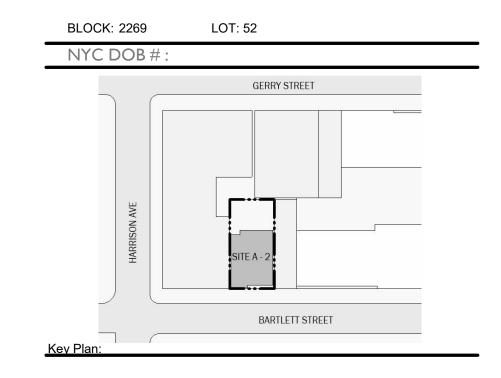MAP

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2ND TO 7TH TYPICAL FLOOR PLAN

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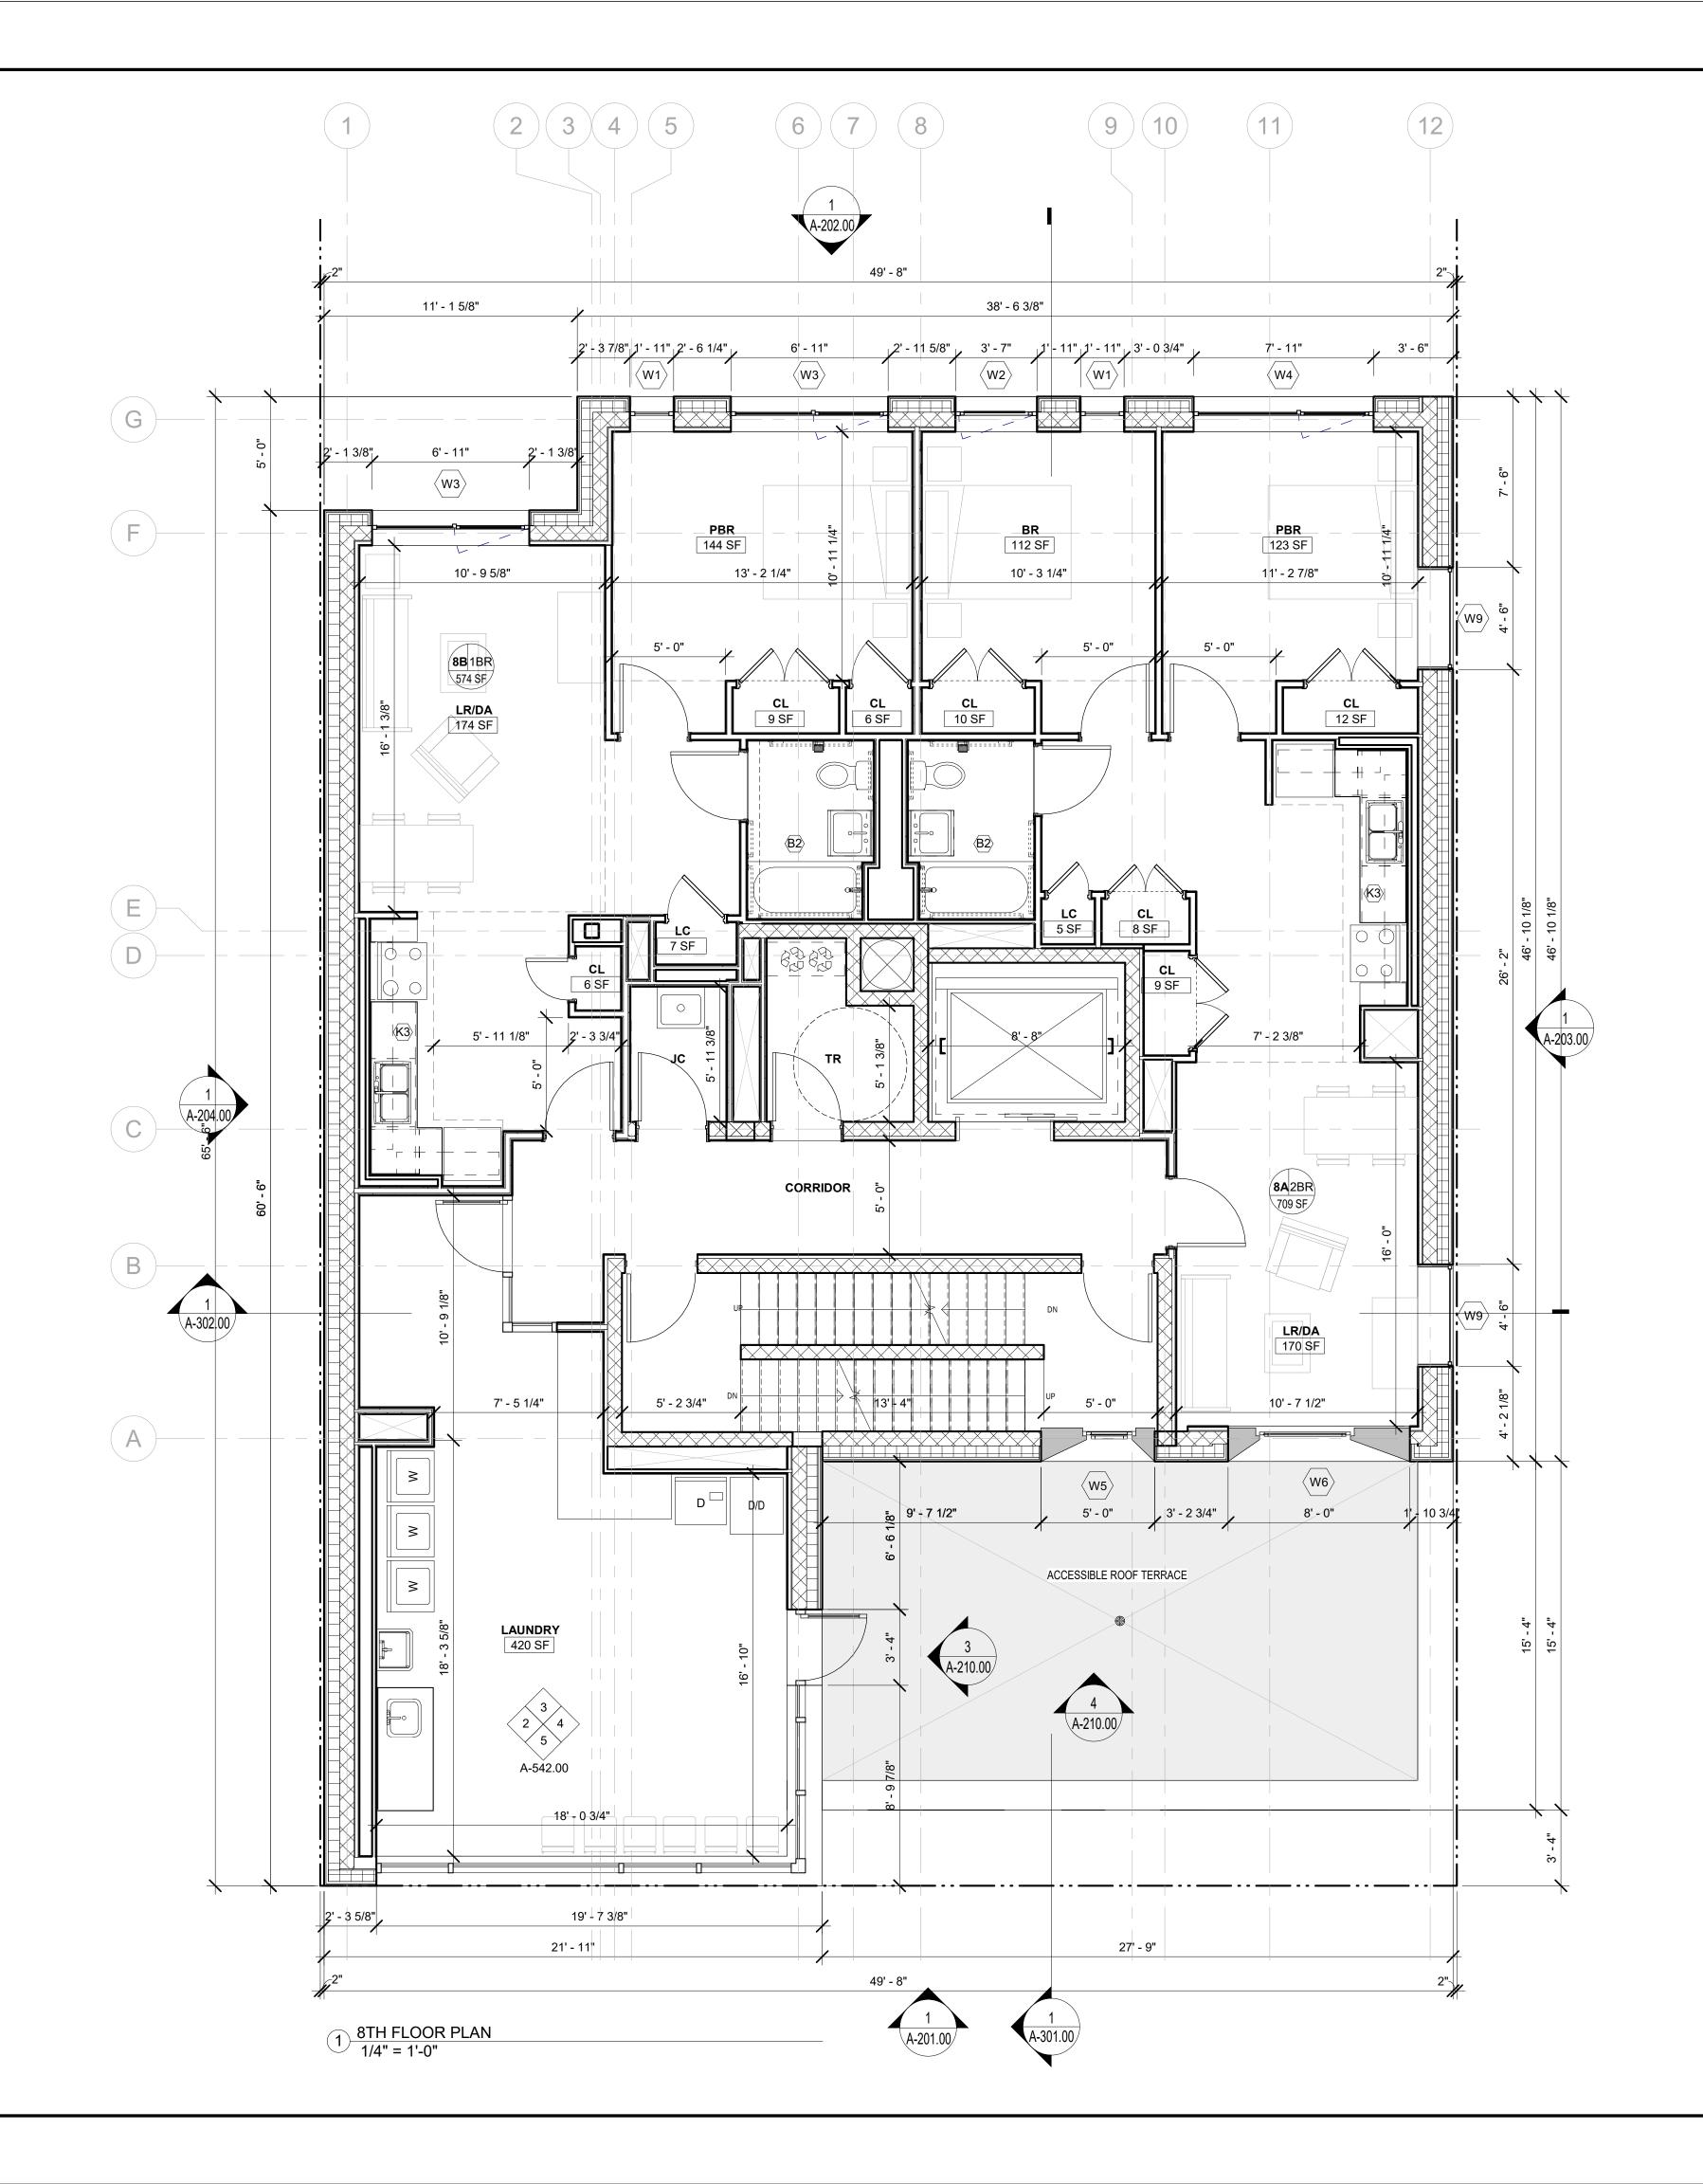
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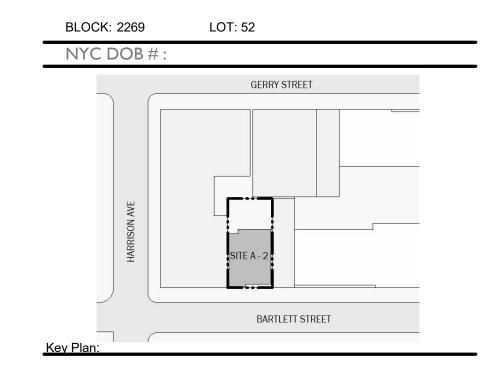
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SCALE:
1/4" = 1'-0"



SITE A-2 31 BARTLETT ST, BROOKLYN NY





NUMBER DATE DESCRIPTION

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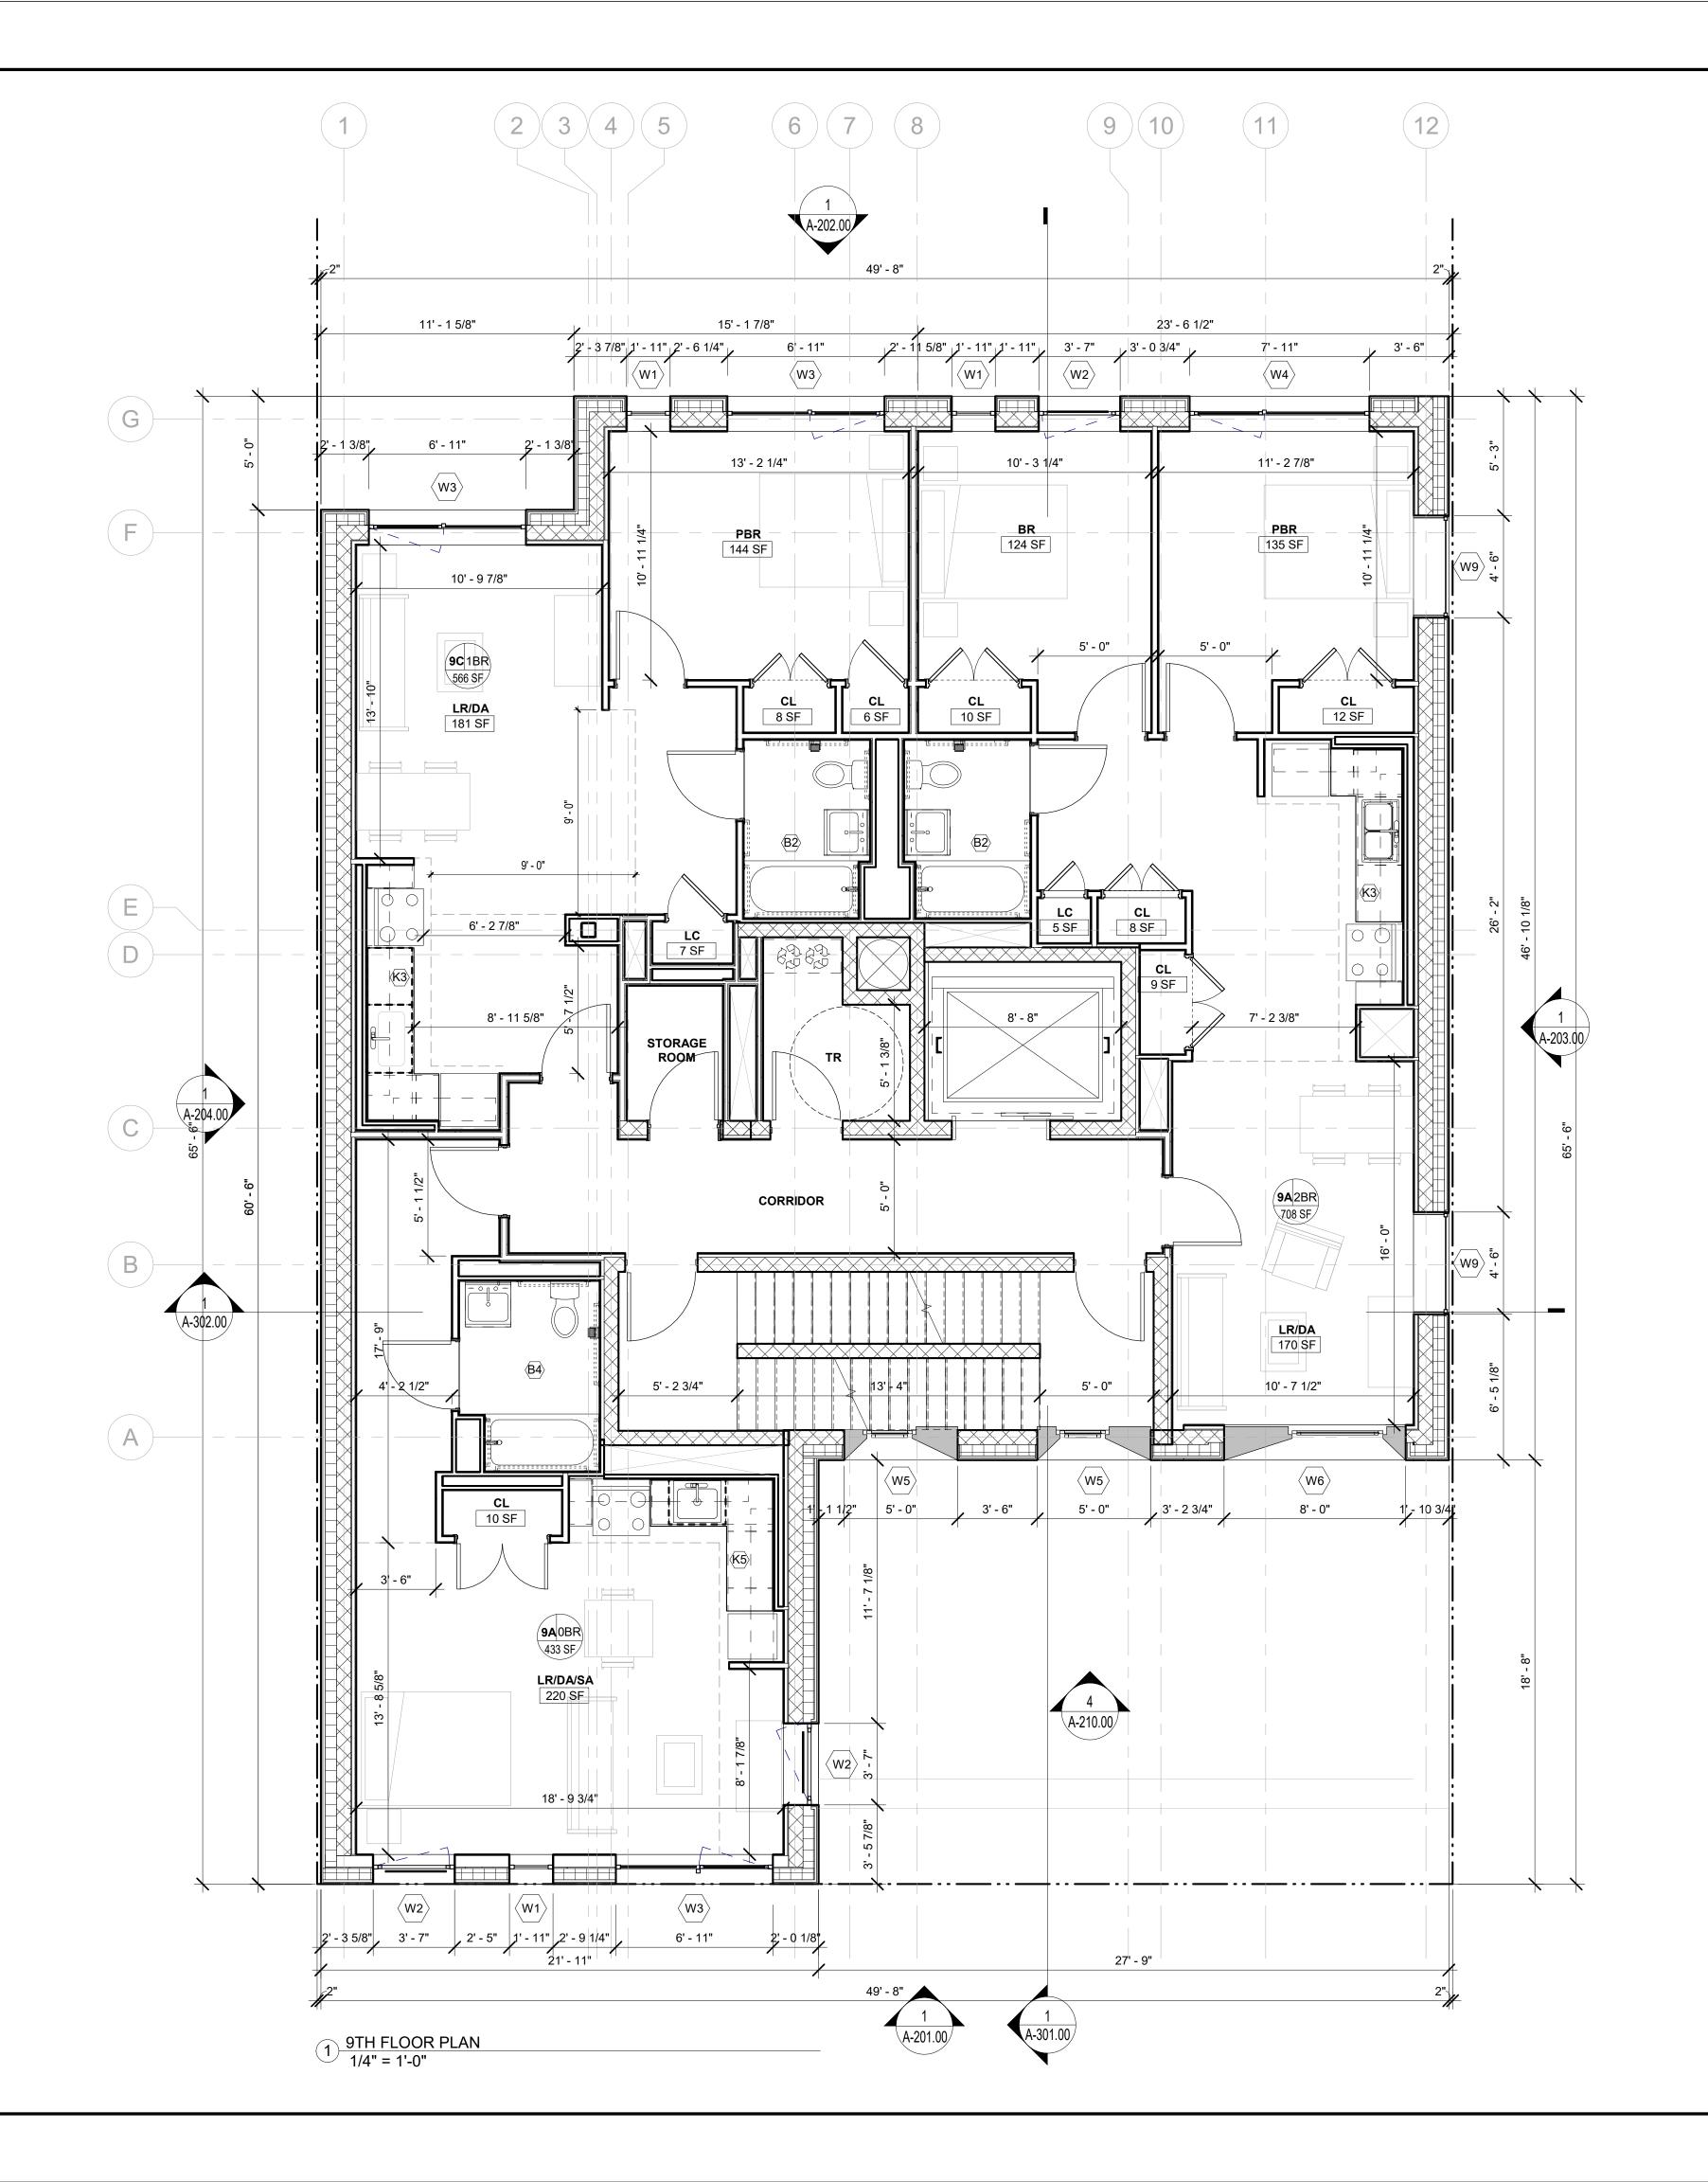
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8TH FLOOR PLAN

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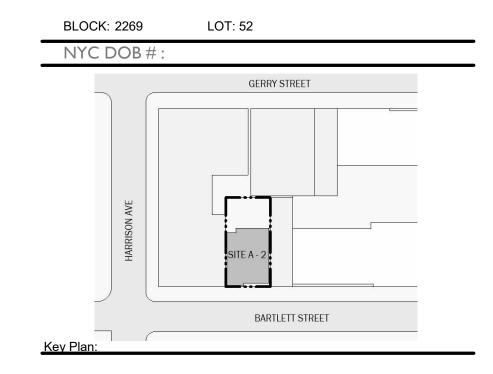
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SITE A-2 31 BARTLETT ST, BROOKLYN NY

Owner





NUMBER DATE DESCRIPTION

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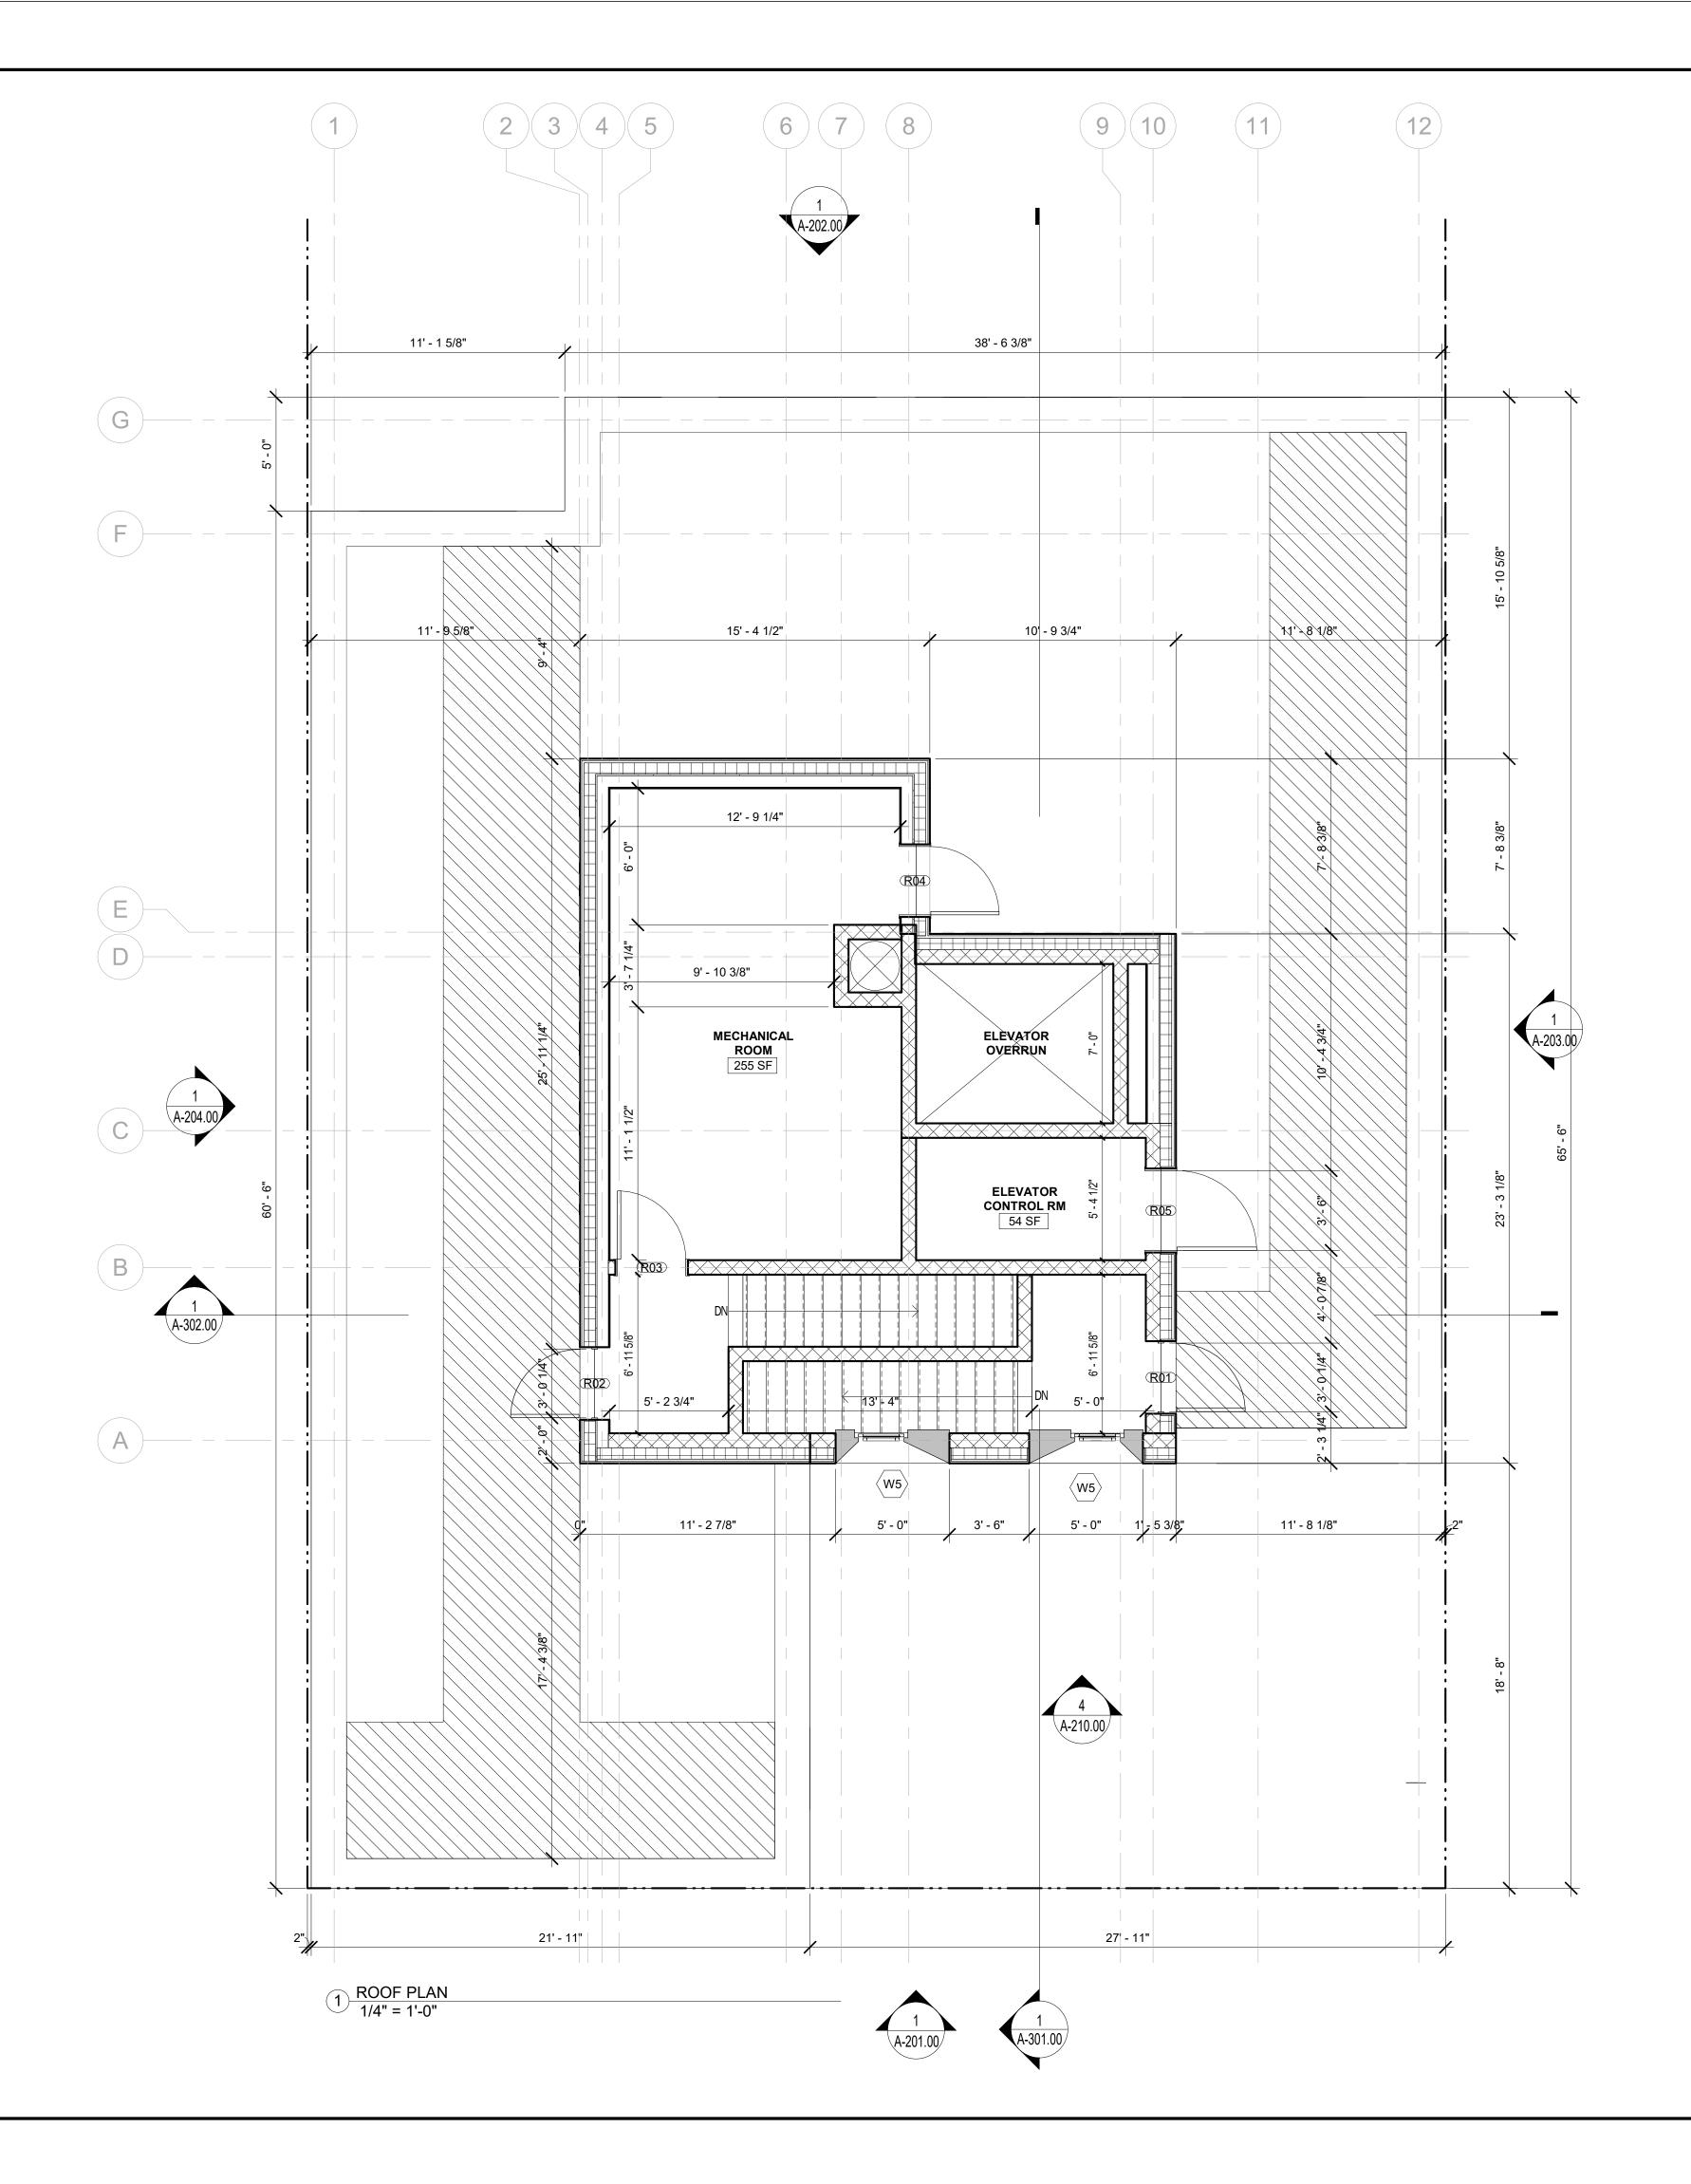
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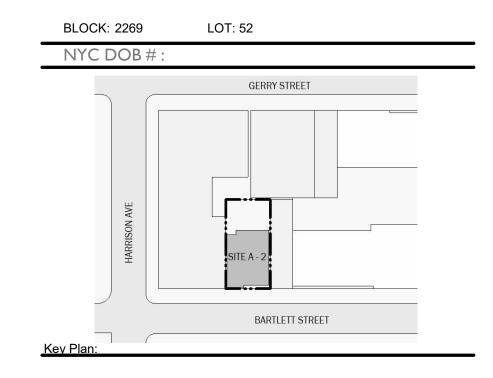
9TH FLOOR PLAN

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SEAL & SIGNATURE:	PROJECT No: 19022



SITE A-2 31 BARTLETT ST, BROOKLYN NY





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Landscape Architect:


Terrain-NYC Landscape Architects 203 Lafayette Street, New York, NY 10012 Tel (212) 537-6080 Client Representative:

Filing Representative:

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ROOF AND BULKHEAD PLAN


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SITE A-2 31 BARTLETT ST, BROOKLYN NY

Owr

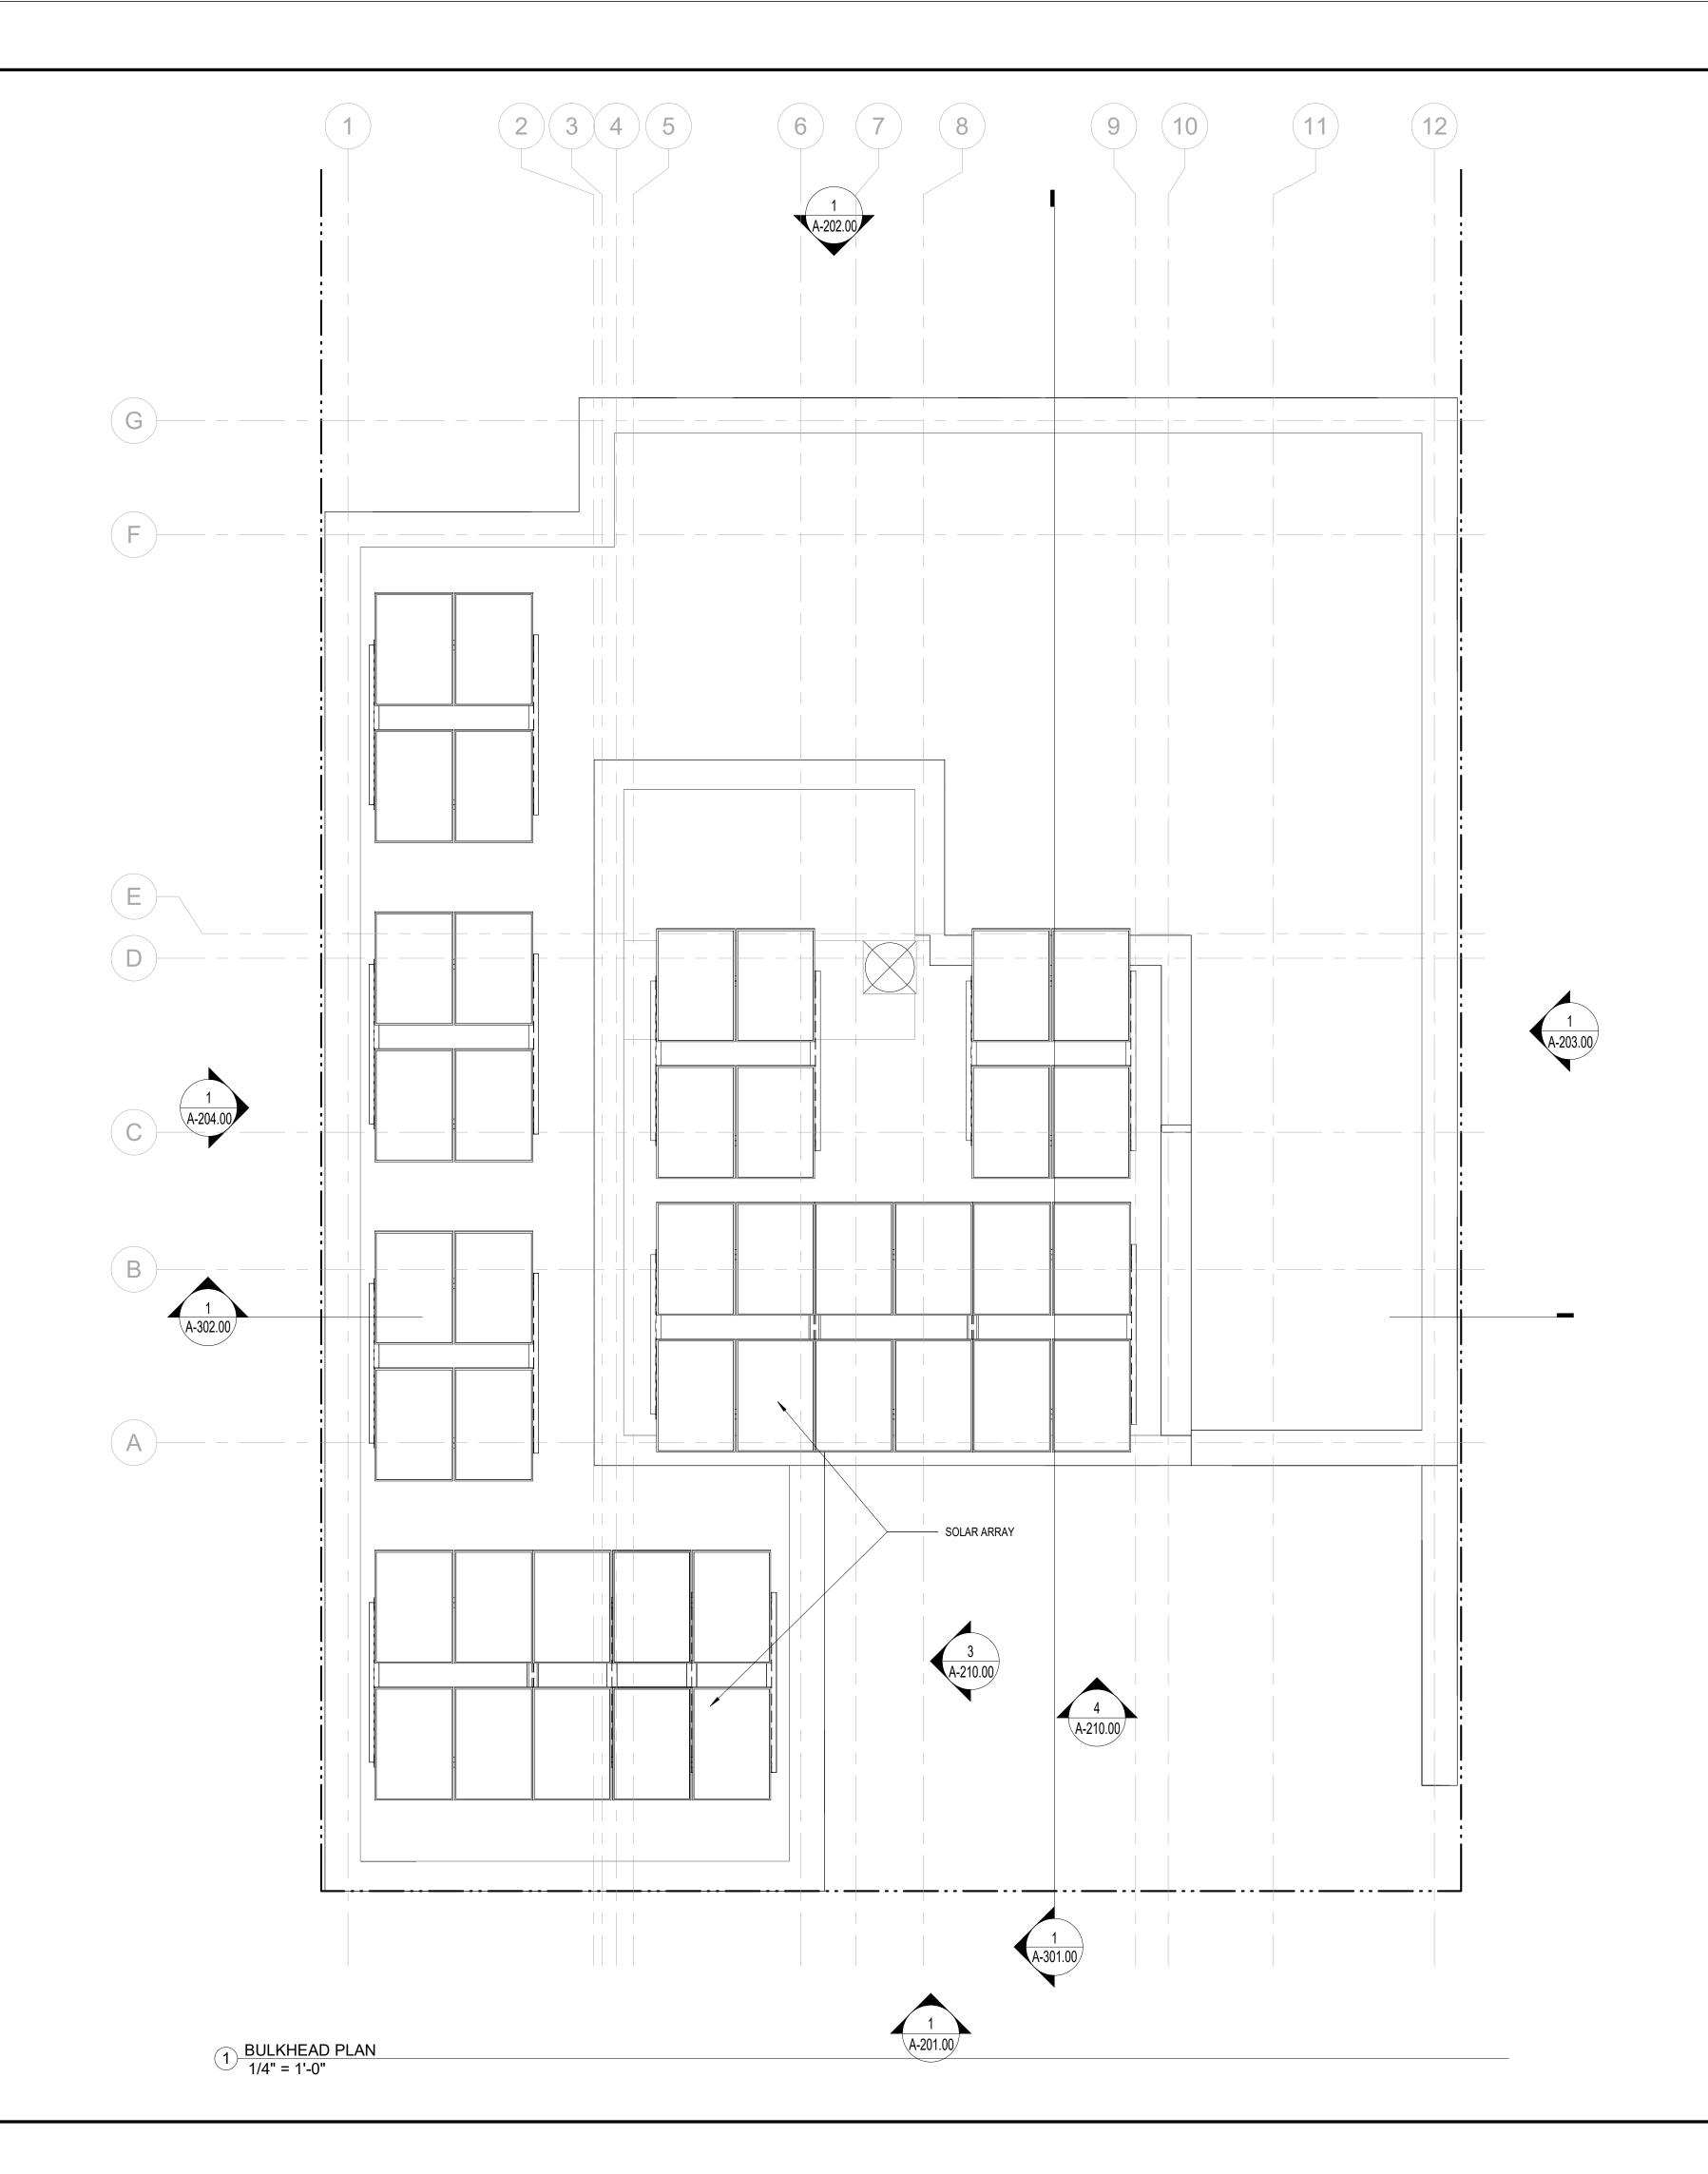



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Tel (212) 537-6080

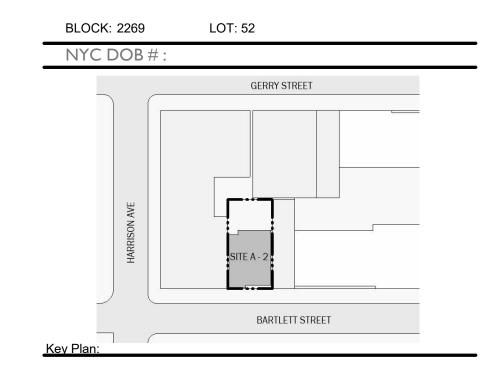Client Representative:


Filing Representative:

Do Not Scale Plans
Contractor to promptly notify Architect of any material variations between field conditions and existing conditions as indicated in Contract documents

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BULKHEAD PLAN

	A-1	12.00
	DWG No:	
	CHK BY:	Checker
	DRAWING BY:	Author
EAL & SIGNATURE:	PROJECT No:	19022

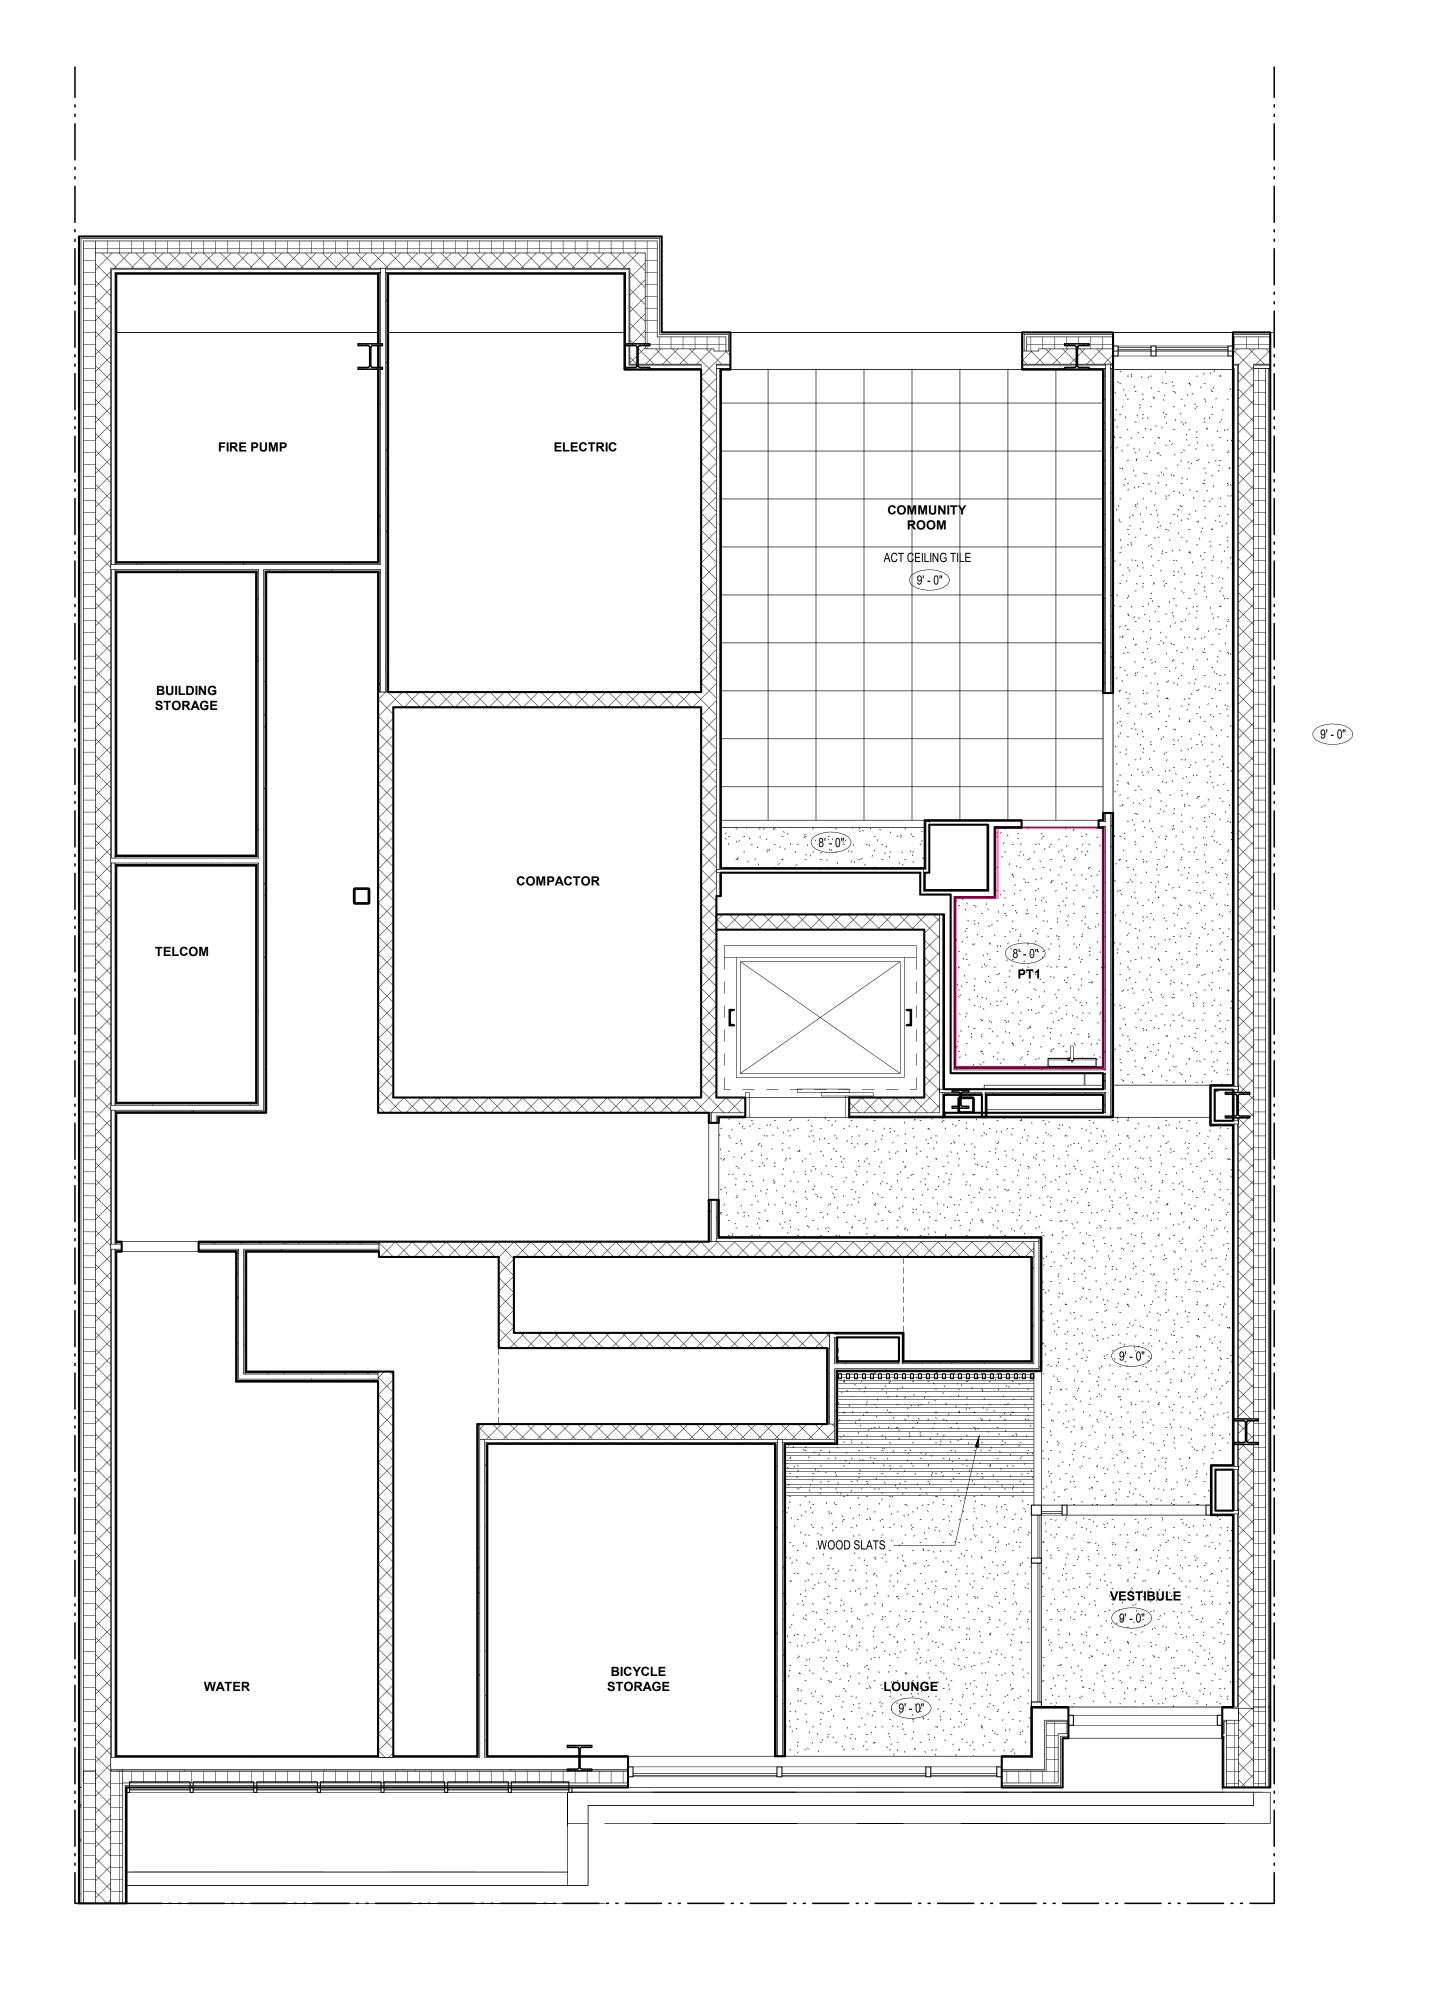


GROUND FLOOR RCP 1/4" = 1'-0"

BARTLETT CROSSING

SITE A-2 31 BARTLETT ST, BROOKLYN NY

Owner



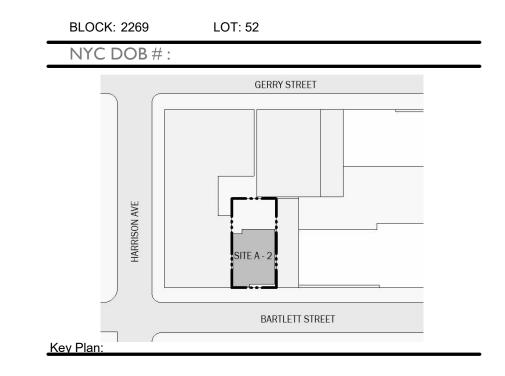

NUMBER DATE DESCRIPTION




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GROUND FLOOR RCP

SEAL & SIGNATURE:	PROJECT No: 19022
	DRAWING BY: Author
	CHK BY: Checker
	DWG No:
	A-122.00




2 LEVEL 4 1/4" = 1'-0"

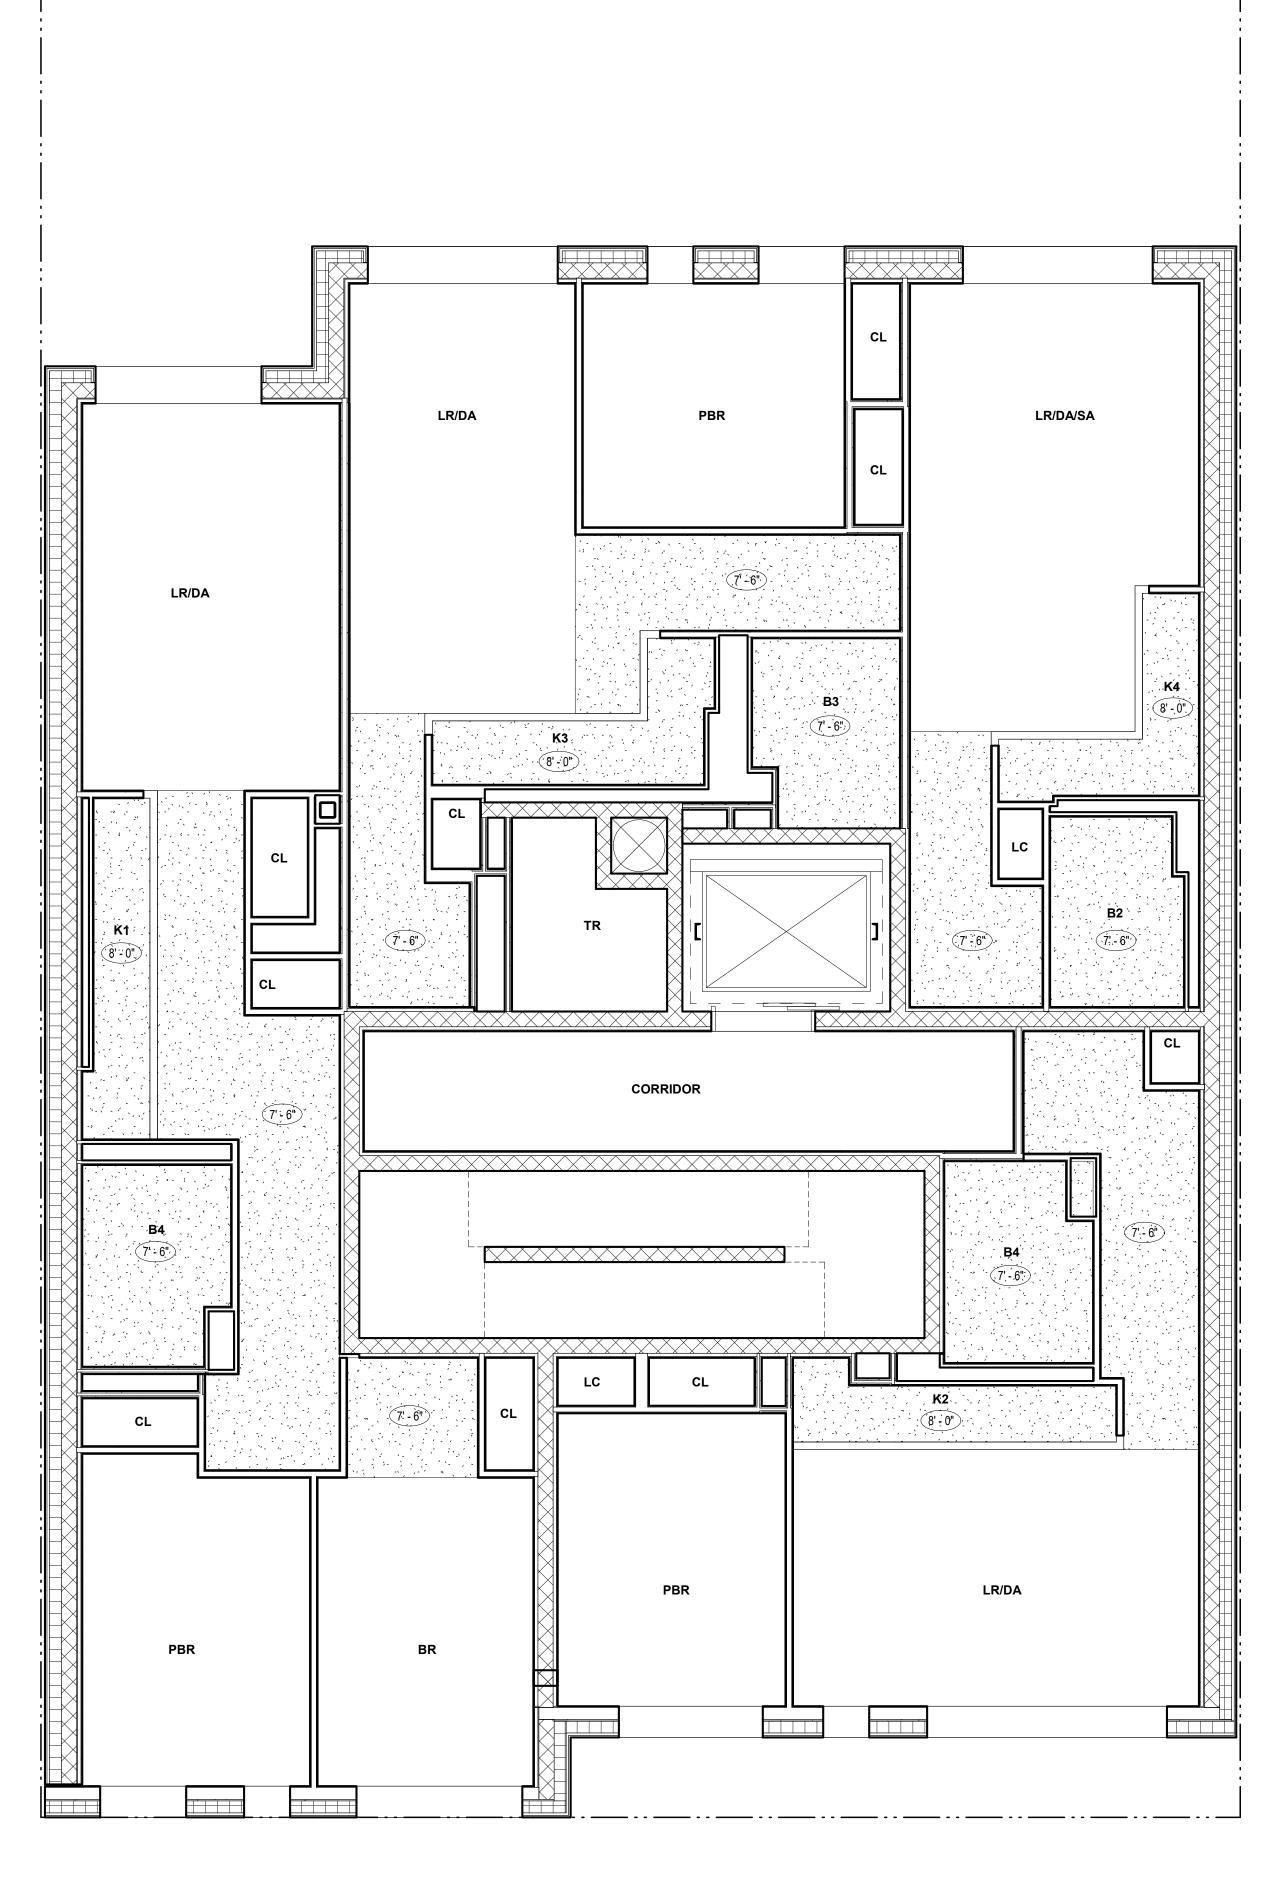BARTLETT CROSSING

SITE A-2 31 BARTLETT ST, BROOKLYN NY

Owner



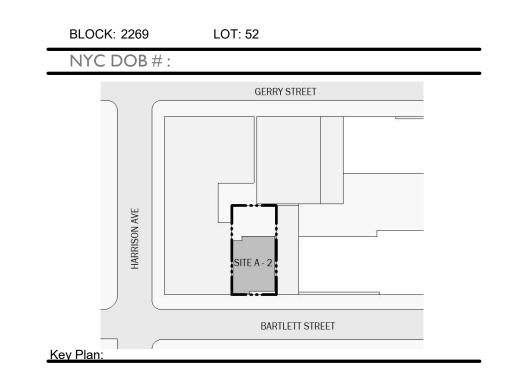

NUMBER DATE DESCRIPTION




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2ND TO 6TH FLOOR RCP

SEAL & SIGNATURE:	PROJECT No: 19022
	DRAWING BY: Author
	CHK BY: Checker
	DWG No:
	A-123.00
	SCALE: 1/4" = 1'-0"




1 LEVEL 7 1/4" = 1'-0"

BARTLETT CROSSING

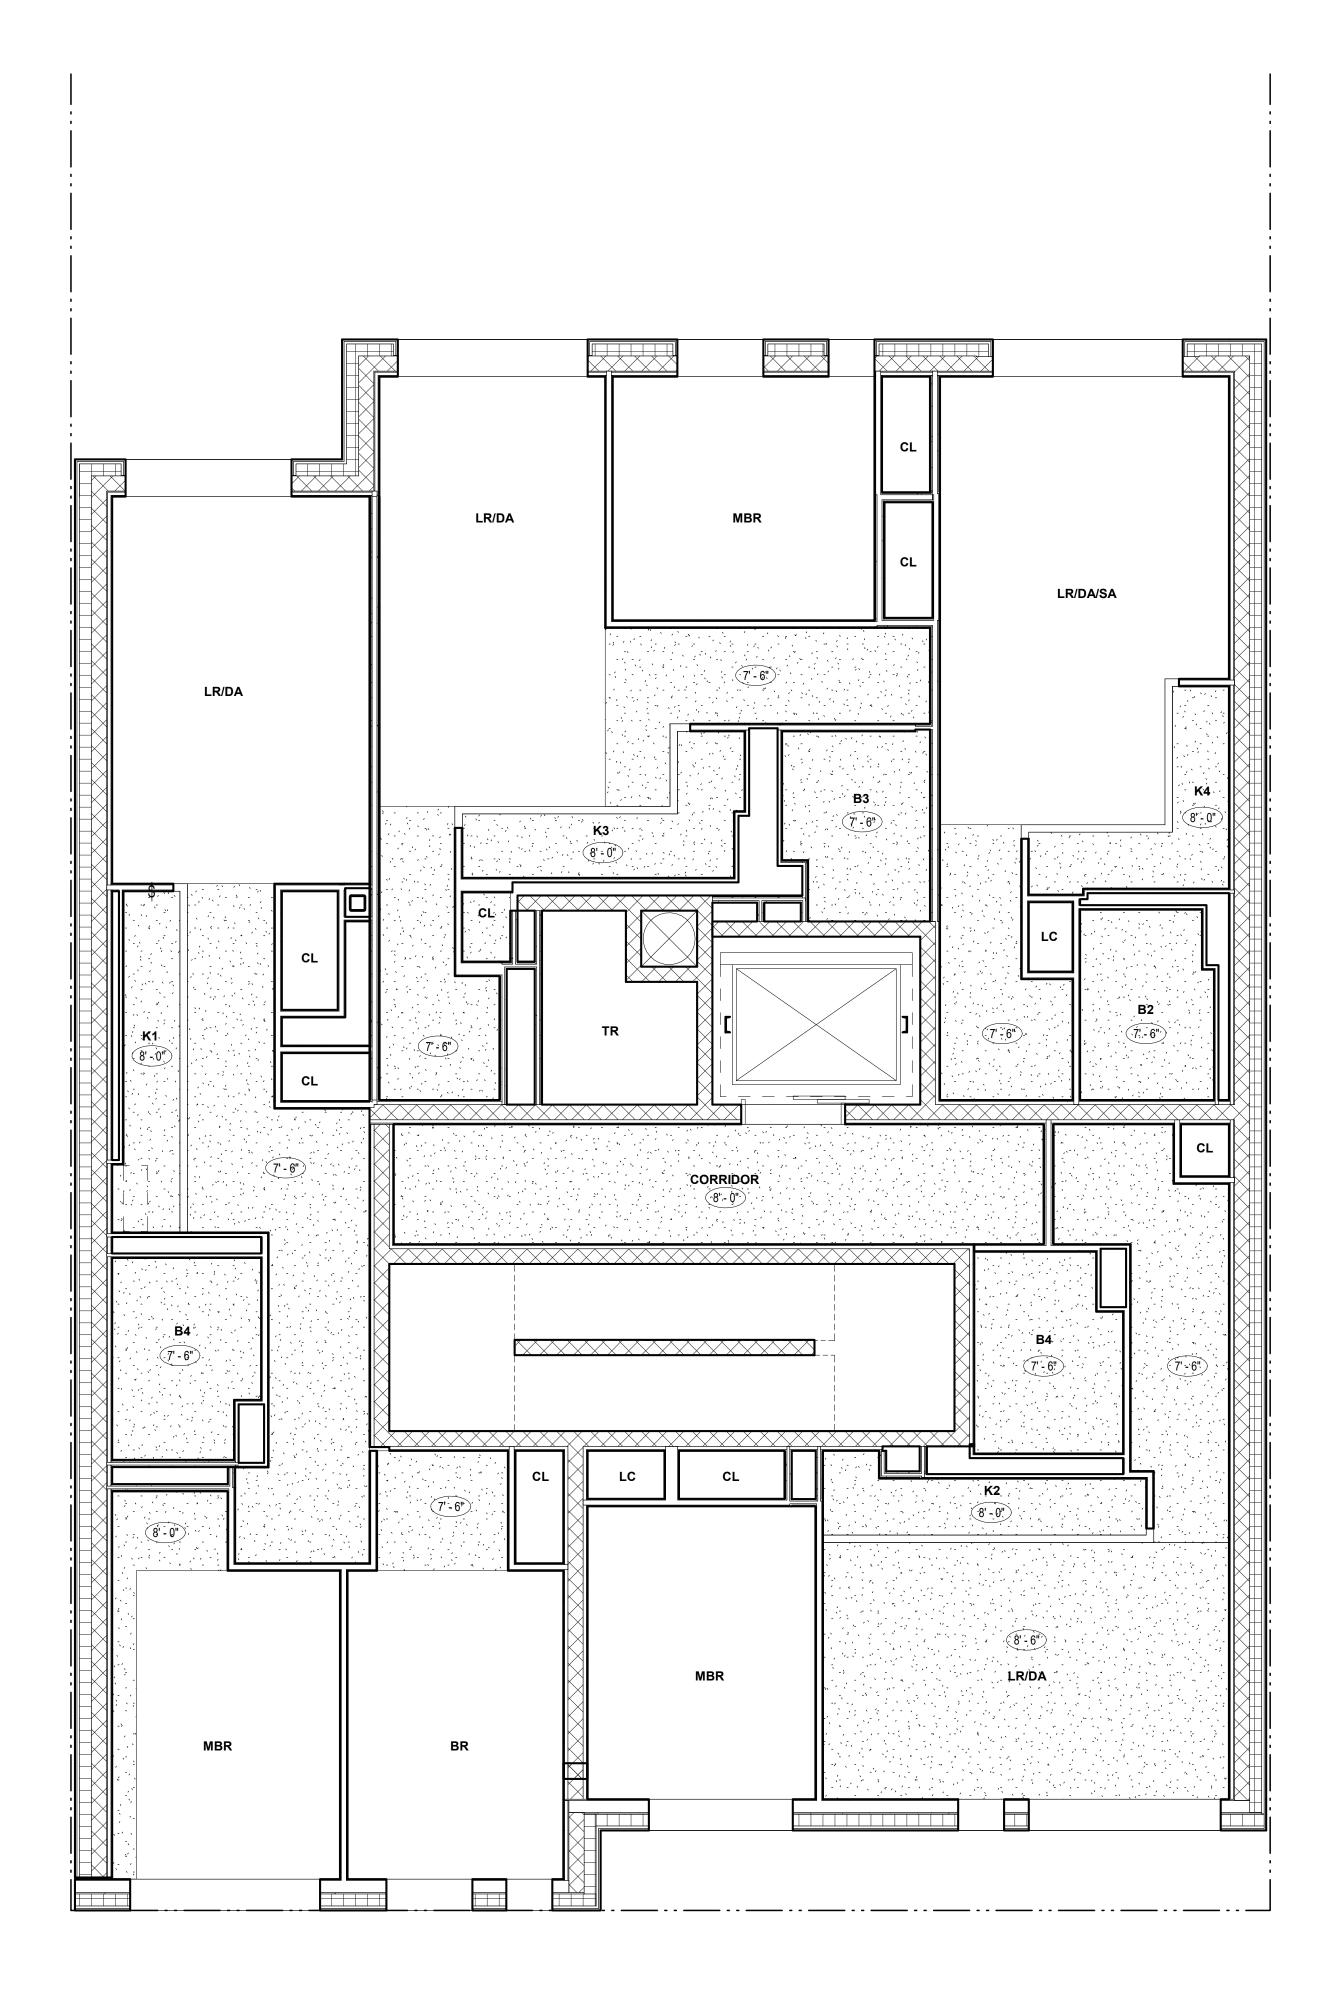SITE A-2 31 BARTLETT ST, BROOKLYN NY

Owner



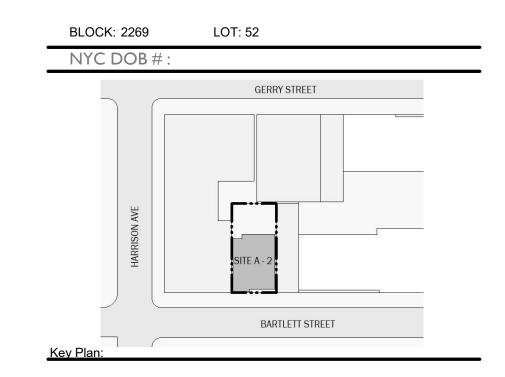

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Tel (212) 537-6080

Client Representative:


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7TH FLOOR RCP

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CH	IK BY:	Checker
DF	RAWING BY:	Author
EAL & SIGNATURE:	ROJECT No:	19022




1) 8TH FLOOR RCP 1/4" = 1'-0"

BARTLETT CROSSING

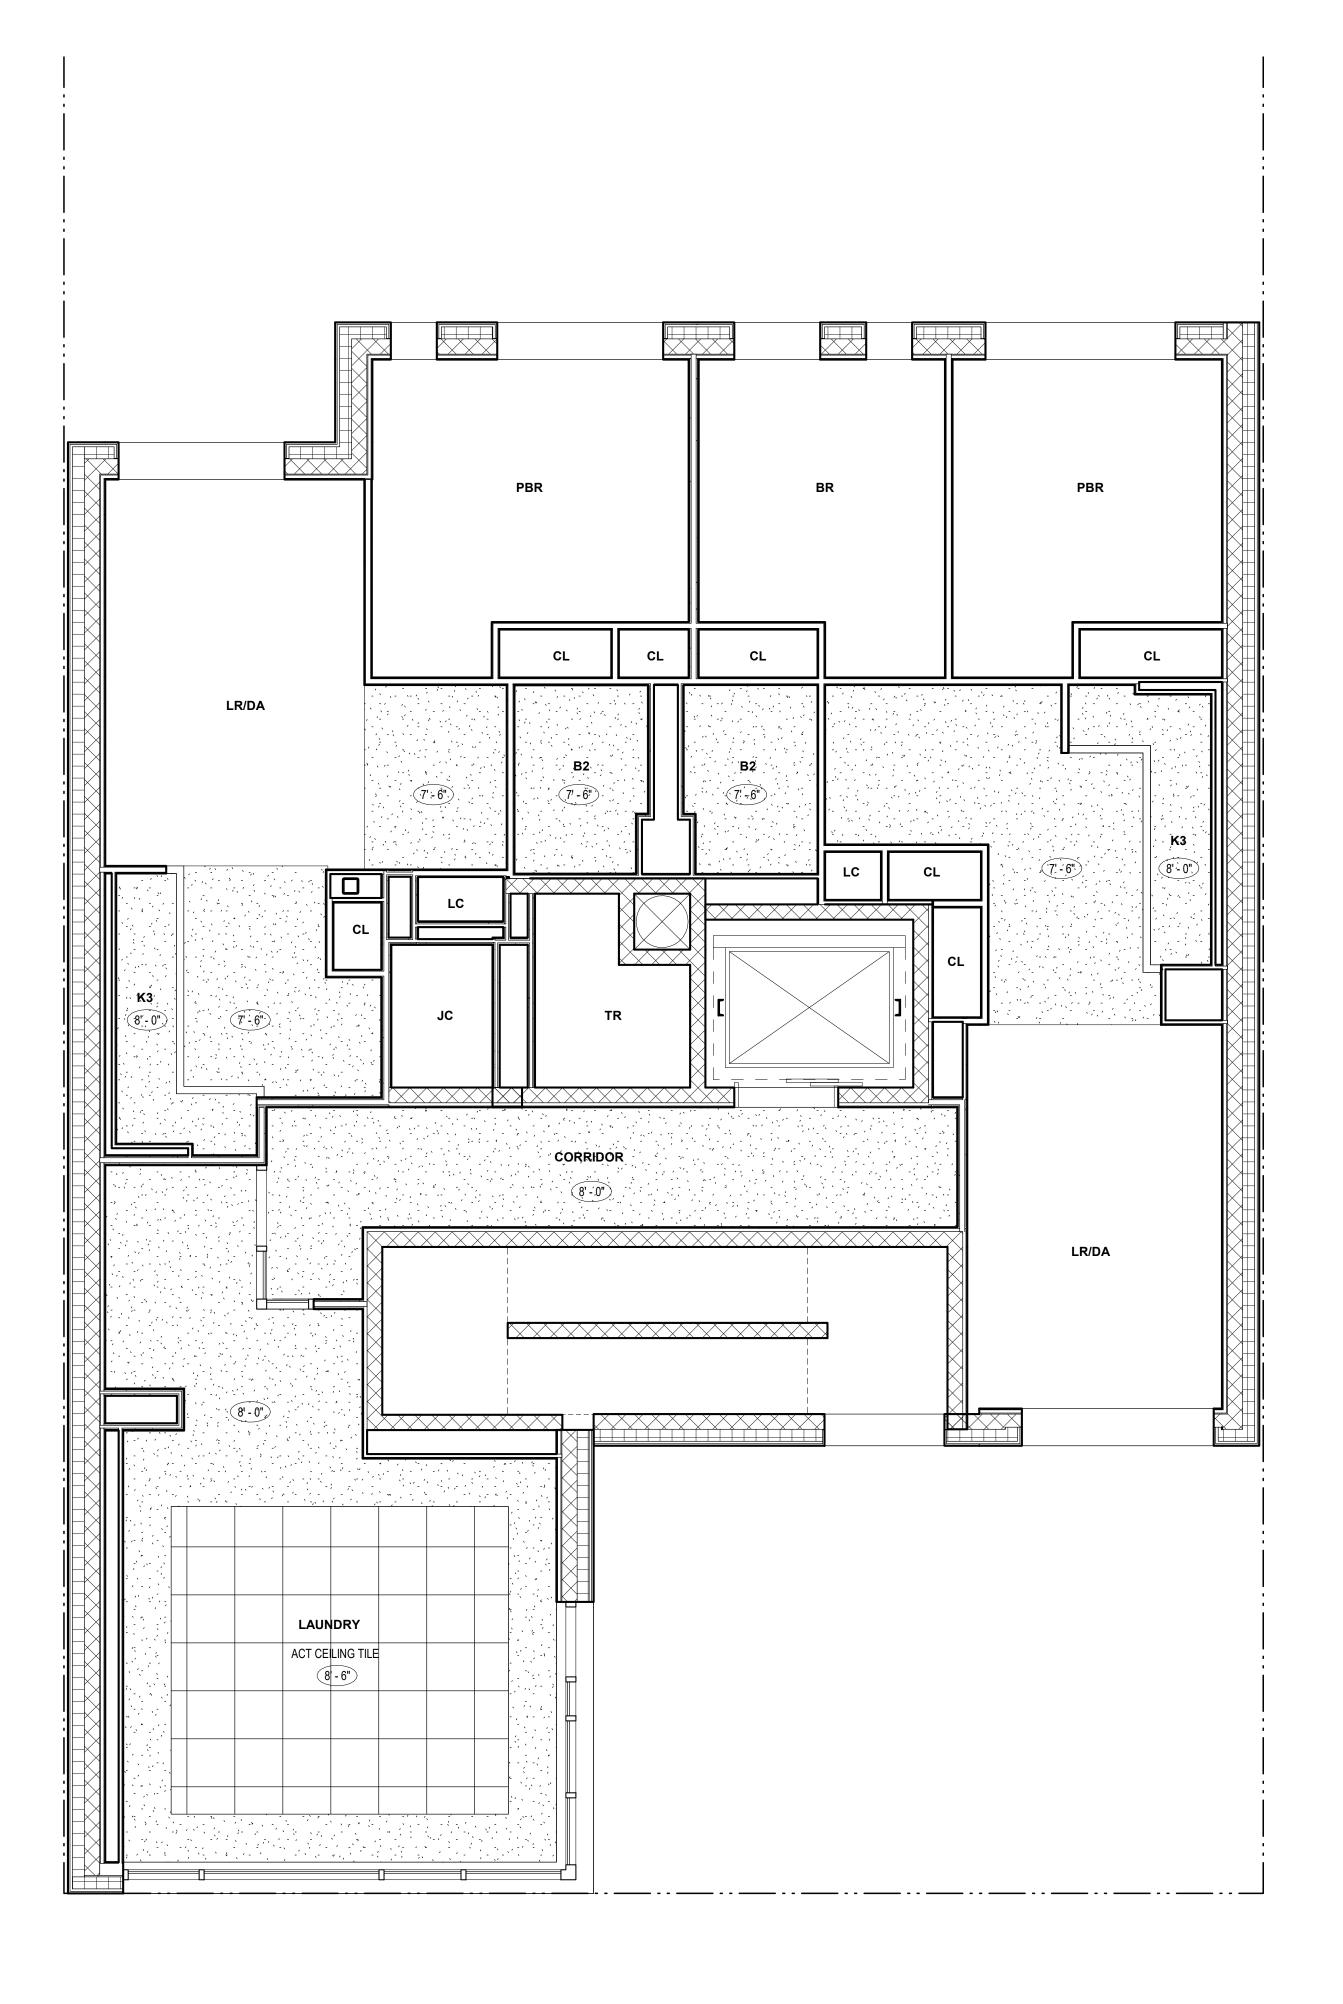SITE A-2 31 BARTLETT ST, BROOKLYN NY

Owner



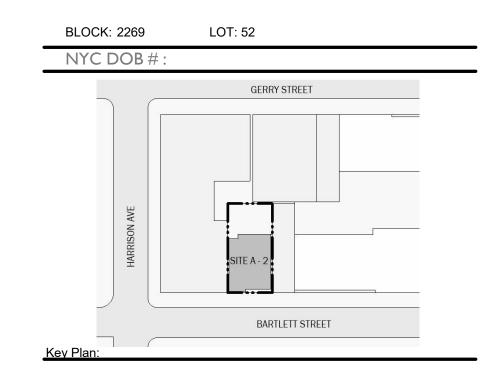

NUMBER DATE DESCRIPTION

Revis

Architect:

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Client Representative:


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8TH FLOOR RCP

	A-12	25.00
	DWG No:	
	CHK BY:	Checker
	DRAWING BY:	Author
EAL & SIGNATURE:	PROJECT No:	19022




1) 9TH FLOOR RCP 1/4" = 1'-0"

BARTLETT CROSSING

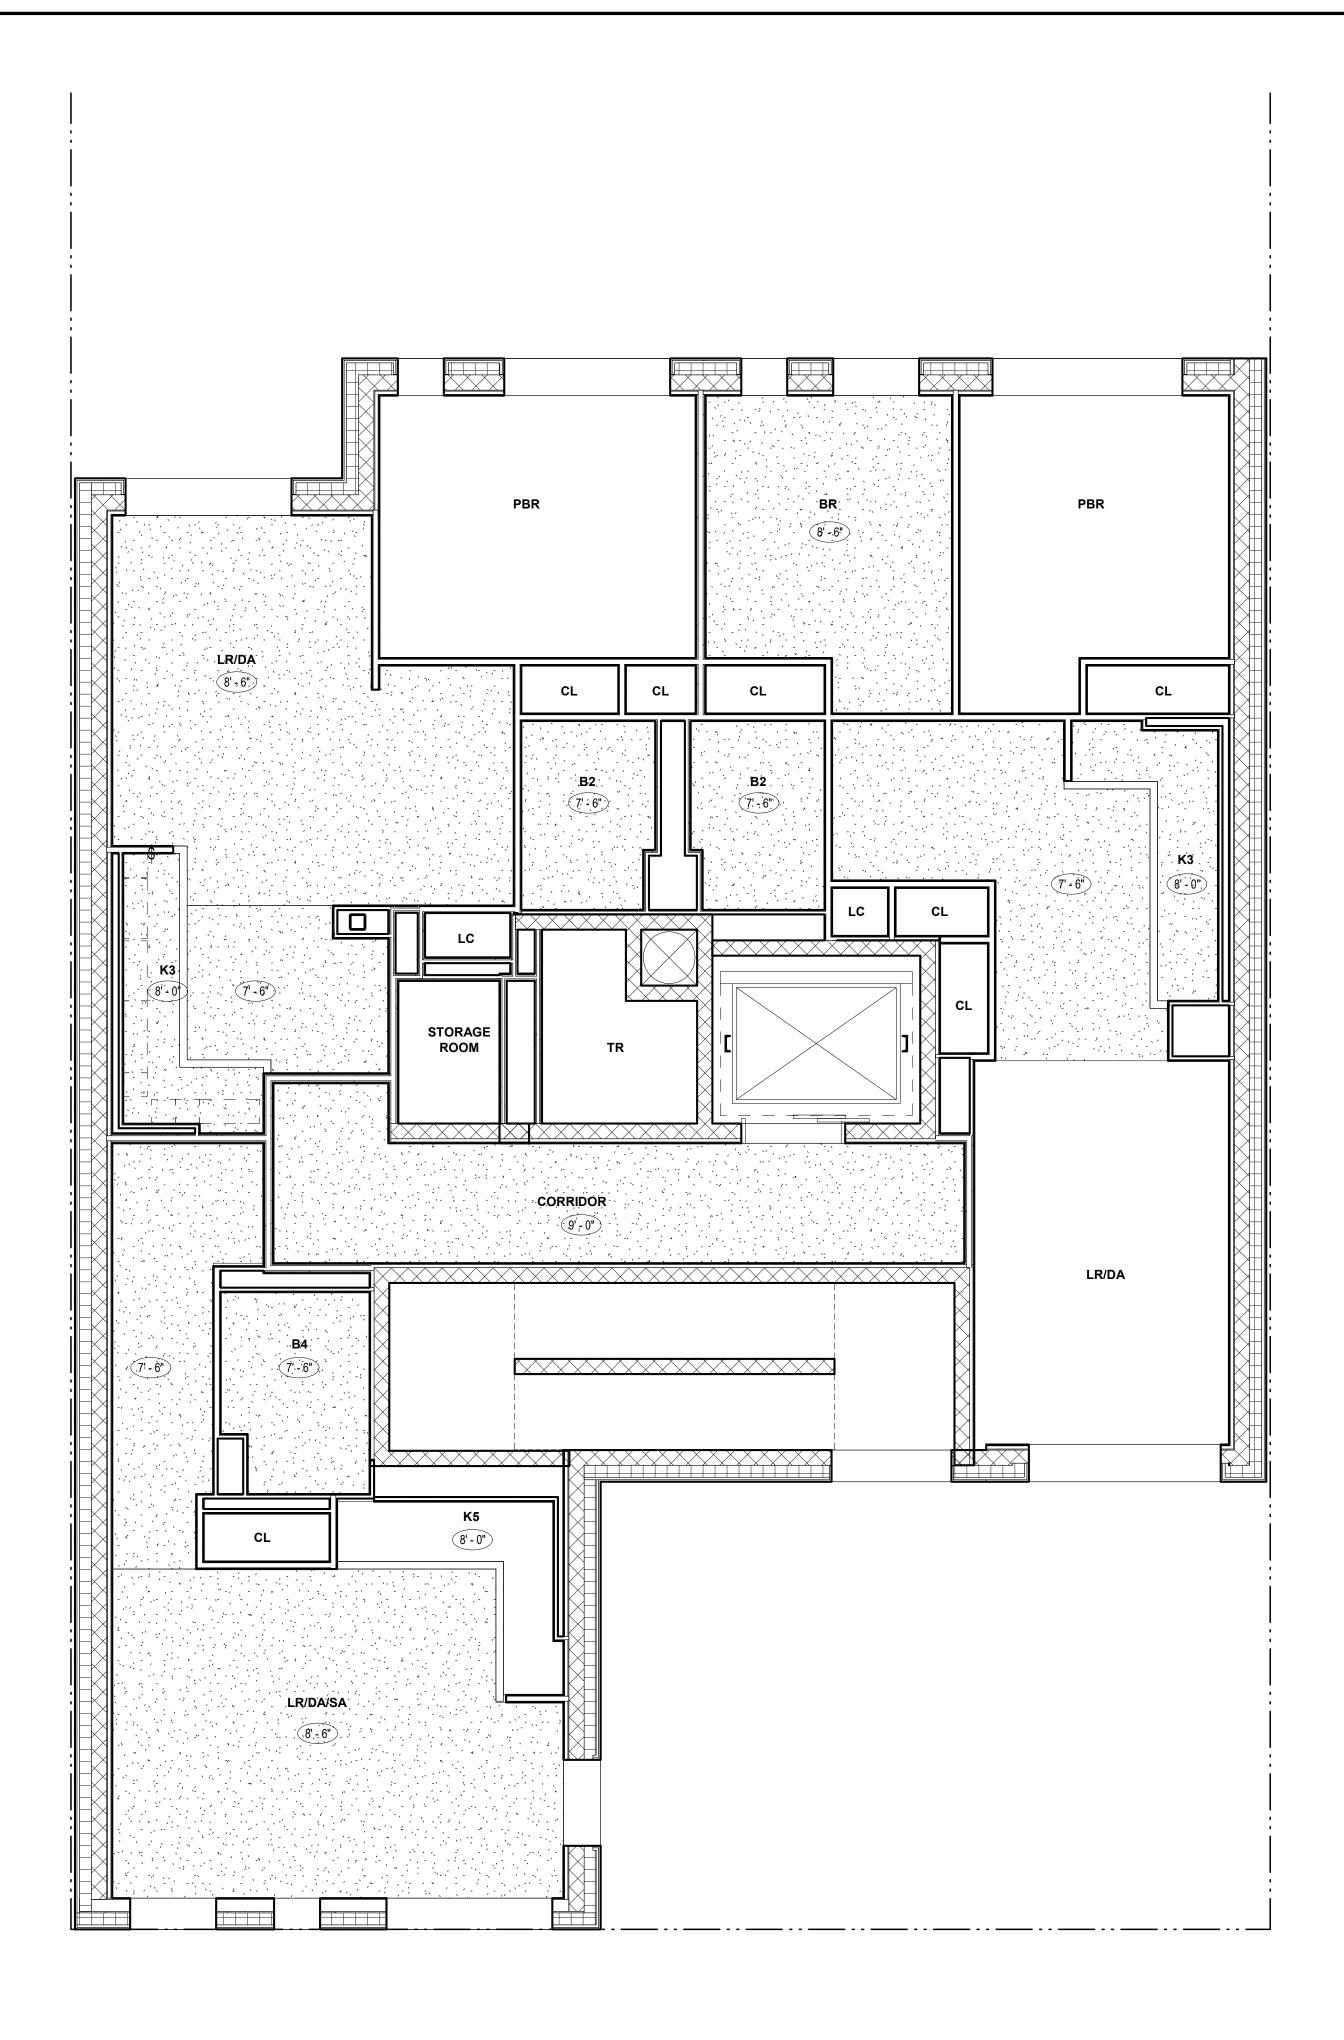SITE A-2 31 BARTLETT ST, BROOKLYN NY

Owner



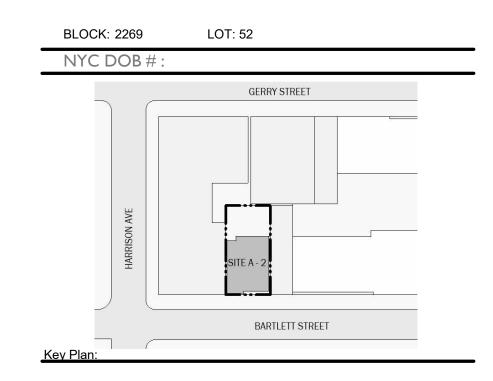

NUMBER DATE DESCRIPTION

Revis

Architect:

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Tel (212) 537-6080

Client Representative:


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9TH FLOOR RCP

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	DRAWING BY:	Author
	CHK BY:	Checker
	DWG No:	
	A-12	26.00




1 ROOF AND BULKHEAD RCP 1/4" = 1'-0"

BARTLETT CROSSING

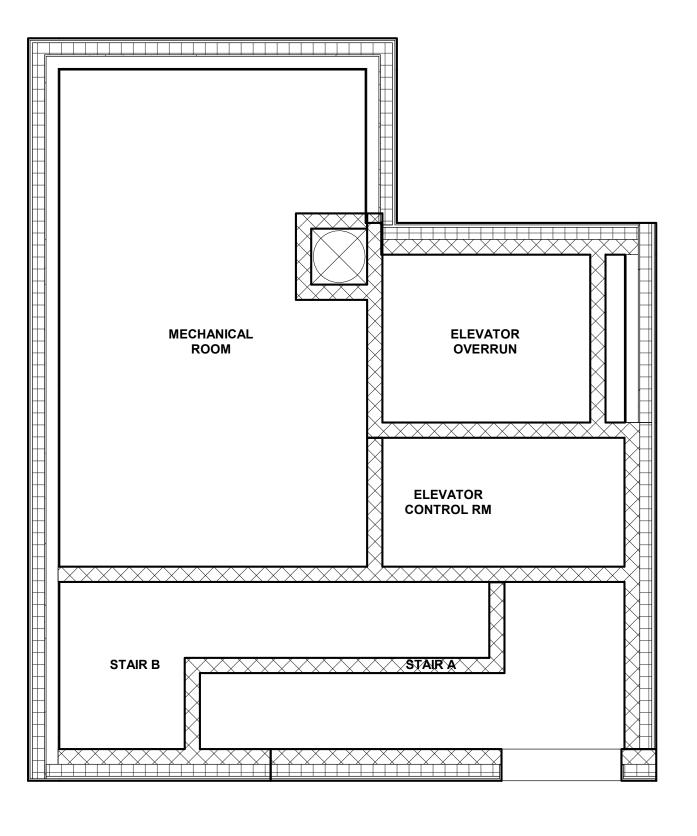SITE A-2 31 BARTLETT ST, BROOKLYN NY

Owner



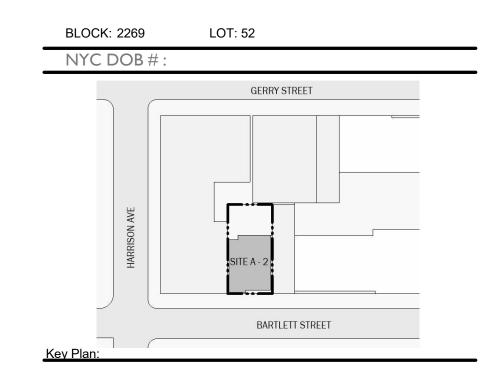

NUMBER DATE DESCRIPTION

Architect:

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Client Representative:

Filing Representative:

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ROOF AND BULKHEAD RCP

SEAL & SIGNATURE:

PROJECT No: 19022

DRAWING BY: Author

CHK BY: Checker

DWG No:


A-127.00



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Architect:

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SOUTH ELEVATION BARTLETT ST

SEAL & SIGNATURE:

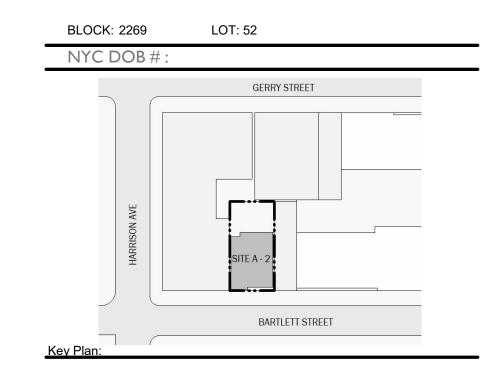PROJECT No: 19022

DRAWING BY: Author

CHK BY: Checker

DWG No:

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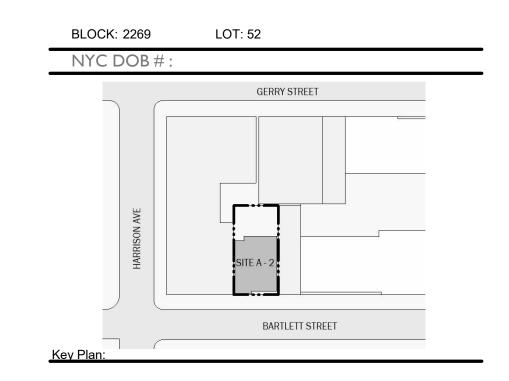
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SITE A-2 31 BARTLETT ST, BROOKLYN NY

Owner





NUMBER DATE DESCRIPTION

Architect:

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NORTH ELEVATION REAR YARD

SEAL & SIGNATURE:

PROJECT No: 19022


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CHK BY: Checker

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A-202.00


SCALE:
3/16" = 1'-0"



SITE A-2 31 BARTLETT ST, BROOKLYN NY

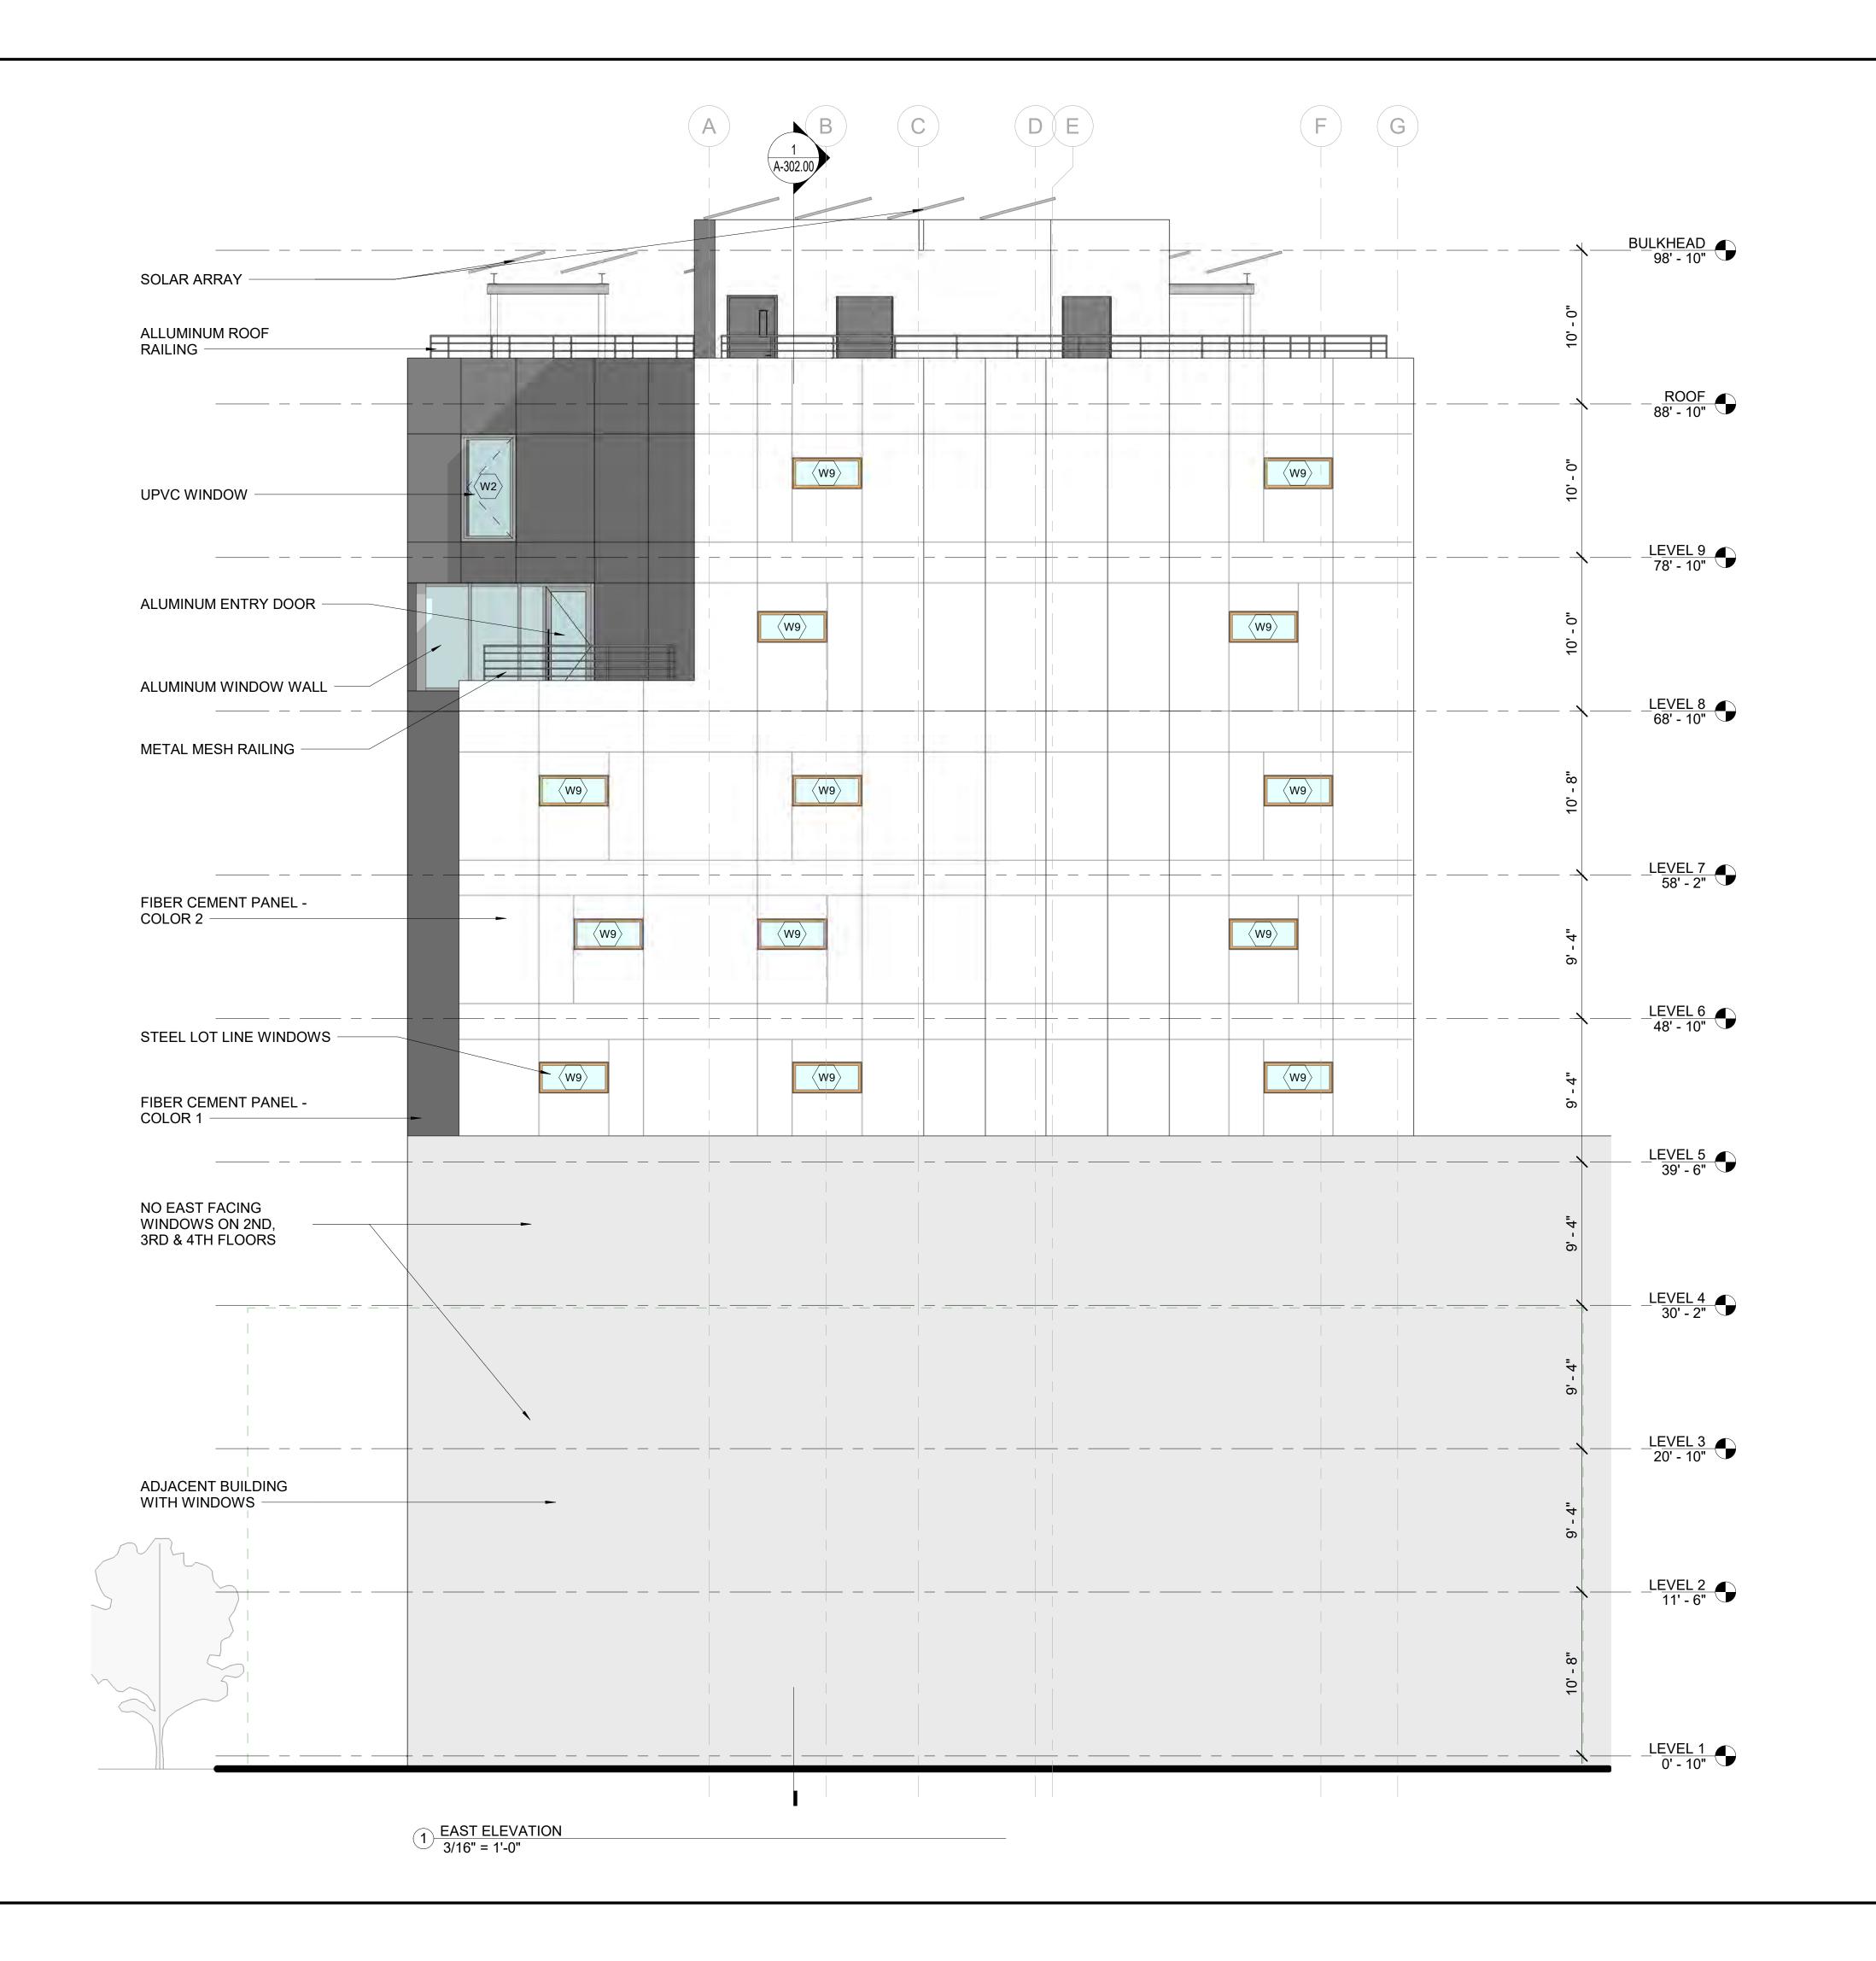Owner



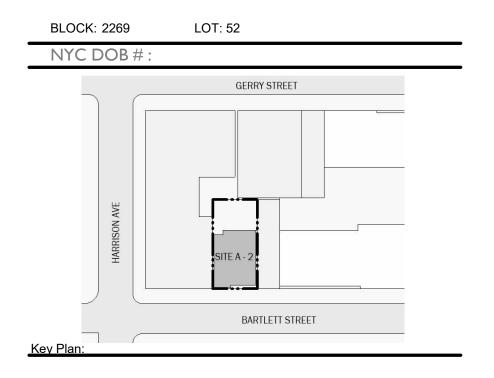

NUMBER DATE DESCRIPTIO

Revis

Architect:

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Landscape Architect: Terrain-NYC Landscape Architects 203 Lafayette Street, New York, NY 10012 Tel (212) 537-6080

Filing Representative:

Client Representative:


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EAST ELEVATION


	A-20	03.00
	DWG No:	
	CHK BY:	Checker
	DRAWING BY:	Author
L & SIGNATURE:	PROJECT No:	19022

SCALE: 3/16" = 1'-0"



SITE A-2 31 BARTLETT ST, BROOKLYN NY

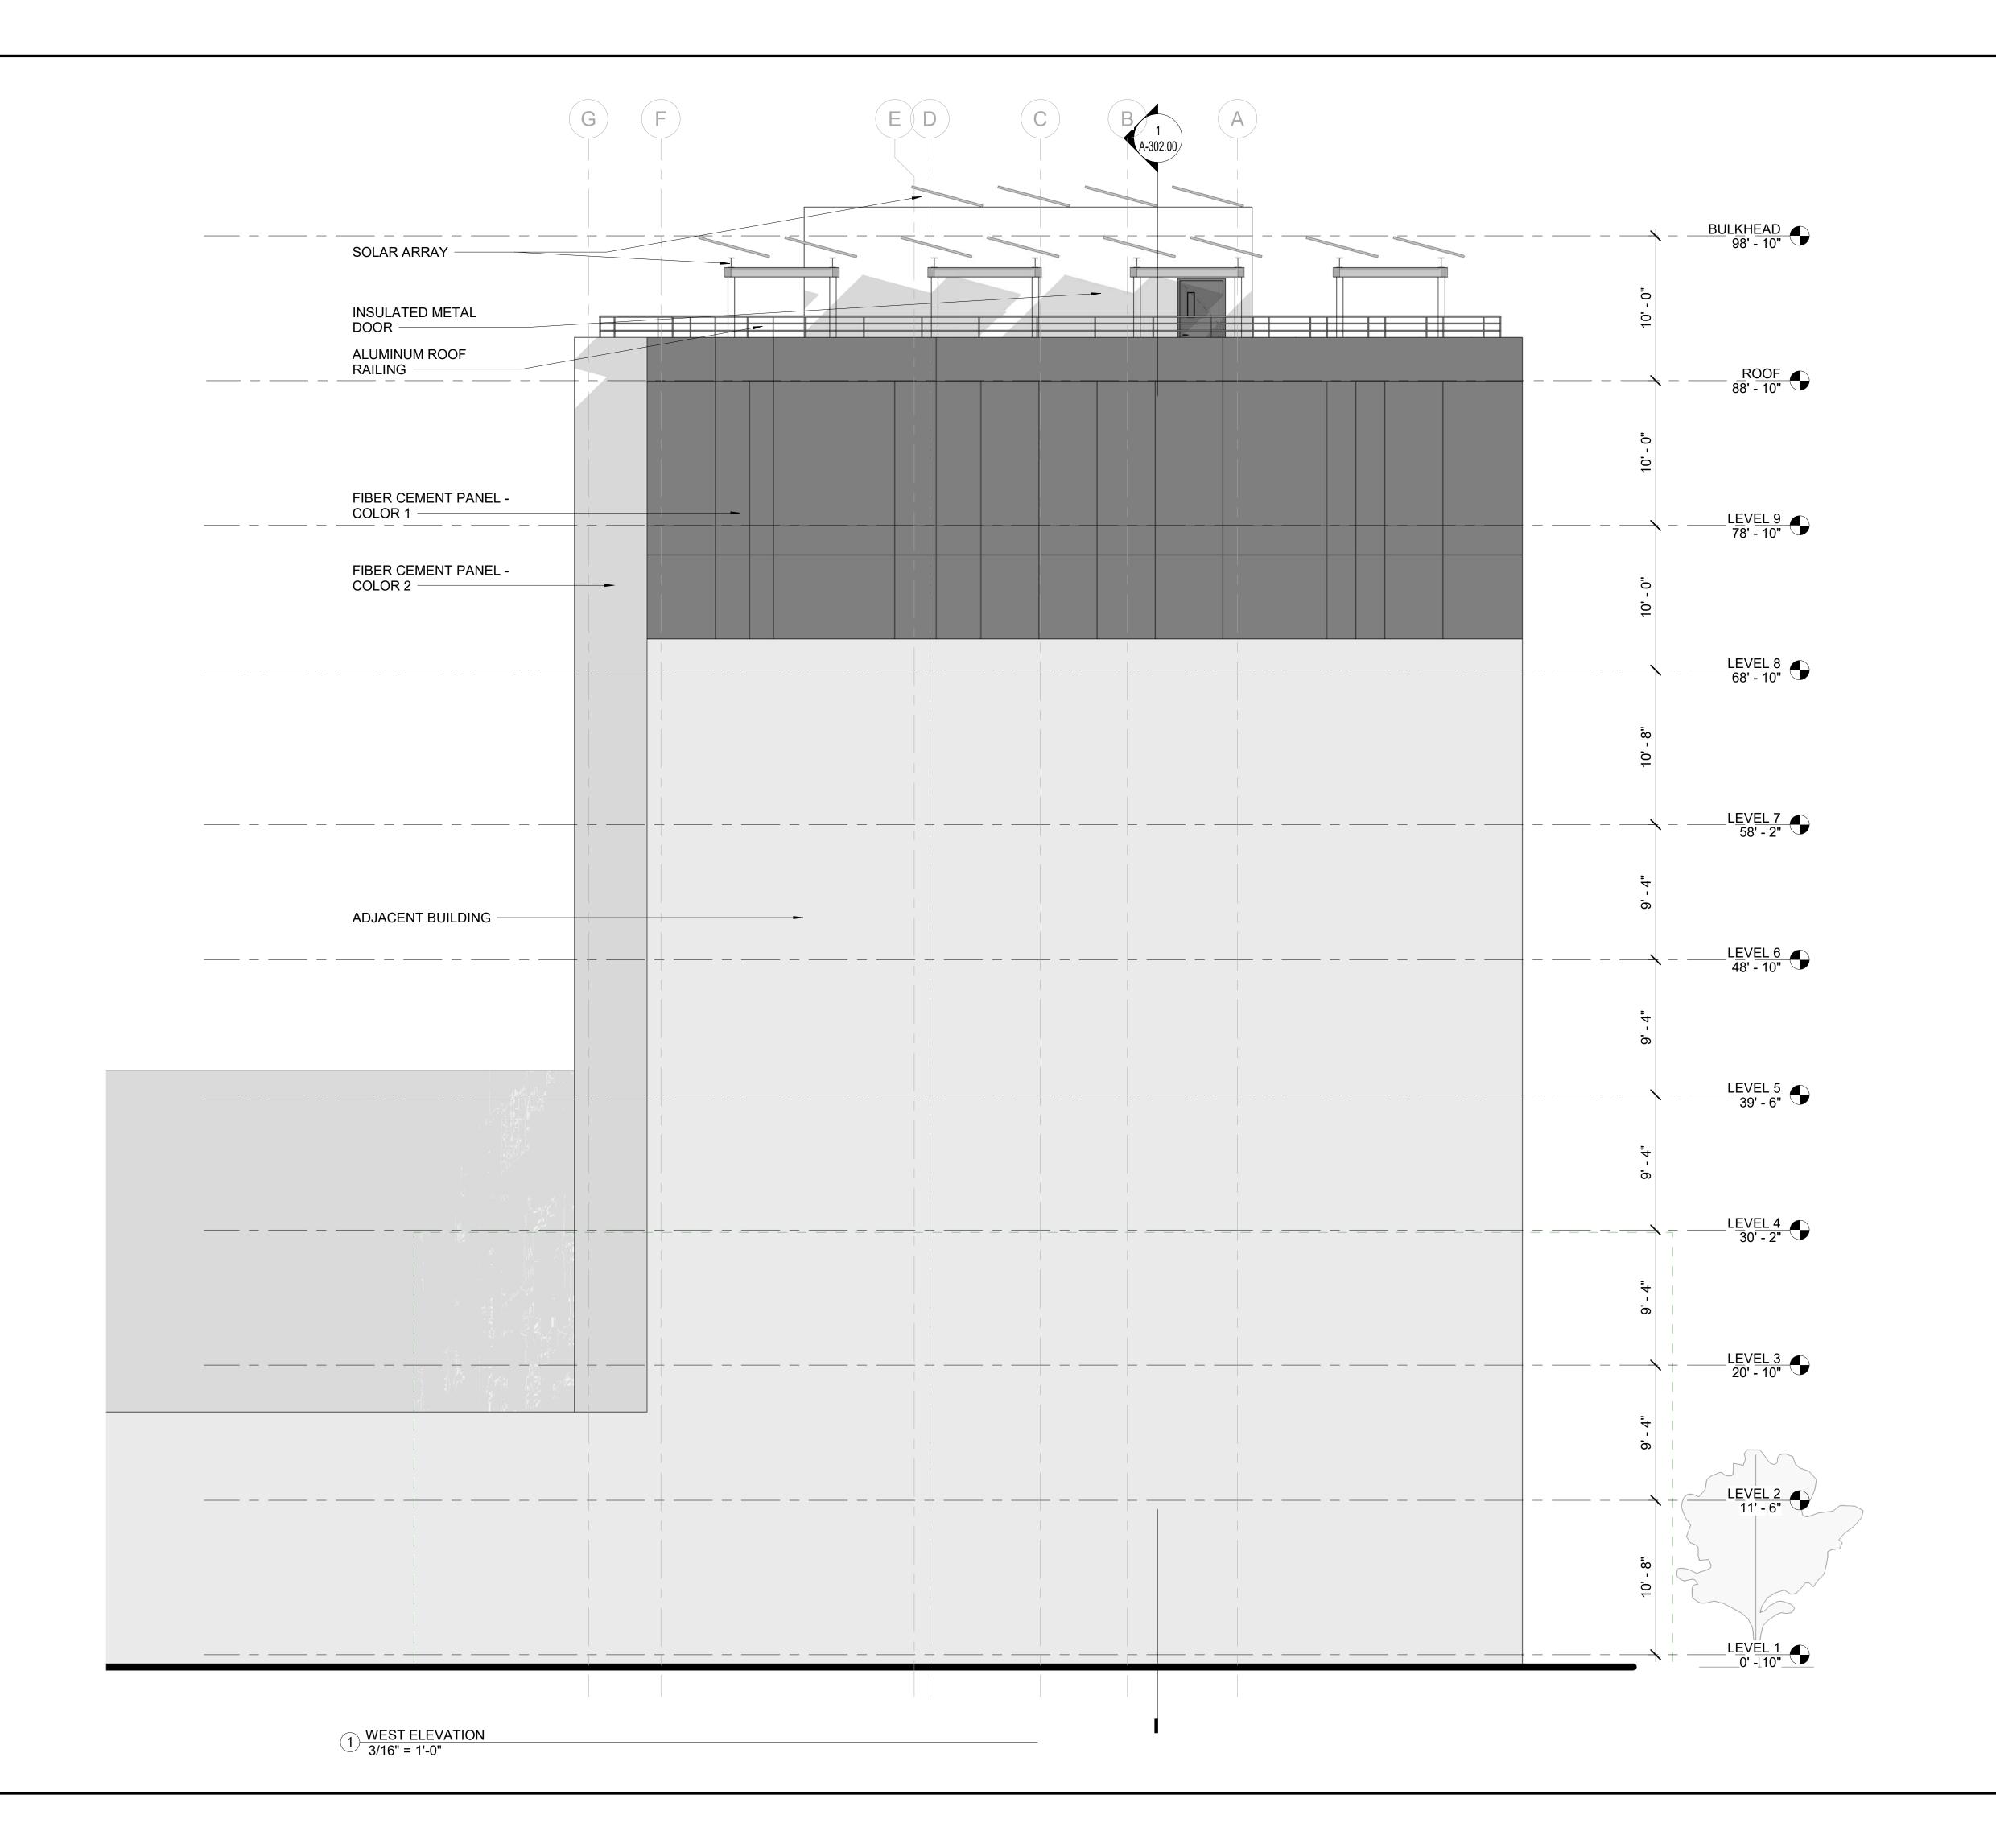

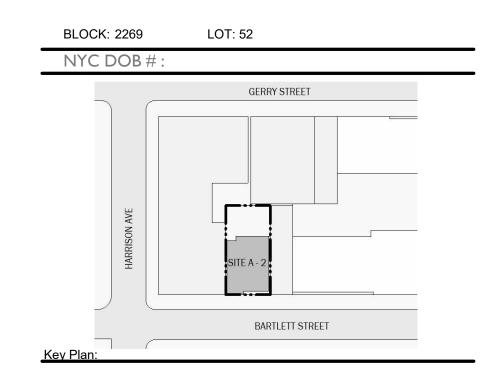

Architect:

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Landscape Architect: Terrain-NYC Landscape Architects 203 Lafayette Street, New York, NY 10012 Tel (212) 537-6080 Client Representative:

Filing Representative:


Do Not Scale Plans Contractor to promptly notify Architect of any material variations between field conditions and existing conditions as indicated in Contract documents

WEST ELEVATION

	A-20)4.00
	DWG No:	
	CHK BY:	Checker
	DRAWING BY:	Author
EAL & SIGNATURE:	PROJECT No:	19022

SCALE: 3/16" = 1'-0"



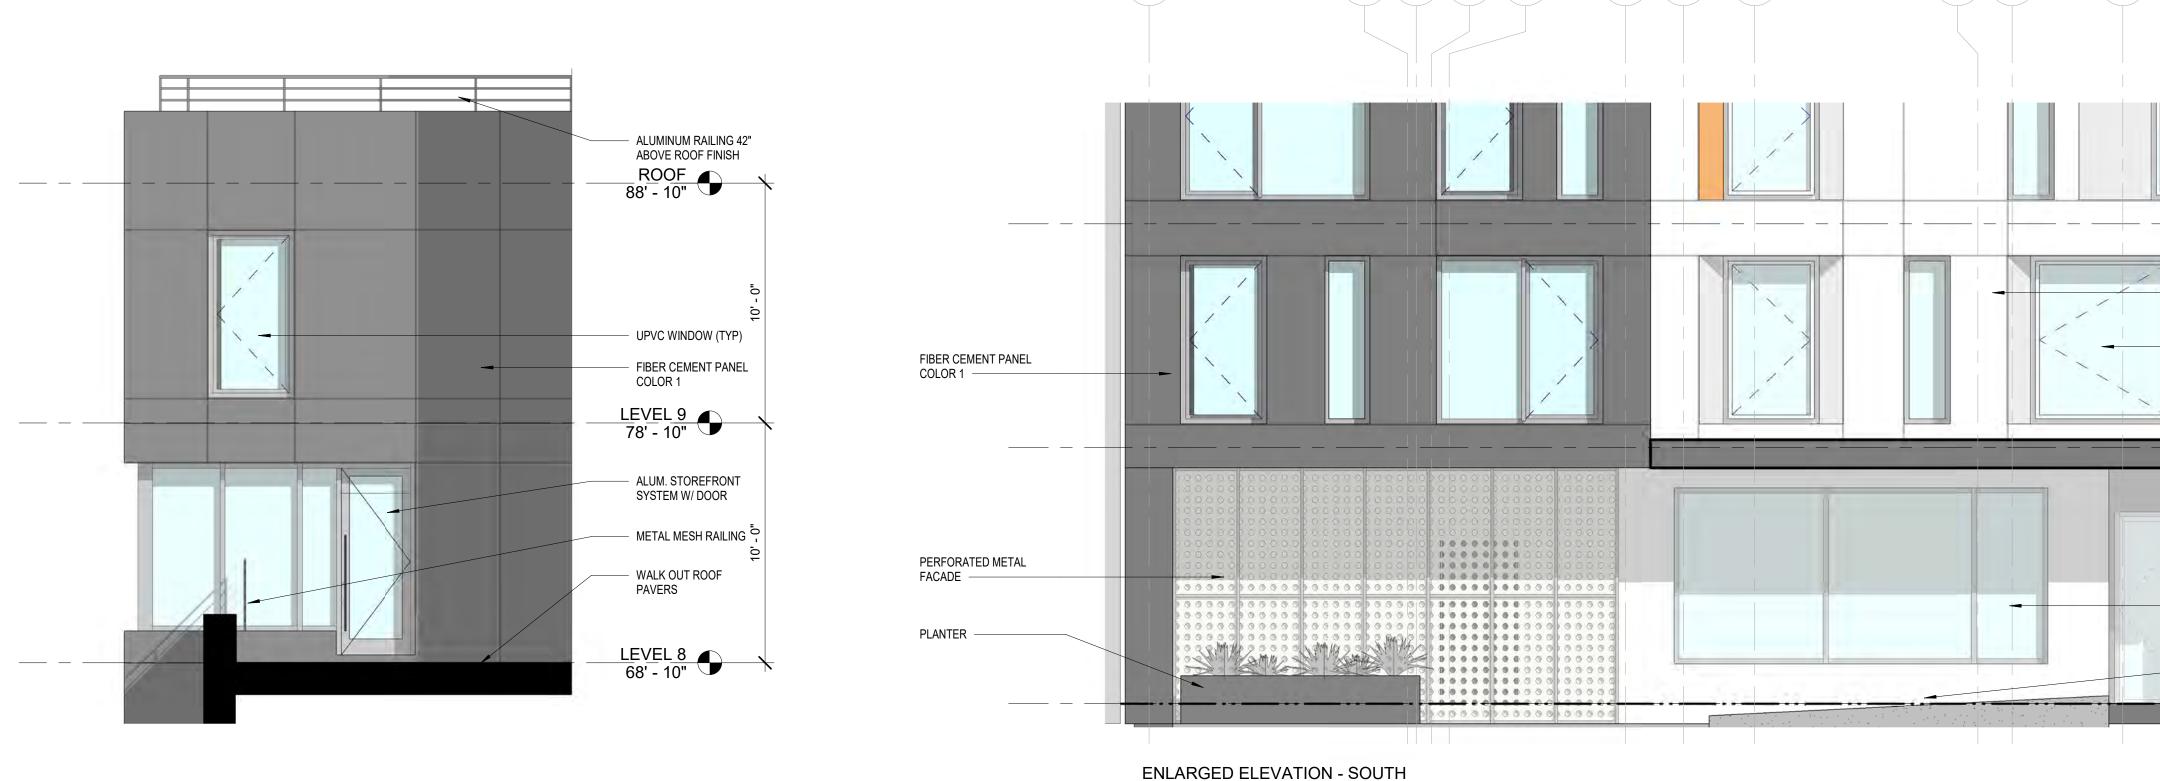

1 FACADE 1/4" = 1'-0"

3 ENLARGED ELEVATION - LAUNDRY 1/4" = 1'-0"

SEAL & SIGNATURE:

PROJECT No: 19022

DRAWING BY: Author

CHK BY: Checker

Contractor to promptly notify Architect of any material variations between field conditions and existing conditions as indicated in Contract documents

ENLARGED ELEVATIONS

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MEP Engineer: Loring Consulting Engineers 360 West 31st Street, New York, NY 10001

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Terrain-NYC Landscape Architects

New York NY 10018

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Tel (646) 674-6100

Landscape Architect:

Client Representative:

Filing Representative:

Do Not Scale Plans

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LEVEL 3 20' - 10"

FIBER CEMENT PANEL

UPVC WINDOW (TYP)

FIBER CEMENT PANEL (ACCENT COLOR 2)

METAL CLAD CANOPY

ALUM. STOREFRONT

INSULATED HOLLOW

METAL EGRESS DOOR

LEVEL 1 0' - 10"

DOOR AND FRAME


WITH LITES

ENTRY RAMP

LEVEL 2 11' - 6"


COLOR 2

DWG No:
A-210.00

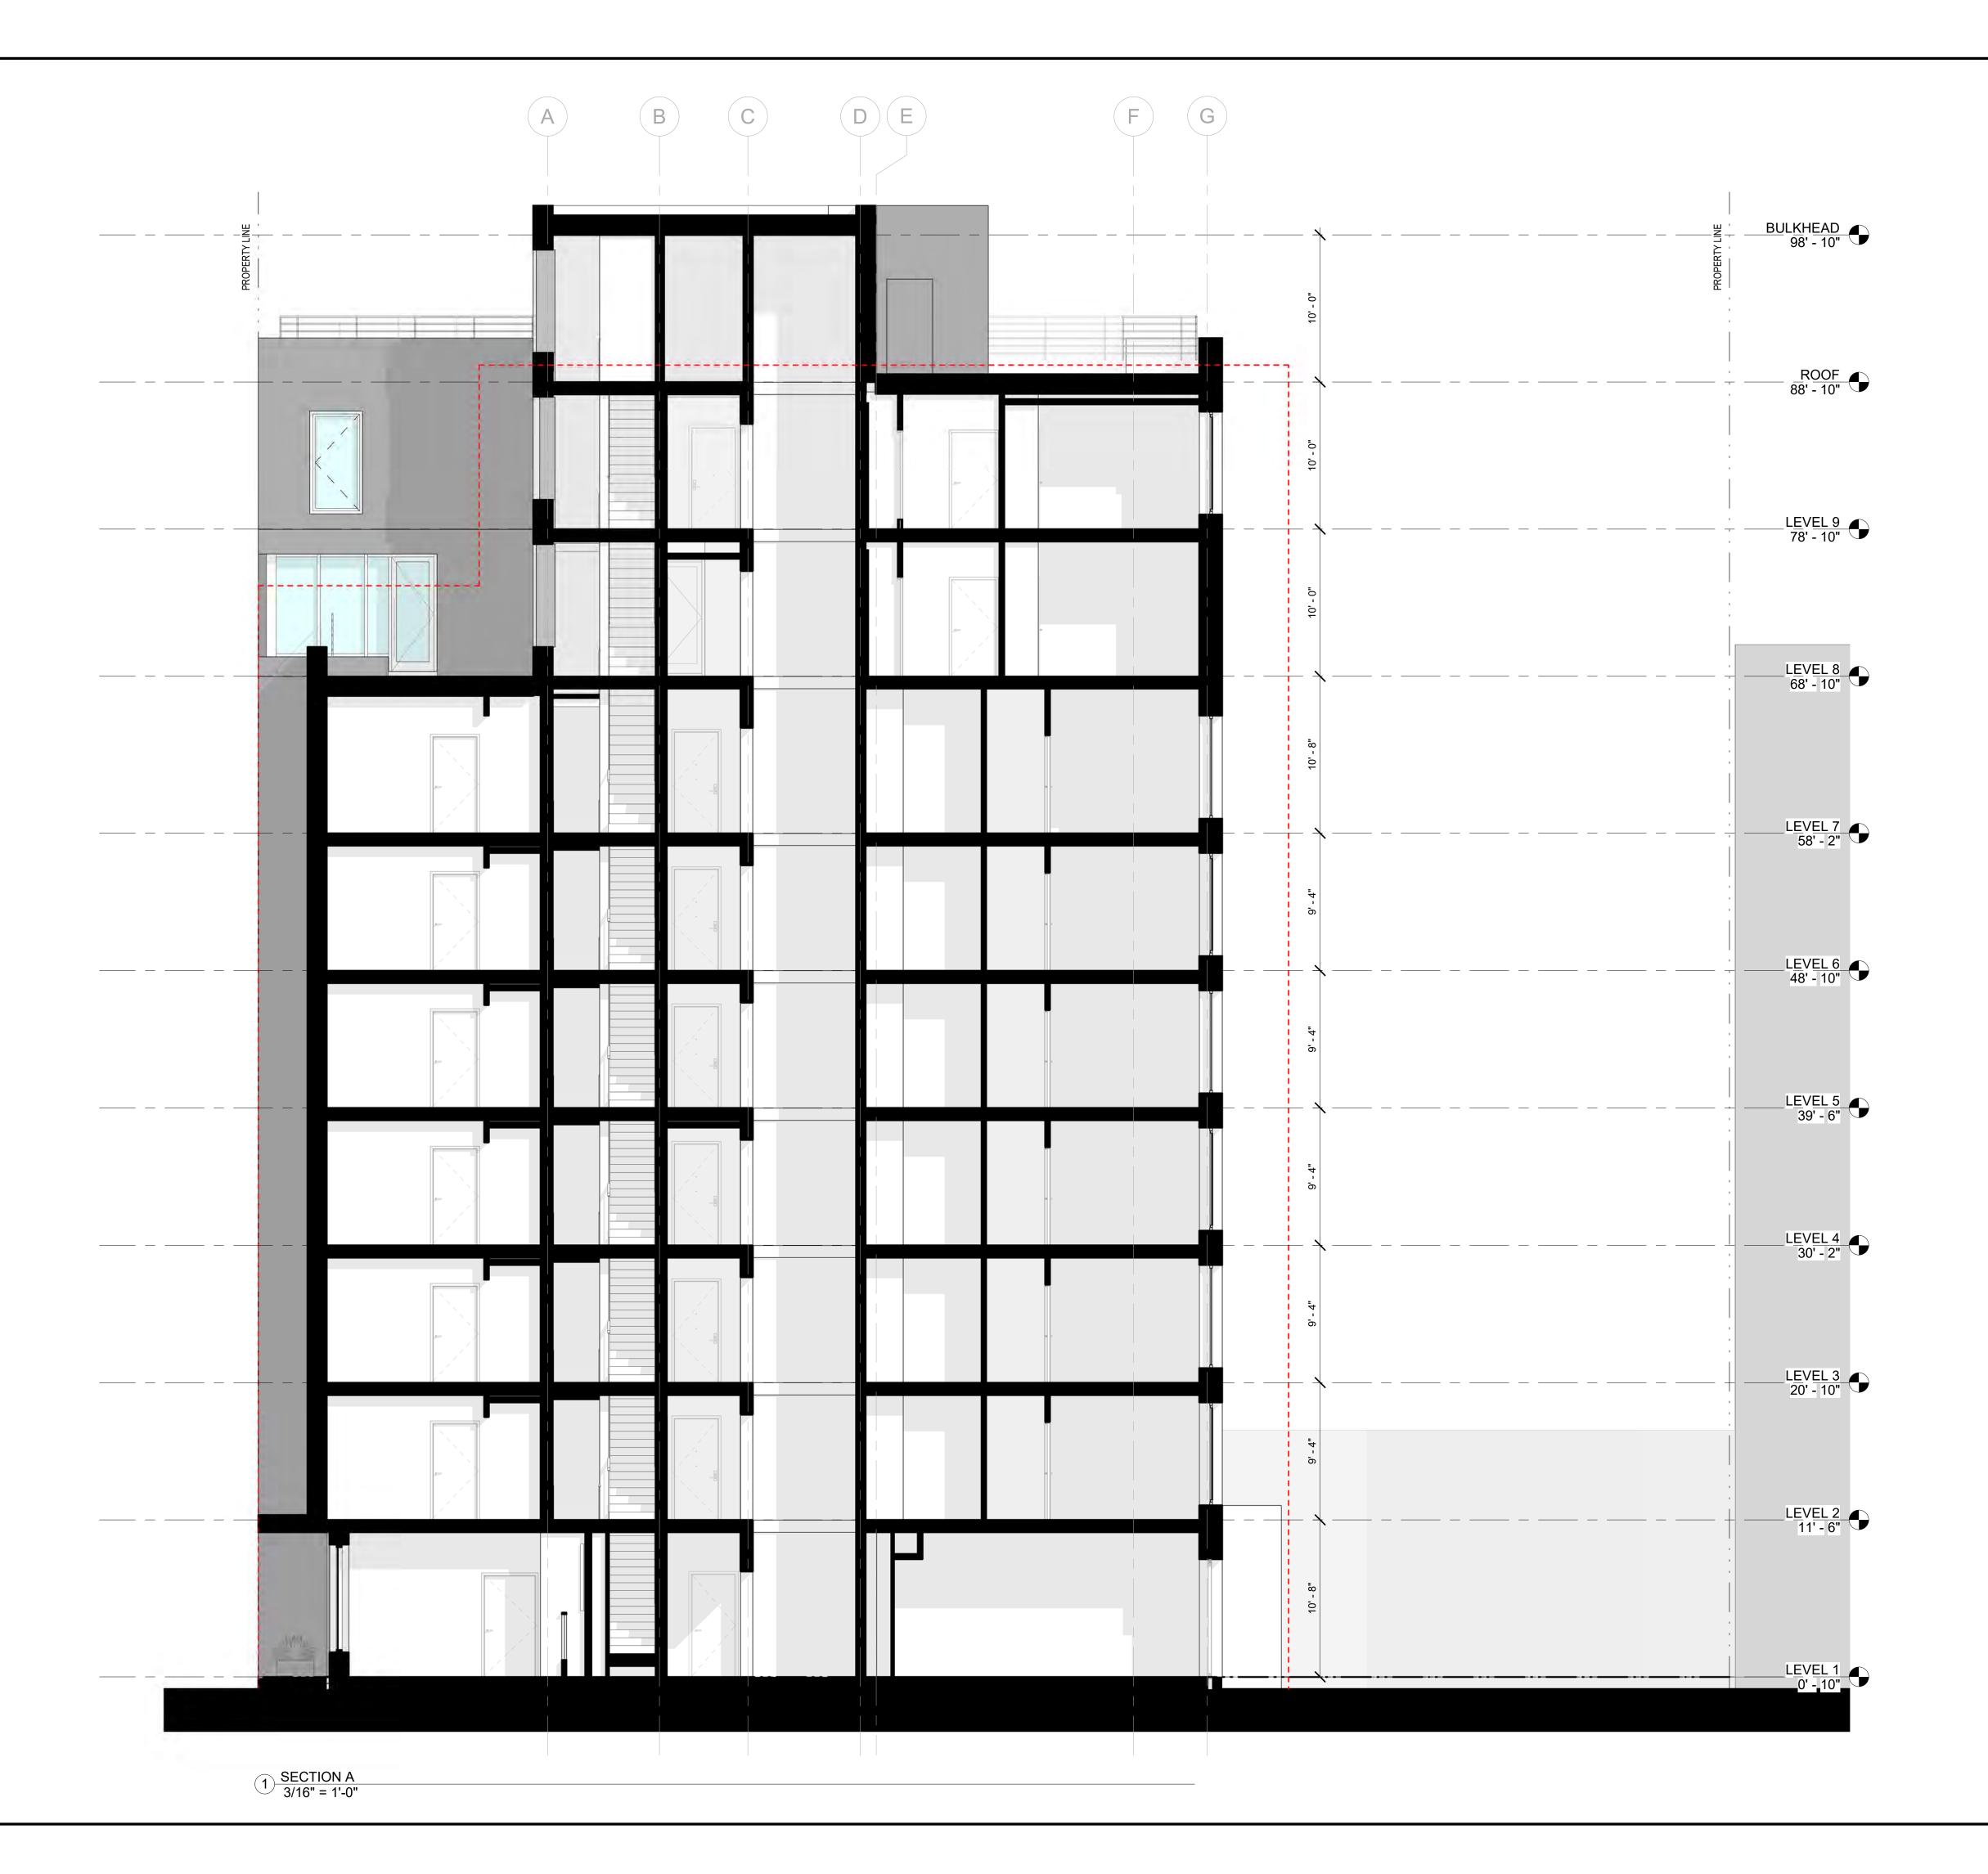

SITE A-2 31 BARTLETT ST, BROOKLYN NY



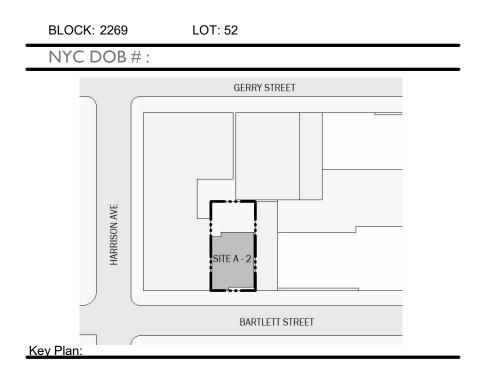

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New York NY 10018 Tel (212) 253 7820 Fax (212) 253 1276

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Landscape Architect: Terrain-NYC Landscape Architects 203 Lafayette Street, New York, NY 10012 Tel (212) 537-6080

Client Representative:


Filing Representative:

Do Not Scale Plans Contractor to promptly notify Architect of any material variations between field conditions and existing conditions as indicated in Contract documents

BUILDING SECTION

cker
or cke


SCALE: 3/16" = 1'-0"

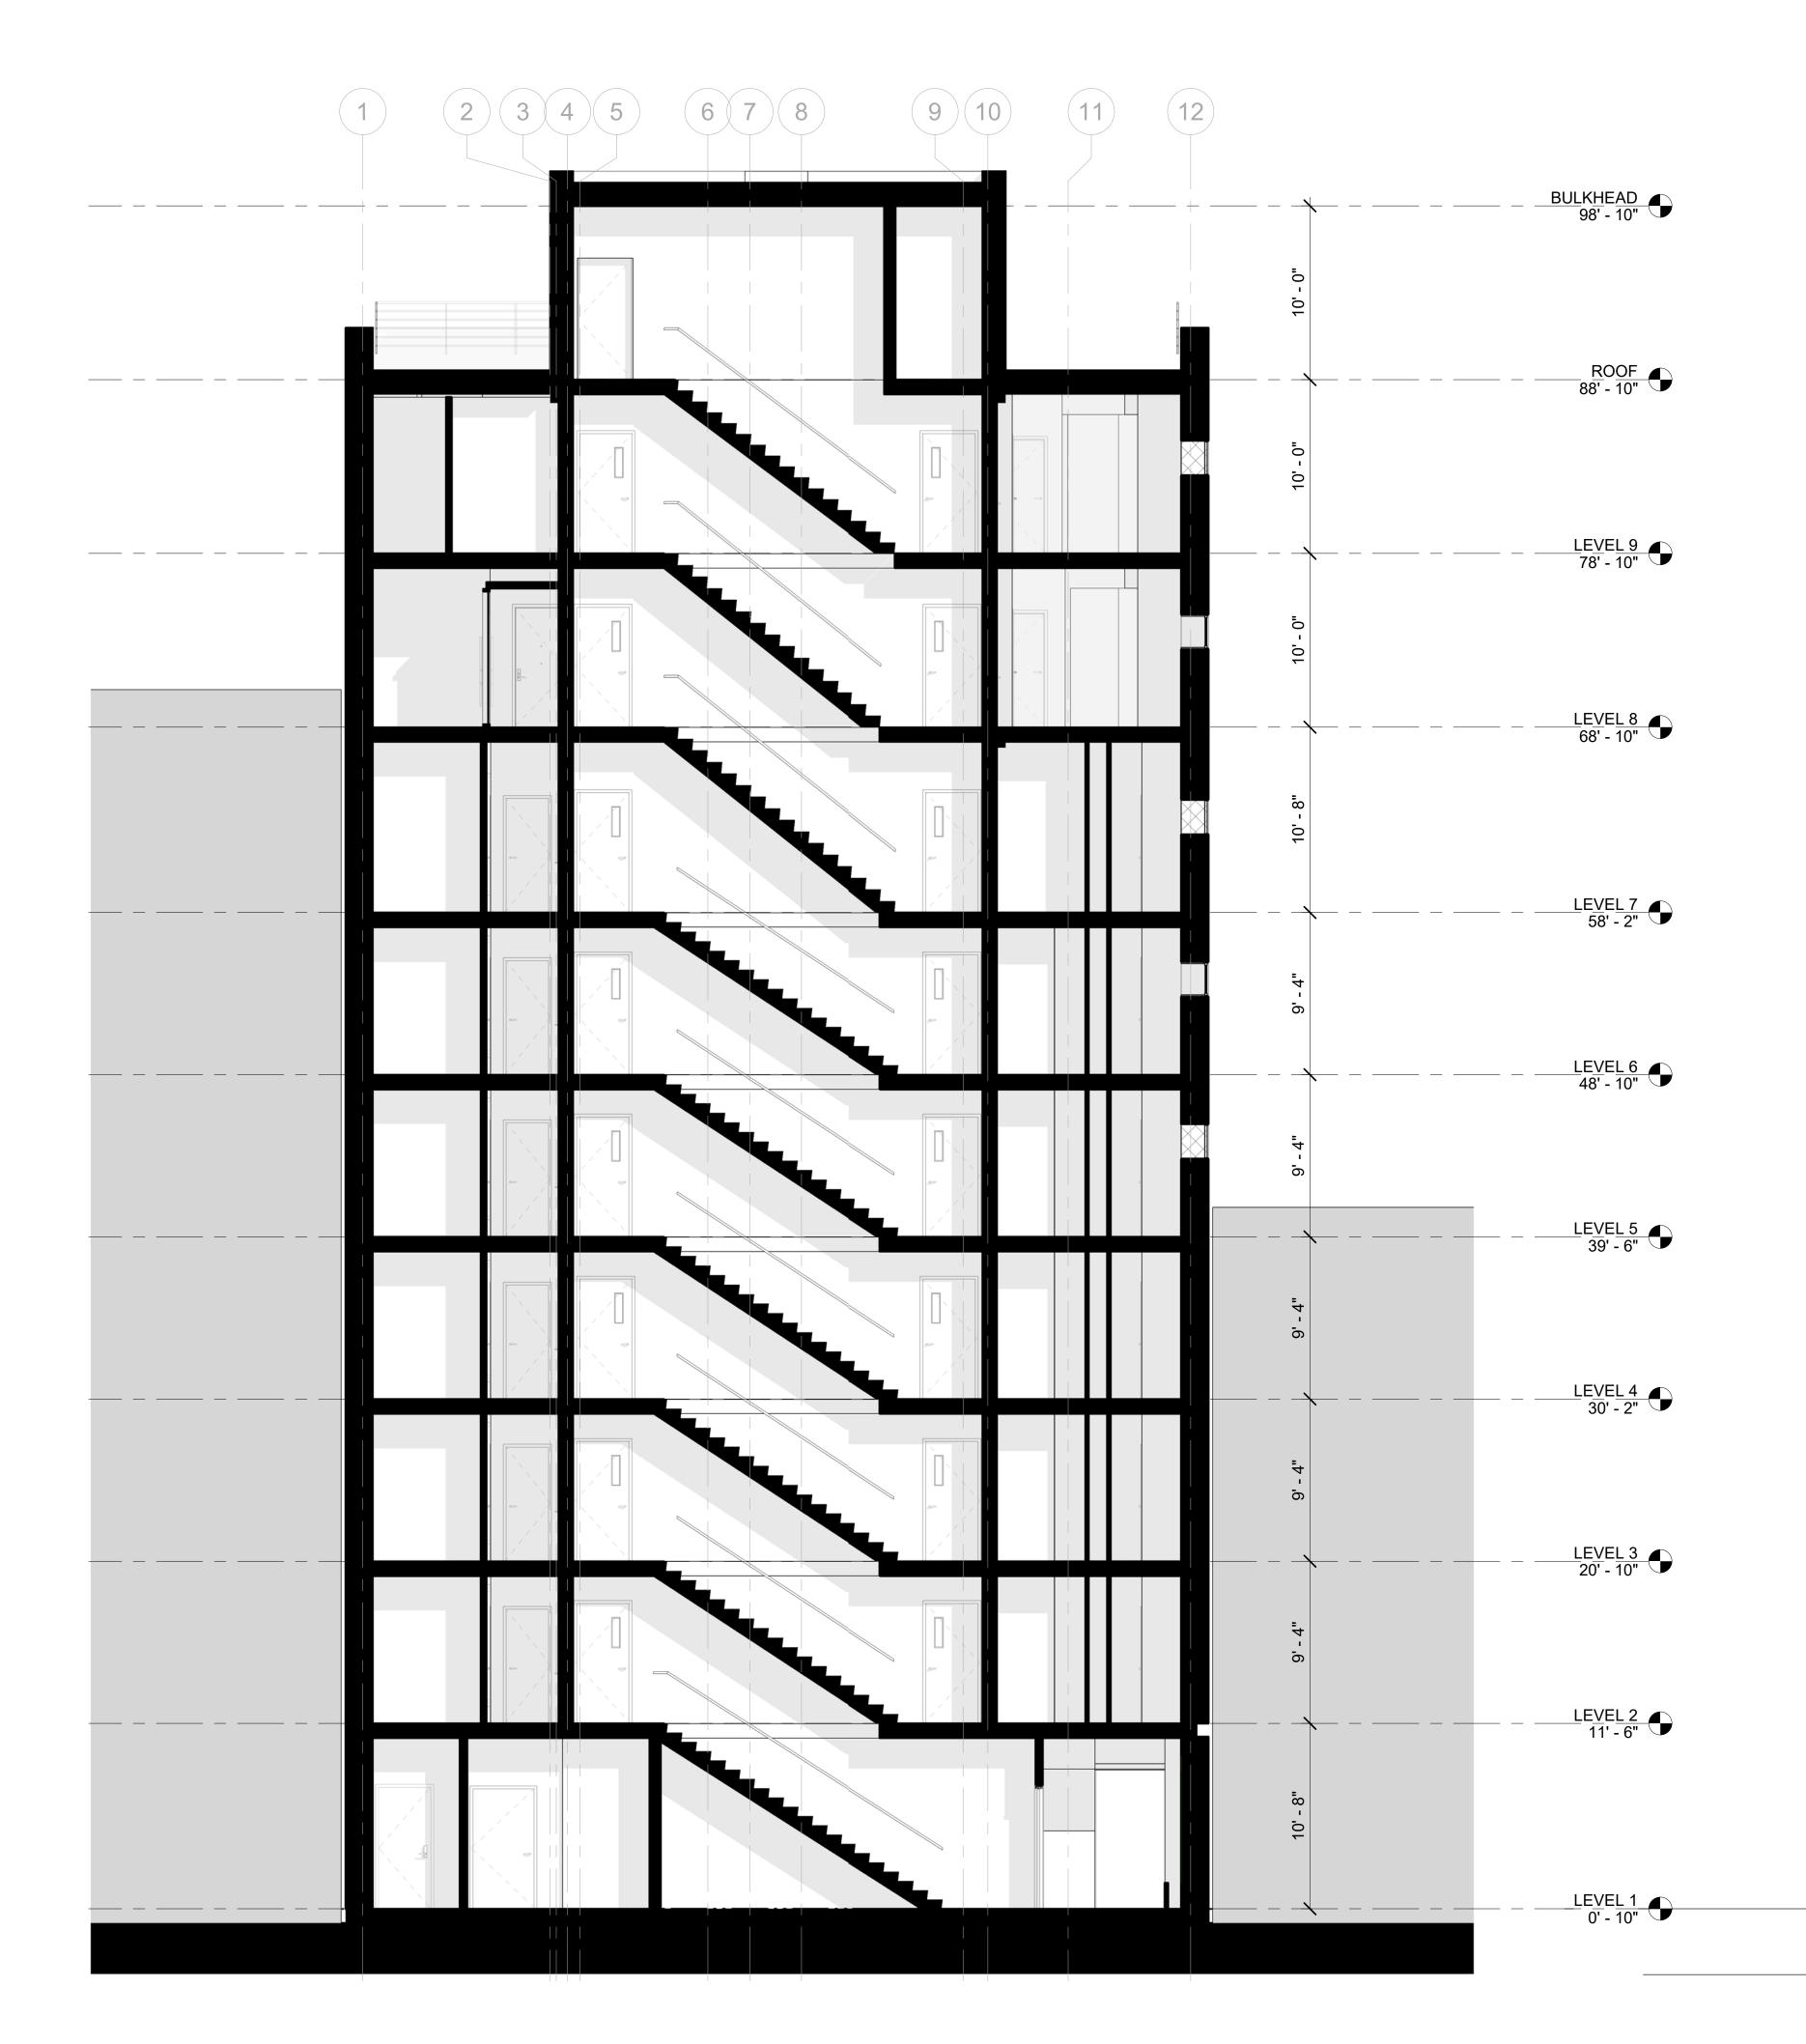

SITE A-2 31 BARTLETT ST, BROOKLYN NY

Owr



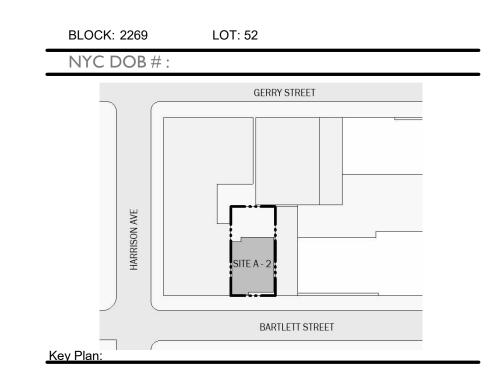

NUMBER DATE DESCRIPTION

Architect:

MAP

Magnusson Architecture & Planning PC

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Client Representative:

Filing Representative:


Tel (631) 978-5000


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BUILDING SECTION

SEAL & SIGNATURE:	PROJECT No: 19022
	DRAWING BY: Author
	CHK BY: Checker
	DWG No:
	A-302.00
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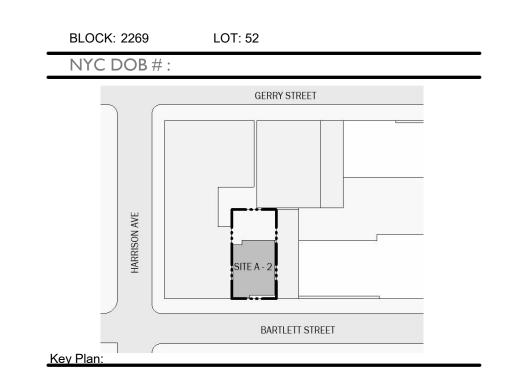
1) ENLARGED FLOOR PLAN (LOBBY) 1/4" = 1'-0"

BARTLETT CROSSING

SITE A-2 31 BARTLETT ST, BROOKLYN NY

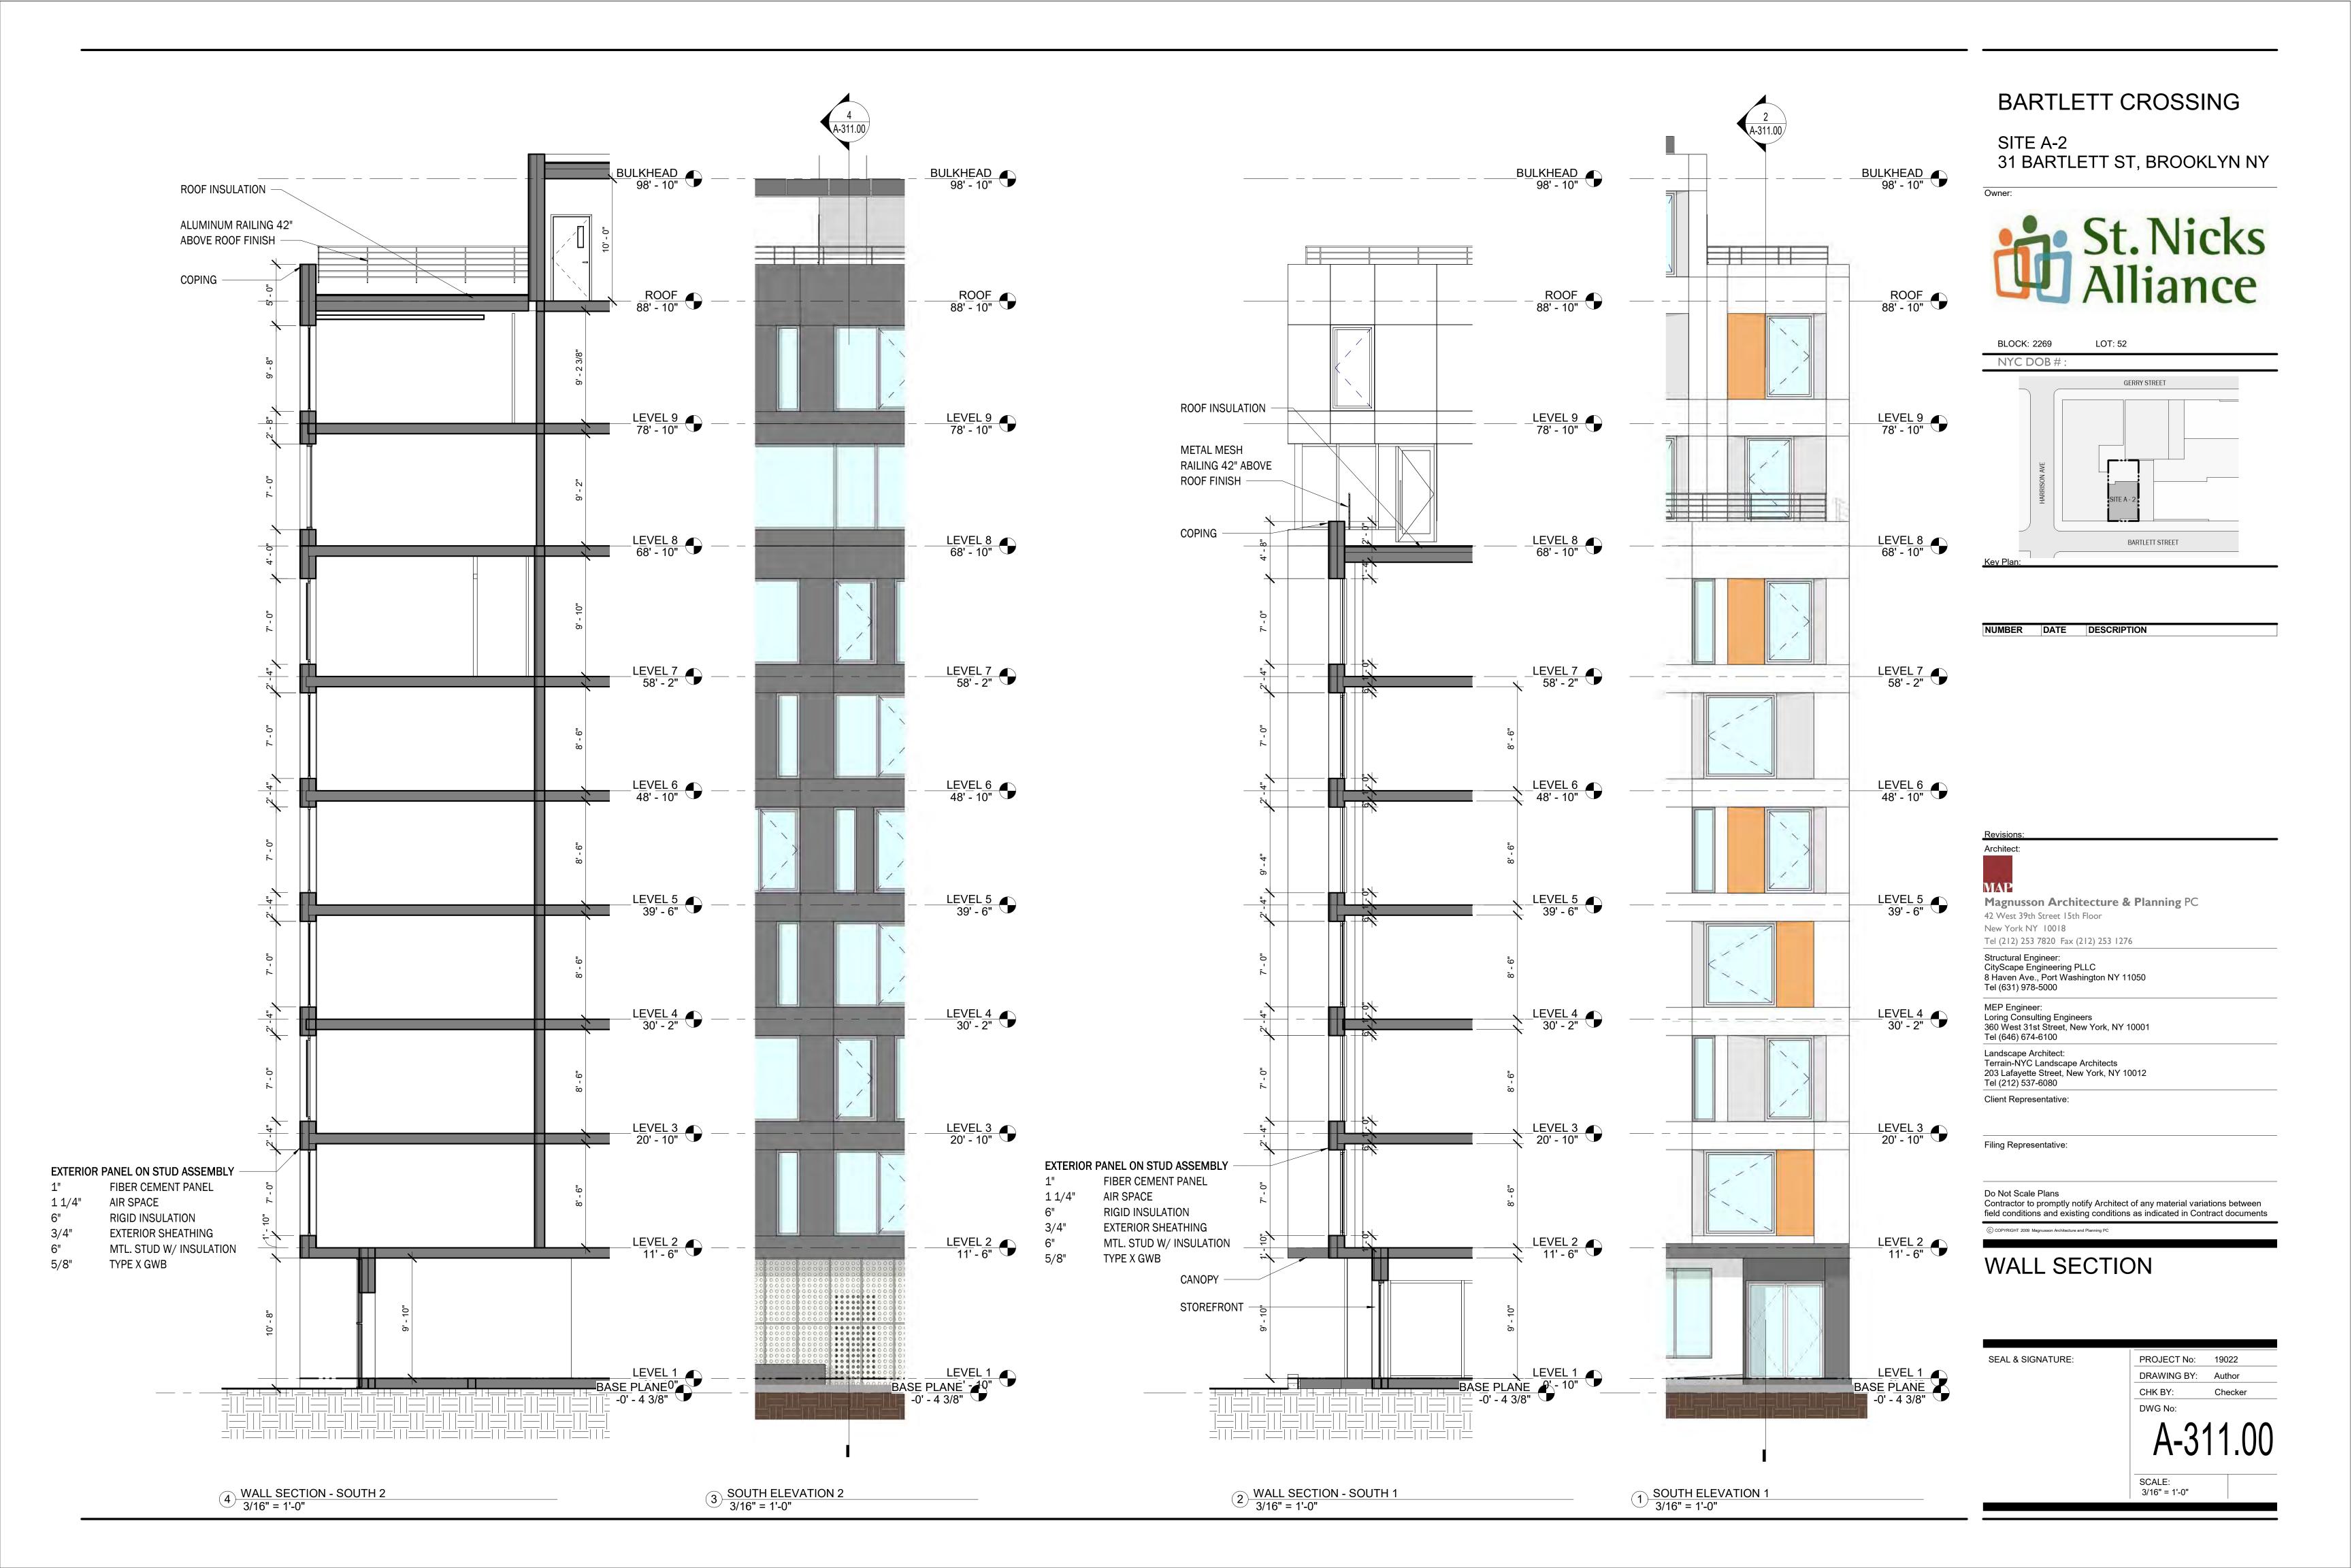Own

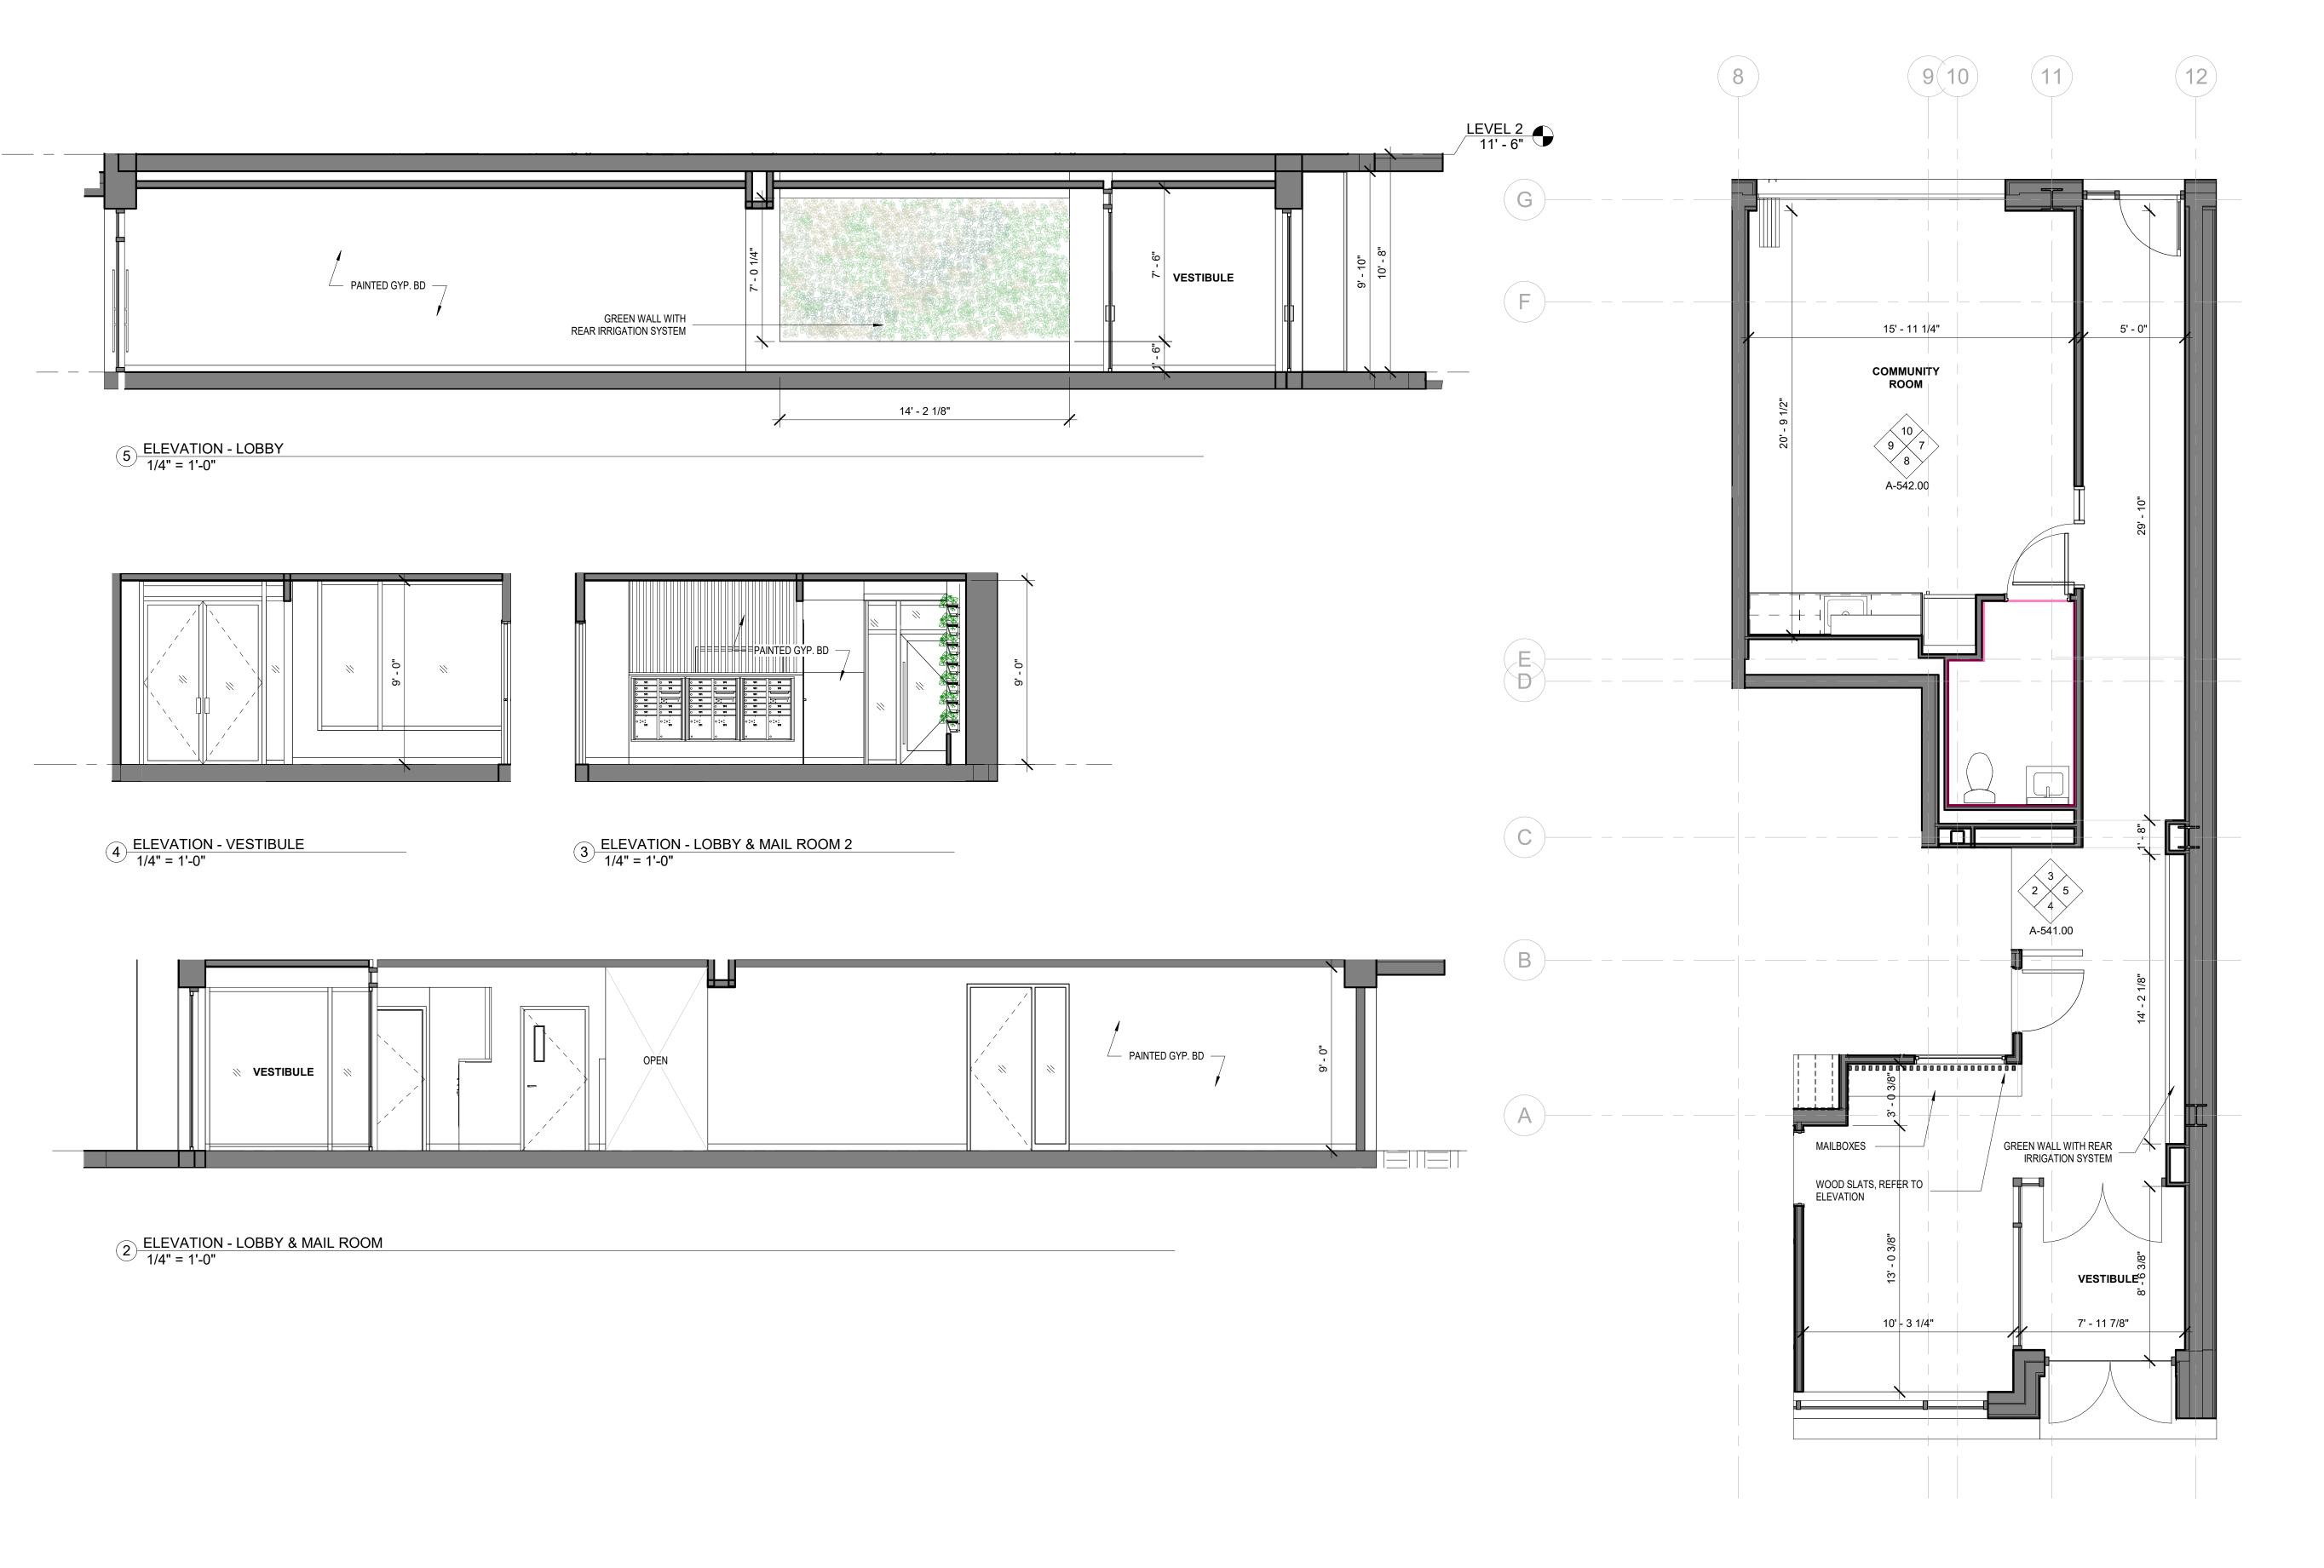



NUMBER DATE DESCRIPTION

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Tel (212) 537-6080

Client Representative:


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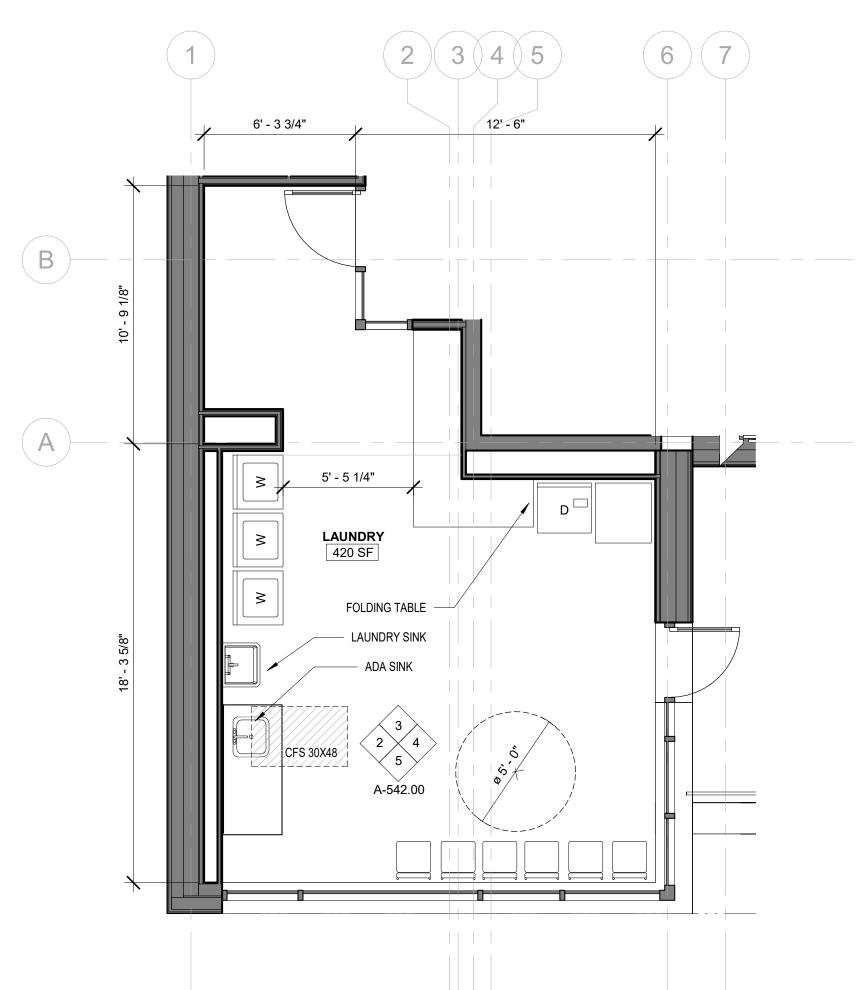
LOBBY & MAIL PLAN AND ELEVATIONS


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	CHK BY:	Checker
	DWG No:	
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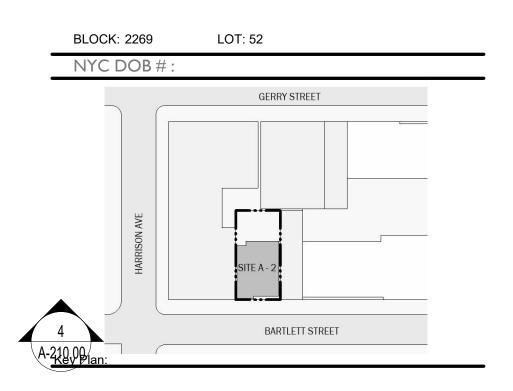




SITE A-2 31 BARTLETT ST, BROOKLYN NY

lwner.

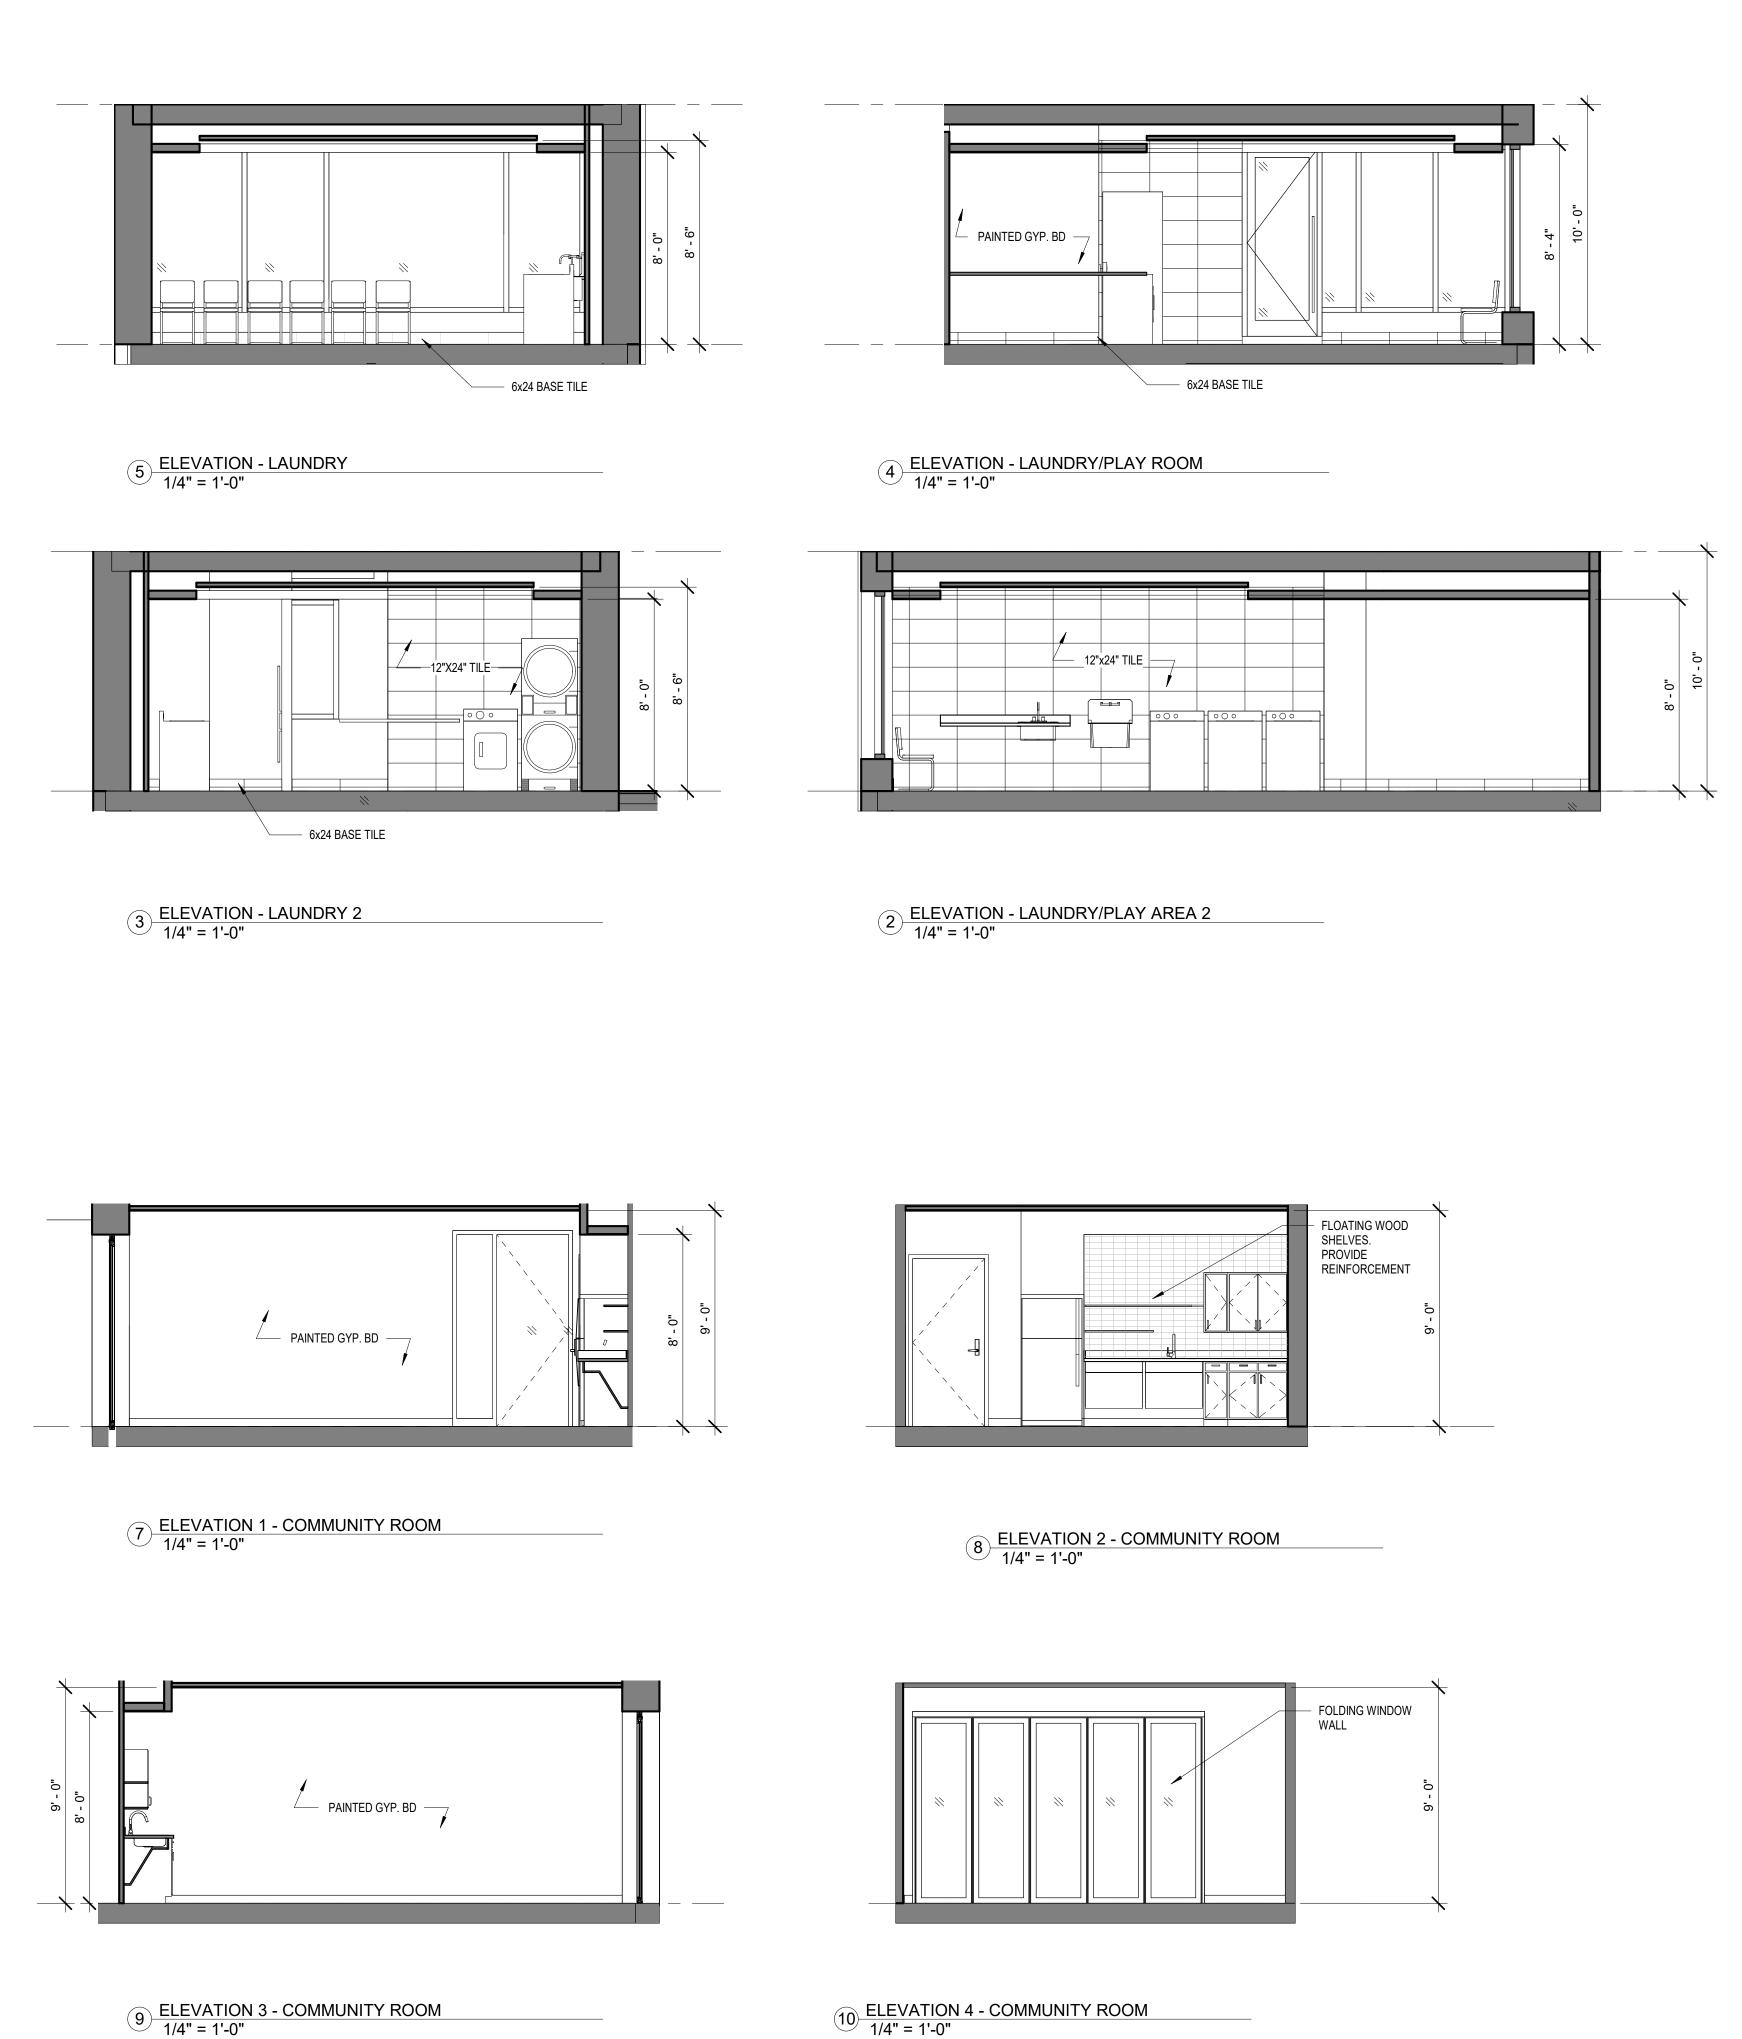

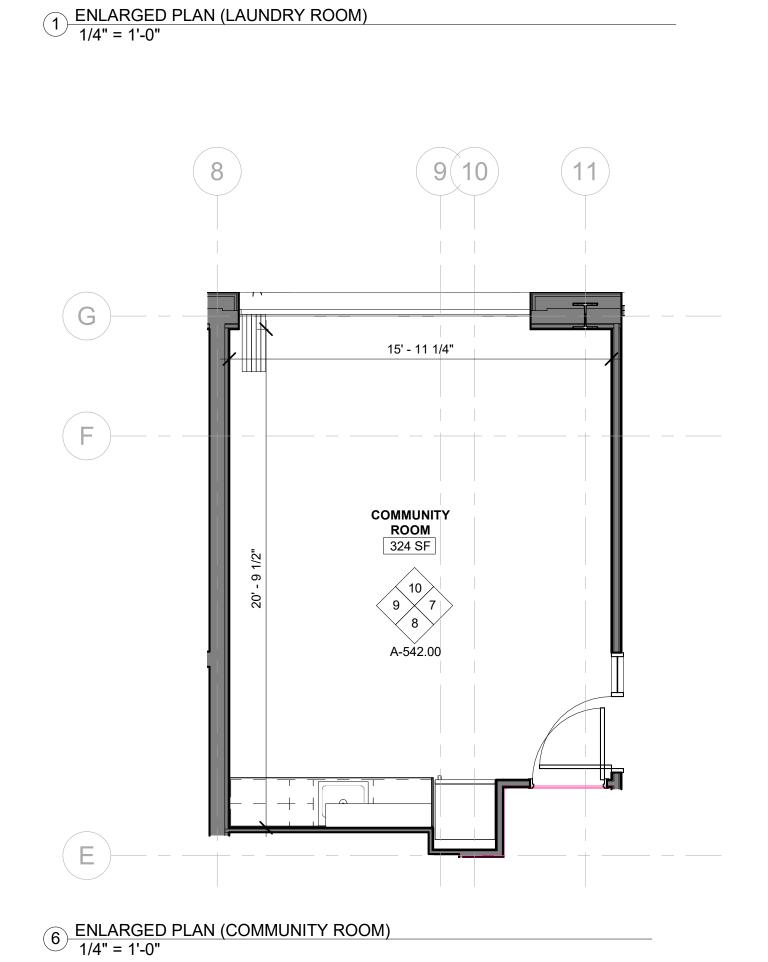

NUMBER DATE DESCRIPTION

Revisions Architect

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Structural Engineer:
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Client Representative:

Filing Representative:

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LAUNDRY & COMMUNITY ROOM PLANS & ELEVATIONS

SEAL & SIGNATURE:

PROJECT No: 19022

DRAWING BY: Author

CHK BY: Checker

DWG No:

A-542.00

ZONING CALCULATIONS FOR RESIDENTIAL BIKE ROOM

PER ZR 25-811 MIN. REQUIRED RESIDENTIAL ENCLOSED BICYCLE PARKING 1 PER 2 DWELLING UNITS NUMBER OF DWELLING UNITS:


REQUIRED NUMBER OF SPACES:

29 UNITS
15 SPACES

NUMBER OF SPACES PROVIDED: 14 SPACES + 1 ACCESSIBLE

PER ZR 25-83 MIN. SIZE OF BIKE STORAGE ROOM
REQUIRED SQUARE FOOTAGE:
15SF PER BICYCLE X 15 SPACES = 225 SF
PROPOSED SQUARE FOOTAGE:
156SF

** MAP TO REQUEST A REDUCTION OF THE REQUIRED ROOM AREA.

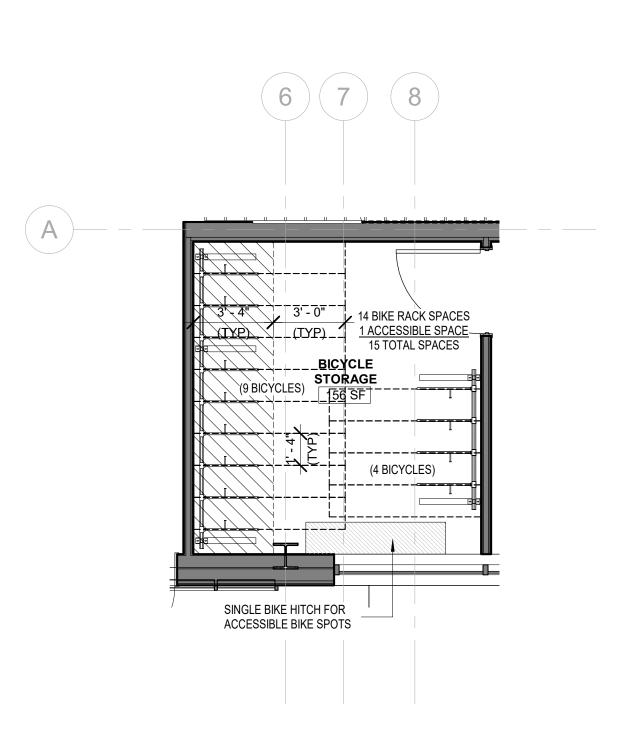


BARTLETT CROSSING

SITE A-2 31 BARTLETT ST, BROOKLYN NY

Owner



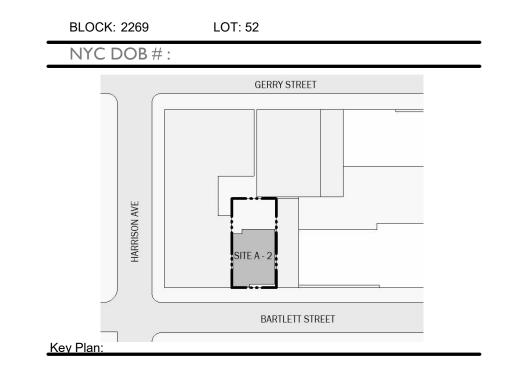

NUMBER DATE DESCRIPT



BIKE STORAGE ROOM

EAL & SIGNATURE:	PROJECT No:	19022
	DRAWING BY:	Author
	CHK BY:	Checker
	DWG No:	
	A-54	43.00
	SCALE: 1/4" = 1'-0"	

Brownfield Cleanup Program Application Broadway Triangle Site A APPENDIX C

Property's Environmental History (Previous Reports Provided as Separate Files)

ROUX 3605.0001Y108/CVRS

Broadway Triangle Site A
663-667 Flushing Avenue and 29-31 Bartlett Street, Brooklyn, New York 11206
BCP Application - Section III

The following previous environmental investigations have been conducted at the Site are attached for review in Appendix C and on the enclosed CD:

- Phase I Environmental Site Assessment (ESA), prepared by Environmental Business Consultants (EBC), dated November 19, 2019
- Remedial Investigation Report Site A1, prepared by Gallagher Bassett Technical Services, dated June 2020
- Remedial Investigation Report Site A2, prepared by Gallagher Bassett Technical Services, dated June 2020
- **BCP Eligibility Soil Sampling Summary Parcel A1**, prepared by Roux Environmental Engineering and Geology, D.P.C., dated January 4, 2021

A summary of the findings from the Site is provided below.

<u>Phase I Environmental Site Assessment (ESA), prepared by Environmental Business Consultants, dated November 19, 2019</u>

No recognized environmental conditions (RECs) or controlled recognized environmental conditions (CRECs) were identified in the EBC Phase I ESA. EBC identified one historic recognized environmental conditions (HREC) and several environmental concerns (ASTM Non-Scope issues/Business Environmental Risks [BERs]). The HRECs and BERs are summarized as follows:

HREC

• The Site, 29-31 Bartlett Street (A1 - Block 2269 Lot 52), was listed on the PBS-AST database (NYSDEC PBS ID No. 2611766) in connection with one 3,000-gallon steel AST containing No. 2 fuel oil, which was installed in 1990 and closed/removed in 2012. The Site was not cross-listed on the LTANKS database in connection with any spills originating from the former AST. Site A2 was also listed on the NYSPILLs database related to one closed spill incident (NYSDEC Spill No. 95-06117) at a residence formerly located at 29 Bartlett Street. This spill, which occurred on August 17, 1995, was related to the release of approximately 40 gallons of fuel oil during a delivery. According to available records, the spill was contained on the sidewalk area and cleaned using sorbents. The NYSDEC closed the spill on August 24, 1995, within one week of the initial spill report filing. Although copies of the tank closure and/or the spill remediation reports were not provided to EBC, given the nature of the release and the closed status of the AST and spill, EBC considered the Site's listing on the PBS-AST and NYSPILLs databases to be a HREC that did not warrant further investigation.

BERs

- As most of the Site was formerly developed with the multiple buildings, there is a potential for fill
 materials to be present (utilized to backfill the foundations and/or basements of the former structures
 following their demolition). As no information regarding the nature of source of the fill materials was
 available for review, EBC identified the potential for contaminated and/or structurally unsuitable
 materials to be present on the Site.
- The entire Site is identified as having E-Air Quality and/or Noise restrictions (E-238), which were determined during the Broadway Triangle Rezoning completed by the City in December 2009 (CEQR 09HPD019K). The Noise E-Designation applies to all five lots of Site A1 and requires that any future residential/commercial development must provide a closed-window condition with a minimum 30 decibels (dBA) window/wall attenuation on all facades to achieve an acceptable indoor noise environment of 45 dBA. In order to maintain a closed-window condition, an alternative means of ventilation must also be provided. Alternative means of ventilation means, but is not limited to, central air conditioning, or through wall air conditioning sleeves fitted with an air conditioner. The Air Quality E-Designation for these five lots requires that any new residential and/or commercial development

ROUX -1- 3605.0001Y108/APC

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utilize natural gas for the heating, ventilation and air conditioning and that stacks must be 60 feet from the northern and western lot lines to avoid any potential significant adverse air quality impacts. The property at 29-31 Bartlett Street (Site A2, Block 2269 Lot 52) also has an E-Designation for Air. The Air Quality E-Designation for this lot requires that any new residential and/or commercial development must utilize natural gas as the fuel for heating, ventilation and air conditioning with no stack set back requirements. EBC considered the presence of E-Noise and Air Quality designations to be a BER.

Remedial Investigation Report - Site A1, prepared by Gallagher Basset Technical Services, dated June 2020

GBTS performed a remedial investigation at Site A1 in April 2020, which is described in the Remedial Investigation Report (RIR) provided in Appendix C. During the RI, 12 soil samples were collected from 6 soil borings, 3 groundwater samples were collected from temporary wells, and 4 soil vapor samples were collected from temporary monitoring points. A summary of findings is provided below:

Soil/Fill

According to the GBTS RIR for Site A1, the following analytes exceeded the NYSDEC Part 375 Restricted Residential Soil Cleanup Objectives (RRSCOs):

Semivolatile Organic Compounds (SVOCs)

• Benzo(a)anthracene, benzo(a)pyrene, benzo(b)fluoranthene, benzo(k)fluoranthene, chrysene, dibenzo(a,h)anthracene, and indeno(1,2,3-cd)pyrene)

Metals

Barium, lead, and mercury

Pesticides

Dieldrin

Exceedances of RRSCOs and Unrestricted Use Soil Cleanup Objectives (UUSCOs) within the boundaries of the Site are depicted on Figure 4.

Groundwater

According to the GBTS RIR for Site A1, the following analytes exceeded NYSDEC Ambient Water Quality Standards and Guidance Values (AWQSGVs):

Metals (total)

Iron, manganese, selenium, and sodium

Metals (dissolved)

Iron, manganese, selenium, and sodium

Exceedances of AWQSGVs within the boundaries of the Site are depicted on Figure 5.

Soil Vapor

According to the GBTS RIR for Site A1, the following analytes were detected in soil vapor:

Volatile Organic Compounds (VOCs):

• 1,3-butadiene, 2-butanone, 4-methyl-2-pentanone, acetone, benzene, carbon disulfide, dichlorodifluoromethane, ethylbenzene, isopropanol, methyl methacrylate, n-heptane, n-hexane, propylene, styrene, tetrachloroethene, toluene, and trichlorofluoromethane

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Detections of analytes in soil vapor within the boundaries of the Site are depicted on Figure 6.

Remedial Investigation Report – Site A2, prepared by Gallagher Basset Technical Services, dated June 2020

GBTS performed a remedial investigation at Site A2 in April 2020, which is described in the RIR provided in Appendix C. In total, 13 soil samples were collected from three soil borings in addition to one groundwater sample from a temporary well and three soil vapor samples from temporary monitoring points. A summary of findings is provided below:

Soil/Fill

According to the GBTS RIR for Site A2, the following analytes exceeded NYSDEC Part 375 Restricted Residential Soil Cleanup Objectives (RRSCOs):

SVOCs

 Benzo(a)anthracene, benzo(a)pyrene, benzo(b)fluoranthene, benzo(k)fluoranthene, chrysene, dibenzo(a,h)anthracene, and indeno(1,2,3-cd)pyrene)

Metals

Barium and lead

Exceedances of RRSCOs and UUSCOs within the boundaries of the Site are depicted on Figure 4.

Groundwater

According to the GBTS RIR for Site A2, the following analytes exceeded NYSDEC AWQSGVs:

Metals (total)

• Iron, magnesium, manganese, and sodium

Metals (dissolved)

Magnesium, manganese, and sodium

Exceedances of AWQSGVs within the boundaries of the Site are depicted on Figure 5.

Soil Vapor

According to the GBTS RIR for Site A2, the following analytes were detected in soil vapor:

VOCs

• 1,1,1-trichloroethane, 1,1,2-trichloro-1,2,2-trifluoroethane, 1,2,4-trimethylbenzene, 1,3-butadiene, 2-butanone, 2-hexanone, 4-methyl-2-pentanone, acetone, benzene, carbon disulfide, carbon tetrachloride, chloroform, cyclohexane, dichlorodifluoromethane, ethylbenzene, isopropanol, methyl methacrylate, n-heptane, n-hexane, o-xylene, p/m-xylene, p-ethyltoluene, styrene, tetrachloroethene, toluene, trichloroethene, and trichlorofluoromethane

Detections of analytes in soil vapor within the boundaries of the Site are depicted on Figure 6.

BCP Eligibility Soil Sampling Summary – Parcel A1, prepared by Roux Environmental Engineering and Geology, D.P.C, dated January 4, 2021

Roux performed a shallow soil investigation in December 2020, which is described in the Brownfield Cleanup Program (BCP) Eligibility Soil Sampling Summary Report and is attached to this application (Appendix C). In total, five soil samples (including QA/QC) were collected from two soil borings advanced on Block 2272, Lots 51 and 52.

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Soil/Fill

According to the Roux Site investigation the following analytes are in exceedance of the NYSDEC Part 375 RRSCOs:

SVOCs:

• Benzo(a)anthracene, benzo(a)pyrene, benzo(b)fluoranthene, chrysene, dibenzo(a,h)anthracene, and indeno(1,2,3-c,d)pyrene

Metals:

· Arsenic, barium, lead, and mercury

Exceedances of the RRSCOs and UUSCOs within the boundaries of the proposed Site are depicted on Figure 4.

SOIL RRSCO EXCEEDANCE SUMMARY

The proposed Site redevelopment plan is to provide affordable multifamily residential housing; therefore, the available soil data was compared to the NYSDEC Restricted Residential Soil Cleanup Objectives (RRSCOs). Based on the proposed post-redevelopment Site use, soil exceedances of RRSCOs serve as the threshold for the Site's entry into the NYSDEC BCP. A summary of the RRSCO exceedances in soil is presented below. Additional soil sampling and analysis is planned as part of the Remedial Investigation upon acceptance into the NYSDEC Brownfields Cleanup Program. Exceedances of the RRSCOs within the boundaries of the proposed Site are graphically depicted on Figure 4.

Semivolatile Organic Compounds (SVOCs)

Laboratory analytical data for the exceedances of RRSCOs for SVOCs are summarized below with the maximum concentration and location noted in red text.

Analyte	Number of RRSCO Exceedances	Location of SCO Exceedance	Concentrations (mg/kg or ppm)	RRSCO (mg/kg or ppm)
		SB-01/MW-03 (0-2 ft bls) – Block 2272 Lot 49	4.87	
		SB-02 (0-2 ft bls) – Block 2272 Lot 53	1.32	
		SB-04 (0-2 ft bls) – Block 2272 Lot 108	6.56	
		SB-06/MW-02 (0-2 ft bls) – Block 2272 Lot 49	9.00	
		RXA-5101 (0-2 ft bls) – Block 2272 Lot 51	7.00	
Ponzo(a)anthrocono	11	RXA-5201 (0-2 ft bls) – Block 2272 Lot 52	3.40	1
Benzo(a)anthracene	11	RXA-5201 DUP (0-2 ft bls) – Block 2272 Lot 52	7.60	1
		SB-01 (0-2 ft bls) – Block 2269 Lot 52	2.64	
		SB-01 (4-6 ft bls) – Block 2269 Lot 52	1.66	
		SB-02 (0-2 ft bls) – Block 2269 Lot 52	7.29	
		SB-03/MW-03 (0-2 ft bls) – Block 2269 Lot 52	1.45	
		SB-01/MW-03 (0-2 ft bls) – Block 2272 Lot 49	4.17	
		SB-02 (0-2 ft bls) – Block 2272 Lot 53	1.27	
		SB-04 (0-2 ft bls) – Block 2272 Lot 108	6.81	
		SB-06/MW-02 (0-2 ft bls) – Block 2272 Lot 49	9.19	
D	11	RXA-5101 (0-2 ft bls) – Block 2272 Lot 51	7.60	1
Benzo(a)pyrene	11	RXA-5201 (0-2 ft bls) – Block 2272 Lot 52	4.30	1
		RXA-5201 DUP (0-2 ft bls) – Block 2272 Lot 52	8.80	
		SB-01 (0-2 ft bls) – Block 2269 Lot 52	2.63	
		SB-01 (4-6 ft bls) – Block 2269 Lot 52	1.69	

<u>Appendix C – Property's Environmental History</u>

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Analyte RRSCO Location of SCO Exceedance Exceedances SB-02 (0-2 ft bls) – Block 2269 Lot 52		Analyte RRSCO Location of SCO Exce		Concentrations (mg/kg or ppm)	RRSCO (mg/kg or ppm)
		SB-02 (0-2 ft bls) – Block 2269 Lot 52	5.80		
		SB-03/MW-03 (0-2 ft bls) – Block 2269 Lot 52	1.35		
		SB-01/MW-03 (0-2 ft bls) – Block 2272 Lot 49	3.59		
		SB-02 (0-2 ft bls) – Block 2272 Lot 53	1.2		
		SB-04 (0-2 ft bls) – Block 2272 Lot 108	6.15		
		SB-06/MW-02 (0-2 ft bls) – Block 2272 Lot 49	8.76		
		RXA-5101 (0-2 ft bls) – Block 2272 Lot 51	10.00		
Benzo(b)fluoranthene	11	RXA-5201 (0-2 ft bls) – Block 2272 Lot 52	5.30	1	
berizo(b)iluoraritrierie	11	RXA-5201 DUP (0-2 ft bls) – Block 2272 Lot 52	12.00	'	
		SB-01 (0-2 ft bls) – Block 2269 Lot 52	2.62		
		SB-01 (4-6 ft bls) – Block 2269 Lot 52	1.62		
		SB-02 (0-2 ft bls) – Block 2269 Lot 52	4.86		
		SB-03/MW-03 (0-2 ft bls) – Block 2269 Lot 52	1.16		
		SB-04 (0-2 ft bls) – Block 2272 Lot 108	5.80		
		SB-06/MW-02 (0-2 ft bls) – Block 2272 Lot 49	7.46		
Benzo(k)fluoranthene	4	RXA-5201 DUP (0-2 ft bls) – Block 2272 Lot 52	4.40	3.9	
		SB-02 (0-2 ft bls) – Block 2269 Lot 52	4.05		
		SB-01/MW-03 (0-2 ft bls) – Block 2272 Lot 49	4.28		
		SB-04 (0-2 ft bls) – Block 2272 Lot 108	6.27		
		SB-06/MW-02 (0-2 ft bls) – Block 2272 Lot 49	8.62		
Chrysene	6	RXA-5101 (0-2 ft bls) – Block 2272 Lot 51	6.80	3.9	
		RXA-5201 DUP (0-2 ft bls) – Block 2272 Lot 52	8.00		
		SB-02 (0-2 ft bls) – Block 2269 Lot 52	7.06		
		SB-01/MW-03 (0-2 ft bls) – Block 2272 Lot 49	0.766		
		SB-04 (0-2 ft bls) – Block 2272 Lot 108	1.61		
		SB-06/MW-02 (0-2 ft bls) – Block 2272 Lot 49	2.04		
D '' (- 1) (1		RXA-5101 (0-2 ft bls) – Block 2272 Lot 51	1.40		
Dibenzo(a,h)anthracen e	8	RXA-5201 (0-2 ft bls) – Block 2272 Lot 52	0.81	0.33	
		RXA-5201 DUP (0-2 ft bls) – Block 2272 Lot 52	1.70		
		SB-01 (0-2 ft bls) – Block 2269 Lot 52	0.421		
		SB-02 (0-2 ft bls) – Block 2269 Lot 52	1.30		
		SB-01/MW-03 (0-2 ft bls) – Block 2272 Lot 49	1.84		
		SB-02 (0-2 ft bls) – Block 2272 Lot 53	0.663		
		SB-03/MW-01 (0-2 ft bls) – Block 2272 Lot 53	0.589		
		SB-03/MW-01 (4-6 ft bls) – Block 2272 Lot 53	0.531		
		SB-04 (0-2 ft bls) – Block 2272 Lot 108	4.13		
Indeno(1,2,3-	4.4	SB-05 (0-2 ft bls) – Block 2272 Lot 51/52	0.551	0.5	
C,D)Pyrene	14	SB-06/MW-02 (0-2 ft bls) – Block 2272 Lot 49	5.55	0.5	
		RXA-5101 (0-2 ft bls) – Block 2272 Lot 51	4.90		
		RXA-5201 (0-2 ft bls) – Block 2272 Lot 52	2.70		
		RXA-5201 DUP (0-2 ft bls) – Block 2272 Lot 52	5.50		
		SB-01 (0-2 ft bls) – Block 2269 Lot 52	2.06		

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Analyte	Number of RRSCO Exceedances	Location of SCO Exceedance	Concentrations (mg/kg or ppm)	RRSCO (mg/kg or ppm)
SB-01 (4-6 ft bls) – Block 2269 Lot 52		1.35		
		SB-02 (0-2 ft bls) – Block 2269 Lot 52	3.32	
		SB-03/MW-03 (0-2 ft bls) – Block 2269 Lot 52	0.996	

Metals

Laboratory analytical data for the exceedances of RRSCOs for metals are summarized below with the maximum concentration and location noted in red text.

Analyte	Number of RRSCO Exceedances	Location of SCO Exceedance	Concentrations (mg/kg or ppm)	RRSCO (mg/kg or ppm)
Arsenic	2	RXA-5201 (0-2 ft bls) – Block 2272 Lot 52 RXA-5201 DUP (0-2 ft bls) – Block 2272 Lot 52	24.3 18.7	16
Barium	10	SB-02 (0-2 ft bls) – Block 2272 Lot 53 SB-04 (0-2 ft bls) – Block 2272 Lot 108 SB-05 (0-2 ft bls) – Block 2272 Lot 51/52 SB-06/MW-02 (0-2 ft bls) – Block 2272 Lot 49 RXA-5101 (0-2 ft bls) – Block 2272 Lot 51 RXA-5201 (0-2 ft bls) – Block 2272 Lot 52 RXA-5201 DUP (0-2 ft bls) – Block 2272 Lot 52 SB-01 (0-2 ft bls) – Block 2269 Lot 52 SB-01 (4-6 ft bls) – Block 2269 Lot 52 SB-02 (0-2 ft bls) – Block 2269 Lot 52	1130 884 1080 1660 726 807 1880 506 870 1490	400
Lead	7	SB-03/MW-01 (0-2 ft bls) – Block 2272 Lot 53 SB-06/MW-02 (0-2 ft bls) – Block 2272 Lot 49 SB-06/MW-02 (4-6 ft bls) – Block 2272 Lot 49 RXA-5101 (0-2 ft bls) – Block 2272 Lot 51 RXA-5201 (0-2 ft bls) – Block 2272 Lot 52 RXA-5201 DUP (0-2 ft bls) – Block 2272 Lot 52 SB-02 (0-2 ft bls) – Block 2269 Lot 52	473 1810 583 578 880 2290	400
Mercury	5	SB-04 (0-2 ft bls) – Block 2272 Lot 108 SB-05 (0-2 ft bls) – Block 2272 Lot 51/52 SB-06/MW-02 (4-6 ft bls) – Block 2272 Lot 49 RXA-5201 (0-2 ft bls) – Block 2272 Lot 52 RXA-5201 DUP (0-2 ft bls) – Block 2272 Lot 52	0.812 0.921 3.20 0.870 1.30	0.81

Pesticides

Laboratory analytical data for the exceedances of RRSCOs for pesticides are summarized below with the maximum concentration and location noted in red text.

Analyte	Number of RRSCO Exceedances	Location of SCO Exceedance	Concentrations (mg/kg or ppm)	RRSCO (mg/kg or ppm)
Dieldrin	1	SB-04 (0-2 ft bls) – Block 2272 Lot 108	0.298	0.2

Brownfield Cleanup Program Application Broadway Triangle Site A APPENDIX D

Property Information

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Appendix D - Property Description Narrative

Broadway Triangle Site A
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Location

The Site is located at 29-31 Bartlett Street and 663-667 Flushing Avenue, Brooklyn, New York encompassing Kings County Tax Map Block 2272, Lots 49, 51, 52, 53, and 108 (Site A1) and Block 2269, Lot 52 (Site A2). Site A1 is bounded to the north by an automotive repair facility, to the south by Flushing Avenue and Whipple Street, and to the east and west by multi-family residential buildings. Site A2 is bounded to the north and west by a construction site, to the south by Bartlett Street, and to the east by a commercial office building. A Site Location Map is provided as Figure 1.

Parcel Address	Block No.	Lot No.	Acreage
31 Bartlett Street	2269	52	0.115
Whipple Street	2272	49	0.073
665 Flushing Avenue	2272	51	0.043
665 Flushing Avenue	2272	52	0.046
663 Flushing Avenue	2272	53	0.046
Bartlett Street	2272	108	0.012

Site Features

The Site is 0.33 acres and is currently comprised of vacant, overgrown land with several patches of exposed concrete, likely from former on-Site structures (Figure 2). The Site is fully enclosed by chain-link fencing with locked gates. Further details on historic Site use are discussed in the *Past Use of the Site* section below.

Current Zoning and Land Use

The current property zoning is R7A for residential use with a C2-4 commercial overlay. R7A districts typically produce high lot coverage (i.e., seven- to nine- story) apartment buildings, blending with existing buildings in many established neighborhoods. The floor area ratio in R7A districts is 4.0. Above a base height of 40 to 65 feet, or 75 feet if providing a qualifying ground floor, the building must set back to a depth of 10 feet on a wide street and 15 feet on a narrow street before rising to a maximum height of 80 feet, or 85 feet if providing a qualifying ground floor. In order to preserve the traditional streetscape, the street wall of a new building can be no closer to the street line, than any adjacent street wall, but need not be farther than 10 feet. Buildings must have interior amenities for the residents pursuant to the Quality Housing Program. Typical retail uses included in C2-4 commercial overlay areas include neighborhood grocery stores, restaurants and beauty parlors and may also include uses such as funeral homes and repair services. In mixed residential / commercial buildings, commercial uses are limited to one or two floors and must always be located below the residential use.

The area surrounding the Site is an urban area comprised primarily of commercial and multi-family residential properties and vacant land (Figure 3). Site A1 is adjoined by the following: a residential construction site and an automotive repair facility to the north, and multi-family residential buildings to the south (across Flushing Avenue and Whipple Street), east, and west. Site A2 is adjoined by the following: an active construction site (former automotive repair facility) and a multi-family residential building to the south (across Bartlett Street); an office building to the east; and an active construction site (anticipated mixed commercial and residential use) to the north and west.

Past Use of the Site

Based on a review of Historic Sanborn fire insurance maps, aerial photographs, city directories, and New York City Assessor's and Building Department records, the following Site history was established. Site A1 was developed as early as 1887 with residential and commercial structures. Former on-Site commercial uses included retail stores, a bakery, carpenter's shop, and a junk shop. The former buildings on Site A1 were demolished by 1980 and the Site has remained vacant since that time. Site A2 is likely to have been in use for residential and commercial purposes since at least 1887. Former on-Site uses included single and

Appendix D - Property Description Narrative

Broadway Triangle Site A
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multi-family residences, a fur dresser, and several retail stores. The former buildings on Site A2 were demolished sometime after 2006 and the Site has remained vacant since that time. No other significant on-Site commercial uses were noted. All six Site lots are currently owned by New York City (NYC) Housing Preservation and Development (HPD).

Site Geology & Hydrogeology

Based on the June 2020 Remedial Investigation performed by Gallagher Basset Technical Services, subsurface materials generally contain fill materials (unsorted sand, gravel, and debris [e.g., brick, concrete, stone, and glass]) to depths ranging from 4 feet to 8 ft bls at Site A1; fill materials overly native orange-brown medium to coarse sands with brown or black clay lenses. At Site A2 subsurface material generally contains fill materials (unsorted sand, gravel, and debris) to depths of 7 to 8 ft bls; fill materials overly native brown medium to coarse gravelly sands interbedded with gray-green clayey silt. Depth to bedrock is unknown. No bedrock was encountered to a maximum depth of 20 ft bls during the RI.

Groundwater flow direction is likely influenced by subsurface utilities, lithology, and other subsurface features. Groundwater, when encountered, was generally between approximately 8 and 10 ft bls at Site A1; the assumed groundwater flow direction is from northwest to southeast. Groundwater, when encountered, was generally between 7 and 8 ft bls at Site A2; the assumed groundwater flow direction is from west to east.

Environmental Assessment

Based upon investigations conducted to date, the primary contaminants of concern for the Site include a subset of semivolatile organic compounds (SVOCs) known as polycyclic aromatic hydrocarbons (PAHs), metals, and the pesticide dieldrin in soil and chlorinated volatile organic compounds (CVOCs) in soil vapor.

Soil – PAHs including benzo(a)anthracene, benzo(a)pyrene, benzo(b)fluoranthene, benzo(k)fluoranthene, chrysene, dibenzo(a,h)anthracene, and indeno(1,2,3-c,d)pyrene were detected above their respective RRSCOs predominantly in shallow soil (0-2 ft bls) throughout Sites A1 and A2. Soil samples collected on Block 2272 Lots 49 and 52 contained the highest detected concentration of PAHs such as benzo(b)fluoranthene (12 milligrams per kilogram [mg/kg] on Block 2272, Lot 52) and benzo(a)pyrene (9.19 mg/kg on Block 2272, Lot 49). Metals including arsenic, barium, lead, and mercury were detected above their respective RRSCOs across multiple lots in the shallow soil samples collected (0-2 ft bls and 4-6 ft bls). The highest detections of all four metals were found in soil samples SB-07 (5-7 ft bls) collected from either Block 2272, Lot 51 or Lot 52. In particular, barium and lead in sample RXA-5201 (0-2 ft bls) DUP were detected at concentrations of 1,880 mg/kg and 2,290 mg/kg, respectively. The pesticide dieldrin exceeded its RRSCO in one sample, SB-04 (0-2 ft bls), collected on Block 2272 Lot 108.

Groundwater – Groundwater samples collected at the Site exceeded the Ambient Water Quality Standards and Guidance Values (AWQSGVs) for metals including iron, magnesium, manganese, sodium, and selenium. The highest concentrations of total and dissolved sodium exceeded the AWQSGV at SB-03/MW-03 (Block 2269 Lot 52), detected at concentrations measuring 68,200 and 62,400 micrograms per liter [ug/L], respectively. The greatest concentrations of total and dissolved magnesium in exceedance of AWQSGVs were also detected at SB-03/MW-03, measured at concentrations of 67,800 and 82,600 ug/L, respectively. Selenium was detected at SB-06/MW-02 and MW-03 (Block 2272 Lot 49) at the highest total and dissolved concentrations measuring 13.2 and 12.8 ug/L, respectively. No groundwater samples exceeded the AWQSGVs for PAHs or pesticides.

Soil Vapor – Soil vapor samples collected at the Site detected numerous volatile organic compounds. Among the compounds detected at multiple soil vapor sample locations were acetone, as well as the chlorinated volatile organic compounds trichloroethene (TCE), tetrachloroethene (PCE), carbon tetrachloride, and trichlorofluoromethane. With the exception of sample SV-04 (Block 2272 Lot 49), concentrations of CVOCs in soil vapor at the Site were measured to be relatively low. PCE and trichlorofluoromethane were detected in sample SV-04 at concentrations measuring 250 and 500 micrograms per cubic meter (ug/m³), respectively.

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Current Property Owner-Operator Information

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Bartlett Crossing LLC, Bartlett Crossing Managers LLC, and Bartlett Crossing UNP LLC have no relationship to previous owners and operators. A summary of the dates that the City of New York took ownership of each tax parcel is provided below.

Tax Parcel	Date	Source
Block 2272, Lot 49	8/17/1982	NYC ACRIS
Block 2272, Lot 51	8/17/1982	NYC ACRIS
Block 2272, Lot 52	5/28/1986	NYC ACRIS
Block 2272, Lot 53	12/24/1973	NYC ACRIS
Block 2272, Lot 108	8/17/1982	NYC ACRIS
Block 2269, Lot 52	4/6/1990	NYC ACRIS

Additional owner and operator information is provided for each tax parcel below.

PREVIOUS OPERATORS' INFORMATION FROM NEW YORK CITY TAX RECORDS Site A1 Block 2272, Lot 49 663 to 667 Flushing Avenue, Brooklyn, New York

Period	Tax Parcel	Owner	Source	Relationship to Requestor
Unknown- 9/26/1978	Block 2272 Lot 49	Yetta Joseph 1474 Brooklyn Avenue, Brooklyn, NY Ruth Schwartz 3165 Nostrand Avenue, Brooklyn, NY	NYC ACRIS	None
9/26/1978- 8/17/1982	Block 2272, Lot 49	3 Whipple Street Corp. 1474 Brooklyn Avenue, Brooklyn, NY	NYC ACRIS	None
8/17/1982- Present	Block 2272, Lot 49	The City of New York City Hall, Manhattan, NY 212-863-6800	NYC ACRIS	None

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PREVIOUS OWNERS' INFORMATION FROM NEW YORK CITY TAX RECORDS Site A1 Block 2272, Lot 51

663 to 667 Flushing Avenue, Brooklyn, New York

Period	Tax Parcel	Owner	Source	Relationship to Requestor
Unknown - 11/12/1973	Block 2272, Lot 51	Joe Joseph 1424 Brooklyn Avenue, Brooklyn, NY	NYC ACRIS	None
11/12/1973 – 8/17/1982	Block 2272, Lot 51	Isidoro Gomez 207 Wallabout Street, Brooklyn, NY -Contact Information Not Available	NYC ACRIS	None
8/17/1982 - Present	Block 2272, Lot 51	The City of New York City Hall, Manhattan, NY 212-863-6800	NYC ACRIS	None

PREVIOUS OWNERS' INFORMATION FROM NEW YORK CITY TAX RECORDS Site A1

Block 2272, Lot 52 663 to 667 Flushing Avenue, Brooklyn, New York

Period	Tax Parcel	Owner	Source	Relationship to Requestor
Unknown - 11/3/1969	Block 2272, Lot 52	Frank Bieder, as devisee of Sophie Bieder 1158 East 100 th Street, Brooklyn, NY	NYC ACRIS	None
11/3/1969 — 6/13/1975	Block 2272, Lot 52	Lothian Realty Corp. 8840 Sutphin Boulevard, Jamaica, NY	NYC ACRIS	None
6/13/1975 - 3/27/1980	Block 2272, Lot 52	The City of New York City Hall, Manhattan, NY 212-863-6800	NYC ACRIS	None
3/27/1980 – 5/28/1986	Block 2272, Lot 52	Frank Prost 124 Widgeon Court, Great River, NY 11739	NYC ACRIS	None
5/28/1986 - Present	Block 2272, Lot 52	The City of New York City Hall, Manhattan, NY 212-863-6800	NYC ACRIS	None

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PREVIOUS OWNERS' INFORMATION FROM NEW YORK CITY TAX RECORDS Site A1

Block 2272, Lot 53

663 to 667 Flushing Avenue, Brooklyn, New York

Period	Tax Parcel	Owner	Source	Relationship to Requestor
Unknown - 10/24/1966	Block 2272, Lot 53	1927 Fulton Street Corp. 1905 Fulton Street, Brooklyn, NY	NYC ACRIS	None
10/24/1966 - 12/24/1973	Block 2272, Lot 53	Henry Terry 663 Flushing Avenue, Brooklyn, NY	NYC ACRIS	None
12/24/1973 - Present	Block 2272, Lot 53	The City of New York City Hall, Manhattan, NY 212-863-6800	NYC ACRIS	None

PREVIOUS OWNERS' INFORMATION FROM NEW YORK CITY TAX RECORDS Site A1 Block 2272, Lot 108

Period	Tax Parcel	Owner	Source	Relationship to Requestor
8/17/1982 - Present	Block 2272, Lot 108	The City of New York City Hall, Manhattan, NY 212-863-6800	NYC ACRIS	None

Broadway Triangle Site A
663-667 Flushing Avenue and 29-31 Bartlett Street Brooklyn, New York 11206
BCP Application - Section VI

PREVIOUS OWNERS' INFORMATION FROM NEW YORK CITY TAX RECORDS Site A2

Block 2269, Lot 52 29 to 31 Bartlett Street, Brooklyn, New York

Period	Tax Parcel	Owner	Source	Relationship to Requestor
Unknown – 5/18/1966	Block 2269, Lot 52	Joel Zalisky and Sylvia Zalisky -Contact Information Not Available	NYC ACRIS	None
5/18/1966 – 12/17/1967	Block 2269, Lot 52	Emelkay Construction Corp 117 Siegel Street, Brooklyn, NY	NYC ACRIS	None
12/17/1967 — 8/1/1968	Block 2269, Lot 52	Broshkov Realty Corp c/o Joel Zalisky 1073 Eastern Parkway, Brooklyn, NY	NYC ACRIS	None
8/1/1968 – 5/16/1969	Block 2269, Lot 52	Kuber Holding Corp. 1045 Ocean Avenue, Brooklyn, NY	NYC ACRIS	None
5/16/1969 – 5/16/1969	Block 2269, Lot 52	Samuel Sutro 2 Fifth Avenue, New York, NY	NYC ACRIS	None
5/16/1969 – 6/14/1979	Block 2269, Lot 52	Catania & Ieraci Realty Corp. 9701 Shore Rd, Brooklyn, NY	NYC ACRIS	None
6/14/1979 - 11/23/1984	Block 2269, Lot 52	The City of New York City Hall, Manhattan, NY 212-863-6800	NYC ACRIS	None
11/23/1984 – 4/6/1990	Block 2269, Lot 52	29-31 Bartlett Street Housing Development Fund Corporation 29-31 Bartlett Street, Brooklyn, NY	NYC ACRIS	None
4/6/1990 - Present	Block 2269, Lot 52	The City of New York City Hall, Manhattan, NY	NYC ACRIS	None

PREVIOUS OPERATORS' INFORMATION FROM SANBORN FIRE INSURANCE MAPS Site A1

Block 2272, Lots 49, 51, 52, 53, 108 663 to 667 Flushing Avenue, Brooklyn, New York

Period	Tax Parcel	Operator	Source	Relationship to Requestor
1887	Block 2272, Lots 49, 51, 52, 53, 108	Residential and commercial structures	Sanborn Maps	None

Broadway Triangle Site A
663-667 Flushing Avenue and 29-31 Bartlett Street Brooklyn, New York 11206
BCP Application - Section VI

Period	Tax Parcel	Operator	Source	Relationship to Requestor
		Commercial uses include retail stores, a bakery, carpenter's shop, and a junk shop		
1918	Block 2272, Lots 49, 51, 52, 53, 108	Same as above (S.A.A) except: -Carpenter's shop converted to storage building	Sanborn Maps	None
1935	Block 2272, Lots 49, 51, 52, 53, 108	Same as above (S.A.A) except: -Westernmost Flushing Ave retail building now carpenter's shop -Two small 1-story storage structures present north of the carpenter's shop -An additional 1-story structure constructed on the central portion of the 665 Flushing Avenue parcel	Sanborn Maps	None
1947-1950	Block 2272, Lots 49, 51, 52, 53, 108	Same as above (S.A.A) except: - Westernmost Flushing Ave retail building now a retail store -The stone yard north of the Flushing Avenue parcels now developed with a 1-story building associated with the adjacent bottling works	Sanborn Maps	None
1965	Block 2272, Lots 49, 51, 52, 53, 108	Same as above (S.A.A)	Sanborn Maps	None
1977-1979	Block 2272, Lots 49, 51, 52, 53, 108	Same as above (S.A.A) except: -Northern and western portions of Flushing Avenue parcels now undeveloped	Sanborn Maps	None
1980-1987	Block 2272, Lots 49, 51, 52, 53, 108	Same as above (S.A.A) except: -Remaining structures on the Flushing Avenue parcels demolished	Sanborn Maps	None
1987-2007	Block 2272, Lots 49, 51, 52, 53, 108	Vacant	Sanborn Maps	None

Broadway Triangle Site A
663-667 Flushing Avenue and 29-31 Bartlett Street Brooklyn, New York 11206
BCP Application - Section VI

PREVIOUS OPERATORS' INFORMATION FROM SANBORN FIRE INSURANCE MAPS Site A2

Block 2269, Lot 52

29 to 31 Bartlett Street, Brooklyn, New York

Period	Tax Parcel	Operator	Source	Relationship to Requestor
1887	Block 2269, Lot 52	Residential and commercial structures -Residential structures include single and multi-family residences -Commercial structures include a fur dresser, and several retail stores	Sanborn Maps	None
1904-1918	Block 2269, Lot 52	Structures undergoing redevelopment with a 5-story retail building	Sanborn Maps	None
1947-1950	Block 2269, Lot 52	Bartlett Street building is identified as a mixed- use (retail and apartment) building	Sanborn Maps	None
1965	Block 2269, Lot 52	Same as above (S.A.A)	Sanborn Maps	None
1980	Block 2269, Lot 52	Same as above (S.A.A)	Sanborn Maps	None
2006	Block 2269, Lot 52	Building demolished; Vacant	Sanborn Maps	None

PREVIOUS OPERATORS' INFORMATION FROM CITY DIRECTORIES Site A1

Block 2272, Lot 53

Period	Tax Parcel	Operator	Source	Relationship to Requestor
1928	Block 2272, Lot 53	ROTHKOPF M -Contact information Not Available	New York Telephone	None
1934	Block 2272, Lot 53	COHEN FANNIE COHEN JOS CONTI CONCETTA CONTI JOHN -Contact Information Not Available	R. L. Polk & Co.	None
1940	Block 2272, Lot 53	A & B Yarn & Trimng Co -Contact Information Not Available	New York Telephone	None

Broadway Triangle Site A
663-667 Flushing Avenue and 29-31 Bartlett Street Brooklyn, New York 11206
BCP Application - Section VI

Period	Tax Parcel	Operator	Source	Relationship to Requestor
1940-1945	Block 2272, Lot 53	A & B Yarn Co -Contact Information Not Available	New York Telephone	None
1949	Block 2272, Lot 53	F & K Store Fixt Co Jenkins Solomon -Contact Information Not Available	New York Telephone Company	None
1960-1970	Block 2272, Lot 53	Williams Saml -Contact Information Not Available	New York Telephone	None

PREVIOUS OPERATORS' INFORMATION FROM CITY DIRECTORIES Site A1

Block 2272, Lot 52

Period	Tax Parcel	Operator	Source	Relationship to Requestor
1928	Block 2272, Lot 52	H ROOFG -Contact information Not Available	New York Telephone	None
1934	Block 2272, Lot 52	BIEDER FRANK BIEDER SAML VEDRO ANNA VEDRO CLARA WARREN JOHN -Contact Information Not Available	R. L. Polk & Co.	None
1940	Block 2272, Lot 52	Bieder S -Contact Information Not Available	New York Telephone	None
1949	Block 2272, Lot 52	Bieder Frank -Contact Information Not Available	New York Telephone Company	None
1960	Block 2272, Lot 52	Bieder Frank De Jesus Monzolie Mrs Heard Earnest Mathie Clifford -Contact Information Not Available	New York Telephone Company	None
1965	Block 2272, Lot 52	Bieder Frank Heard Louise -Contact Information Not Available	New York Telephone	None

Broadway Triangle Site A
663-667 Flushing Avenue and 29-31 Bartlett Street Brooklyn, New York 11206
BCP Application - Section VI

PREVIOUS OPERATORS' INFORMATION FROM CITY DIRECTORIES Site A1

Block 2272, Lot 51

Period	Tax Parcel	Operator	Source	Relationship to Requestor
1934	Block 2272, Lot 51	BROWN CORA BROWN ROSE BROWN THOS GREEN FREDK LUSTER RUTH MATTOCKS ALBERT SPADARO DOMINIC -Contact Information Not Available	R. L. Polk & Co.	None
1949	Block 2272, Lot 51	Einhorn Jos Ortiz Matilda Steckler S -Contact Information Not Available	New York Telephone Company	None
1960	Block 2272, Lot 51	Ball Glass Co Onga Anna Steckler S -Contact Information Not Available	New York Telephone Company	None
1970	Block 2272, Lot 51	El Encanto Barber Shop Quinones Gregoria -Contact Information Not Available	New York Telephone	None

Broadway Triangle Site A
663-667 Flushing Avenue and 29-31 Bartlett Street Brooklyn, New York 11206
BCP Application - Section VI

PREVIOUS OPERATORS' INFORMATION FROM CITY DIRECTORIES Site A1

Block 2272, Lots 49 and 108 663 to 667 Flushing Avenue, Brooklyn, New York *No records in city directory report*

PREVIOUS OPERATORS' INFORMATION FROM CITY DIRECTORIES Site A2

Block 2269, Lot 52
29 to 31 Bartlett Street, Brooklyn, New York
No records in city directory report

Brownfield Cleanup Program Application Broadway Triangle Site A APPENDIX F

Requestor Eligibility Information

ROUX 3605.0001Y108/CVRS

Appendix F - Requestor Eligibility Information

Broadway Triangle Site A
663-667 Flushing Avenue and 29-31 Bartlett Street, Brooklyn, New York 11206
BCP Application – Section VII

Bartlett Crossing LLC, Bartlett Crossing Managers LLC, and Bartlett Crossing UNP LLC (Requestor) seek to enter the into the Brownfield Cleanup Program as a Volunteer.

Under ECL § 27-1405(1)(b) and 6 NYCRR §375-3.2(c)(2), a Volunteer is defined as follows:

"Volunteer" shall mean an applicant other than a participant, including without limitation a person whose liability arises solely as a result of such person's ownership or operation of or involvement with the site subsequent to the disposal or discharge of contaminants, provided however, such person exercises appropriate care with respect to contamination found at the facility by taking reasonable steps to:

- (i) stop any continuing release;
- (ii) prevent any threatened future release; and
- (iii) prevent or limit human, environmental, or natural resource exposure to any previously released contamination.

Prior to acquisition of the Site, Requestor has conducted all appropriate inquiries by completing a Phase I Environmental Site Assessment. Requestor has continued to exercise appropriate care with respect to the contamination through subsequent environmental investigation and by seeking to remediate the Site through the Brownfield Cleanup Program. Further, the Site is currently secured by a chain link fence with locking access gates which Requestor will maintain upon taking ownership of the Site. Accordingly, the Requestor's liability would arise solely as a result of its ownership. Furthermore, the Requestor has no connection with any previous release of hazardous substances on the Site. As such the Requestor is a Volunteer.

ROUX -1- 3605.0001Y108/APF



LOUISE CARROLL
Commissioner
AHMED TIGANI
Deputy Commissioner
PERRIS STRAUGHTER
Assistant Commissioner

Office of Neighborhood Strategies Division of Planning & Predevelopment 100 Gold Street New York, NY 10038

August 17, 2021

Kelly A. Lewandowski, P.E. Site Control Section New York State Department of Environmental Conservation 650 Broadway - 11th Floor Albany, New York 12233

> Re: Proof of Site Access Site A – Block 2272, Lots 49, 51, 52, 53, 108; Block 2269, Lot 52 Borough of Brooklyn

Dear Ms. Lewandowski,

I am writing regarding Unified Neighborhood Partners ("UNP") LLC's application to the Brownfield Cleanup Program ("BCP"). Unified Neighborhood Partners, its affiliate entities (Bartlett Crossing UNP LLC, Bartlett Crossing LLC, and Bartlett Crossing Managers LLC), and its contractors will have access to the above referenced lots also known as Site A in the Broadway Triangle project (the "Development Site") as described in this letter.

The Development Site is currently owned by the City of New York (the "City"). The City, acting by and through its Department of Housing Preservation and Development ("HPD") selected Unified Neighborhood Partners, as part of a competitive Requests for Proposal process to develop the Site, and is working with the team toward a closing of project financing and the commencement of remediation and construction. In accordance with a license agreement between UNP, acting by and through its general contractor, ("Gallagher Bassett Services, Inc."), and the City, HPD will provide Gallagher Bassett Services, Inc. access to the Development Site to complete investigation activities required by the New York State Department of Environmental Conservation under the BCP prior to the City's conveyance of the site and the commencement of remediation and construction.

Please accept this letter to serve as **proof of site access**. If you have any further questions, please feel free to contact the HPD Project Manager, Erin Buchanan at 212-863-7654, or via email at: buchanae@hpd.nyc.gov

Sincerely.

Arielle Goldberg

HPD Director of Land Use and Policy

Brownfield Cleanup Program Application Broadway Triangle Site A APPENDIX G

Contact List Information

ROUX 3605.0001Y108/CVRS

Broadway Triangle Site A
663-667 Flushing Avenue and 29-31 Bartlett Street, Brooklyn, New York 11206
BCP Application – Section IX

i. Local and State Officials

Councilman Stephen T. Levin 33rd Council District 410 Atlantic Avenue Brooklyn, NY 11217 Tel: 718-875-5200

Senator Julia Salazar 18th Senatorial District 212 Evergreen Avenue Brooklyn, NY 11221 718-573-1726 Fax: 418-426-6947

Fax: 718-643-6620

Assemblywoman Maritza Davila 53rd Assembly District 249 Wilson Avenue Brooklyn, NY 107 718-443-1205 Fax: 718-443-1424

Hon. Kirsten E. Gillibrand U.S. Senator 780 Third Avenue, Suite 2601 New York, NY 10017 212-688-6262 Fax: 866-824-6340

Acting District Attorney Eric Gonzalez Kings County District Attorney 350 Jay Street Brooklyn, NY 11201 718-250-2000 Fax: 718-250-3187

Hon. Andrew M. Cuomo Governor of New York State NYS State Capital Building State Street and Washington Avenue Albany, NY 12224

Congresswoman Nydia Velasquez 7th Congressional District 266 Broadway, Suite 201 Brooklyn, NY 11211 718-599-3658 Brooklyn Borough President Eric Adams 209 Joralemon Street Brooklyn, NY 11201 718-802-3700 Fax: 718-802-3920

NYS Comptroller Thomas DiNapoli 59 Maiden Lane-30th Floor New York, NY 10038 212-417-5180 Fax: 212-417-5176

Hon. Mayor Bill de Blasio New York City Hall New York, NY 10007 Phone: 212-718-7585 Fax: 212-406-3587

NYC Comptroller Scott Stringer 1 Centre Street New York, NY 10007 212-669-3916

Public Advocate Jumaane D. Williams Community Affairs 1 Centre Street, 15th Floor New York, NY 10007 212-669-7200 Fax: 212-669-4701

Hon. Charles E. Schumer U.S. Senator 780 Third Avenue, Suite 2301 New York, NY 10017-2110 212-486-4430 Fax: 212-486-7693

ROUX -1- 3605.0001Y108/APG

Broadway Triangle Site A
663-667 Flushing Avenue and 29-31 Bartlett Street, Brooklyn, New York 11206
BCP Application – Section IX

ii. Current Site Owner

Subject Site

Block 2272, Lot 108

NYC HOUSING PRESERVATION AND DEVELOPMENT 100 Gold Street

New York, NY 10038

Subject Site

Block 2272, Lot 53

NYC HOUSING PRESERVATION AND

DEVELOPMENT 100 Gold Street New York, NY 10038

Subject Site

Block 2272, Lot 52

NYC HOUSING PRESERVATION AND

DEVELOPMENT 100 Gold Street

New York, NY 10038

Subject Site

Block 2272, Lot 51

NYC HOUSING PRESERVATION AND

DEVELOPMENT 100 Gold Street

New York, NY 10038

Subject Site

Block 2272, Lot 49

NYC HOUSING PRESERVATION AND

DEVELOPMENT 100 Gold Street

New York, NY 10038

Subject Site

Block 2269, Lot 52

NYC HOUSING PRESERVATION AND

DEVELOPMENT

100 Gold Street

New York, NY 10038

Block 1722. Lot 182

WEISER, YOEL I

652 Flushing Ave.

Brooklyn, NY 1120

iii. Current Owners and Occupants of Adjacent Sites

Adjacent Properties to the North

Block 2269, Lot 2

58 GERRY ST LLC 89 Wallabout Street

Brooklyn, NY 11249

Block 2269, Lot 3

58 GERRY ST LLC

89 Wallabout Street

Brooklyn, NY 11249

Block 1722, Lot 13

YOSEF MOSHE LLC

320 Roebling Street, Suite 534

Brooklyn, NY 11211

Block 1722, Lot 190

LUONG VI

908 McDonald Ave

Brooklyn, NY 11218

Block 1722, Lot 16

668-674 FLUSHING AVE LLC

1418 65 Street

Brooklyn, NY 11219

Block 1722, Lot 14

FLUSHING REALTY LLC 174 Broadway, Suite 205

Brooklyn, NY 11211

100 COTO, LAW Q.

Adjacent Properties to the South

Block 1722, Lot 188 TRUONG, LAM Q.

1625 68th Street,

Brooklyn, NY 11204

Block 1722, Lot 186

ACOSTA, JULIO & INES

656 Flushing Ave.

Brooklyn, NY 11206

Block 1722, Lot 184

MORALES, MIQUEL

654 Flushing Ave.

Brooklyn, NY 11206

Broadway Triangle Site A

663-667 Flushing Avenue and 29-31 Bartlett Street, Brooklyn, New York 11206 BCP Application – Section IX

Block 2272, Lot 3

YBBME LLC 16 Bartlett Street Brooklyn. NY 11206

Adjacent Properties to the West Block 2272, Lot 54

The 661 Flushing Condominium 661 Flushing Avenue Brooklyn, NY 11206

Block 2272, Lot 6

ZBL Bartlett LLC 1418 65th Street Brooklyn, NY 11219

Block 2269, Lot 1

58 GERRY ST LLC 89 Wallabout Street Brooklyn, NY 11249 Adjacent Properties to the East Block 2272, Lot 9

Jose, Julio 620 Eagle Avenue West Hempstead, NY 11552

Block 2272, Lot 45

Whipple Properties LLC 183 Wilson Street, #133 Brooklyn, NY 11211

Block 2269, Lot 51

58 GERRY ST LLC 89 Wallabout Street Brooklyn, NY 11249

iv. Community, Religious, Civic and other Authorities

FDNY Engine 237 43 Morgan Ave Brooklyn, NY 11237

All Saints Catholic Church 115 Throop Ave Brooklyn, NY 11206

The Universal Church 7 Debevoise St Brooklyn, NY 11206

CityLight Church Brooklyn 105 Montrose Ave Brooklyn, NY 11206

New York City Police Department 88th Precinct 298 Classon Ave Brooklyn, NY 11205

Fountain of life church 147 Walton St Brooklyn, NY 11206

Holy Trinity Roman Catholic Church 138 Montrose Ave Brooklyn, NY 11206

Legacy Brooklyn Church 7 Marcus Garvey Blvd Brooklyn, NY 11206 New York City Police Department 88th Precinct 298 Classon Ave Brooklyn, NY 11205

Pentecostal Church of Jesus Christ of Brooklyn (IPJ Brooklyn) 21 Marcus Garvey Blvd Brooklyn, NY 11206

First Mennonite Church 23 Marcus Garvey Blvd Brooklyn, NY 11206

Central Brooklyn Spanish SDA Church 130 Boerum St Brooklyn, NY 11206

Galileo Temple 19 Montrose Ave Brooklyn, NY 11206

Cong. Shaar Hatfiah Ruzle 133 Gerry St Brooklyn, NY 11206

Congregation Tehilas Moshe 215 Middleton St Brooklyn, NY 11206

Broadway Triangle Site A
663-667 Flushing Avenue and 29-31 Bartlett Street, Brooklyn, New York 11206
BCP Application – Section IX

Congregation Sheima Shlomo D'Kozove 198 Middleton St Brooklyn, NY 11206

Cong. Yetev Lev Satmar- Hisachdus Avreichim 52 Bartlett St Brooklyn, NY 11206 Divrei Yoel Satmar 161 Harrison Ave Brooklyn, NY 11206

v. Parks and Recreation

NYC Parks and Recreation Sternberg Park c/o 830 Fifth Avenue New York, NY 10065 NYC Parks and Recreation Bartlett Playground c/o 830 Fifth Avenue New York, NY 10065

vi. Day Cares and School

The Baby Play Place Preschool & Daycare 25 Boerum St STE 7S Brooklyn, NY 11206

Tender Tots ChildCare, Preschool & Programs 810 Flushing Ave Brooklyn, NY 11206

NYCHA's Marcy Day Care Center 494 Marcy Ave Brooklyn, NY 11206

NYCHA's Sumner Day Care Center 880 Park Ave Brooklyn, NY 11206

4 Future Generations WeeCare Administrator: Kenesha Traynham-Cooper 744 Park Ave Brooklyn, NY 11206

Intermediate School 318
Principal: Leander Windley
101 Walton St
Brooklyn, NY 11206

Public School 403 760 Broadway Brooklyn, NY 11206

BWCCS2 MIDDLE SCHOOL Principal: Edwin Santiago 11 Bartlett St Brooklyn, NY 11206

UTA Stamar Girls High School 366 Wallabout St Brooklyn, NY 11206 Public School 380 Principal: Victoria Prisinzano 370 Marcy Ave Brooklyn, NY 11206

Success Academy Myrtle Middle School Principal: Denae Howard 700 Park Ave Brooklyn, NY 11206

Success Academy Bed-Stuy 2 Principal: Alisha Neptune 211 Throop Ave Brooklyn, NY 11206

Public School 148 185 Ellery St Brooklyn, NY 11206

Central Brooklyn Seventh Day Adventist School 130 Boerum St Brooklyn, NY 11206

P.S. 257 John F. Hylan Principal: Idalys Tolentino 60 Cook St Brooklyn, NY 11206

Intermediate School 71 Principal: Howard Fineman 215 Heyward St Brooklyn, NY 11206

Broadway Triangle Site A
663-667 Flushing Avenue and 29-31 Bartlett Street, Brooklyn, New York 11206
BCP Application – Section IX

vii. Local Water Supply

New York City Water Supply 9605 Horace Harding Expressway Queens, NY 11368

viii. Local News and Media

Brooklyn Reporter

16 Court Street, 30th Floor Brooklyn, NY 11241

The Brooklyn Papers
1 Metrotech Center, Suite 1001
Brooklyn, NY 11201
New York Post

1211 Avenue of the Americas New York, NY 10036

New York Daily News

4 New York Plaza New York, NY 10004

Spectrum NY 1 News 75 Ninth Avenue New York, NY 10011 Courier-Life Publications 1 Metrotech Center #10T Brooklyn, NY 11202

Brooklyn Daily Eagle 16 Court Street, Suite 1208 Brooklyn, NY 11241

El Diario 1 MetroTech Center, 18th Floor Brooklyn, NY 11201

Hoy Nueva York
1 MetroTech Center, 18th Floor
Brooklyn, NY 11201

ix. Any Person, Community Based Organization, BOA Group, or Local Media Who Has Requested to be placed on the contact list

No persons have requested to be on the Site Contact List.

x. Document Repository

Brooklyn Public Library- Bushwick Branch 340 Bushwick Avenue Brooklyn, NY 11206 Phone: 718-602-1348

Brooklyn Community Board District 1

Chairperson: Dealice Fuller

District Manager: Gerald A. Esposito

435 Graham Avenue Brooklyn, New York 11211 Phone: (718) 389-0009 Fax: (718) 389-0098 E-Mail: bk01@cb.nyc.gov

*Brooklyn Community Board District 1 has verbally refused to grant permission to be used as a document repository without first reviewing and approving documents to be housed. Brooklyn Community Board District 1 has refused to issue a written statement regarding their refusal or document review and approval policies.

See attached documentation confirming acceptance as document repositories in Appendix G.

ROUX -5- 3605.0001Y108/APG

 From:
 Brooke Hildebrand

 To:
 bk01@cb.nyc.gov

 Cc:
 Brandon Vella

Subject: Permission for Brooklyn Community Board 1 Use as Document Repository

Date: Friday, January 15, 2021 4:53:00 PM

Attachments: <u>image001.png</u>

image002.png image003.png image004.png image005.png

Good afternoon,

Roux Environmental Engineering and Geology, D.P.C. (Roux) on behalf of UNP Site A Developer LLC, UNP Site B Developer LLC, and UNP Site C Developer LLC, requests permission to use Brooklyn Community Board 1 as a document repository for future reports and correspondence associated with the proposed New York State Department of Environmental Conservation (NYSDEC) Brownfield Cleanup Program (BCP) projects located at the following Sites:

- Parcel A: 663-667 Flushing Avenue and 29-31 Bartlett Street, Brooklyn, NY 11206;
- Parcel B: 35-45 Bartlett Street and 68-76 Gerry Street, Brooklyn, NY 11206;
- Parcel C: 59-69 Bartlett Street, 84-100 Throop Avenue, and 90-100 Gerry Street, Brooklyn, NY 11206.

As part of the Site's BCP Application, NYSDEC requires Roux to provide proof of "acknowledgement from the repositories listed that they agree to act as a document repository for the project".

Please reply with confirmation that Brooklyn Community Board 1 permits to its use as a document repository for these BCP Sites.

My contact information is provided below if you have any questions regarding this request. Thank you for your time and attention.

Sincerely,

Brooke Hildebrand | Staff Scientist

209 Shafter Street, Islandia, New York 11749

Main: 631.232.2600 | Direct: 631.630.2373 | Mobile: 631.356.3719 Email: bhildebrand@rouxinc.com | Website: www.rouxinc.com



California | Illinois | Massachusetts | New Jersey | New York | Texas



From: Brooke Hildebrand

To: mbalsan@bklynlibrary.org

Cc: Brandon Vella

Subject: Permission for Bushwick Library Use as Document Repository

Date: Thursday, January 21, 2021 2:37:00 PM

Attachments: <u>image001.png</u>

image002.png image003.png image004.png image005.png

Good afternoon,

Roux Environmental Engineering and Geology, D.P.C. (Roux) on behalf of UNP Site A Developer LLC, UNP Site B Developer LLC, and UNP Site C Developer LLC, requests permission to use Bushwick Library as a document repository for future reports and correspondence associated with the proposed New York State Department of Environmental Conservation (NYSDEC) Brownfield Cleanup Program (BCP) projects located at the following Sites:

- Parcel A: 663-667 Flushing Avenue and 29-31 Bartlett Street, Brooklyn, NY 11206;
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My contact information is provided below if you have any questions regarding this request. Thank you for your time and attention.

Sincerely,

Brooke Hildebrand | Staff Scientist

209 Shafter Street, Islandia, New York 11749

Main: 631.232.2600 | Direct: 631.630.2373 | Mobile: 631.356.3719 Email: bhildebrand@rouxinc.com | Website: www.rouxinc.com





Brandon Vella

From: Brooke Hildebrand

Sent: Saturday, January 30, 2021 2:51 PM

To: Brandon Vella **Subject:** FW: Depository Site

Brooke Hildebrand | Staff Scientist

209 Shafter Street, Islandia, New York 11749

Main: 631.232.2600 | Direct: 631.630.2373 | Mobile: 631.356.3719 Email: bhildebrand@rouxinc.com | Website: www.rouxinc.com



California | Illinois | Massachusetts | New Jersey | New York | Texas



From: Balsan, Michelle <MBalsan@bklynlibrary.org>

Sent: Saturday, January 30, 2021 2:50 PM

To: Brooke Hildebrand bhildebrand@rouxinc.com Cc: Waldron, Marc hklynlibrary.org

Subject: Depository Site

This message originated outside your organization. Please use caution!

Good afternoon Brooke,

You're more than walcome to use this location as a depository site! Just be aware that people looking to view any material left here will not be able to view it inside the building at this time due to Covid protocols at BPL Locations.

Feel free to drop off whatever materials need to be placed here and to reach out if you have any further questions!

Enjoy the rest of the weekend,

Michelle Balsan | Library Information Supervisor, Bushwick Brooklyn Public Library
Tel: 718.602.1348

Tel: 718.602.134 bklynlibrary.org

Brownfield Cleanup Program Application Broadway Triangle Site A APPENDIX H

Land Use Factors

ROUX 3605.0001Y108/CVRS

Appendix H - Land Use Factors

Broadway Triangle Site A 663-667 Flushing Avenue and 29-31 Bartlett Street, Brooklyn, NY 11206 BCP Application - Section X

- **2. Current Use -**The Site was most recently used for commercial and residential purposes; however, operations have ceased. The former structures on Site A1 and Site A2 were demolished by 1980 and sometime after 2007, respectively. Both parcels have since remained vacant.
- **3. Reasonably Anticipated Use Post Remediation –** The development proposal plan includes the development of two non-adjacent parcels, Site A1 and Site A2. Site A1 will be developed as one 100% affordable housing, 9-story residential building consisting of 51 affordable housing units, and a 1,300 square foot facility on the ground floor operating as a nonprofit coffee shop. Site A1 will feature a landscaped rear yard, a laundry room, children's playroom, community room, bike storage, and a rooftop solar array. Site A2 will be developed as 9-story residential building consisting of 28 affordable housing units and will also feature a landscaped rear yard, a laundry room, children's playroom, community room, bike storage, and a rooftop solar array.
- 4. Do current historical and/or recent development patterns support the proposed use?

The contemplated future use as affordable housing units and community facilities supports the current development patterns promoting a revitalized neighborhood and promoting neighborhood needs.

5. Is the proposed use consistent with applicable zoning laws/maps? Briefly explain below or attach additional information and documentation if necessary.

Yes, the proposed mixed-use as affordable housing, community facilities, and commercial space is consistent with the current property zoning. The building will be 9-stories which is also consistent with the allowable development height for the building.

6. Is the proposed use consistent with applicable comprehensive community master plans, local waterfront revitalization plans, or other adopted land use plans?

The NYCHPD Broadway Triangle Redevelopment Plan was released in 2007 and positions this vibrant, multicultural neighborhood in northern Brooklyn as a future nucleus of a revitalized neighborhood in the Broadway Triangle area. NYCHPD aims to: 1. Facilitate the development of affordable housing and foster inclusive communities. 2. Properly serve formerly homeless, senior households, and households in need of supportive services. 3. Relieve the trend towards increased rents in the Broadway Triangle area. 4. Contribute to the economic and social vibrancy of the neighborhood and enhance the current inventory of commercial and community uses within the neighborhood. The proposed redevelopment is consistent with the NYCHPD Redevelopment Plan and furthers its objectives.

ROUX -1- 3605.0001Y108/APH