


Appendix C
Water Management Plan

SAVED: 2/28/12 10:10 AM

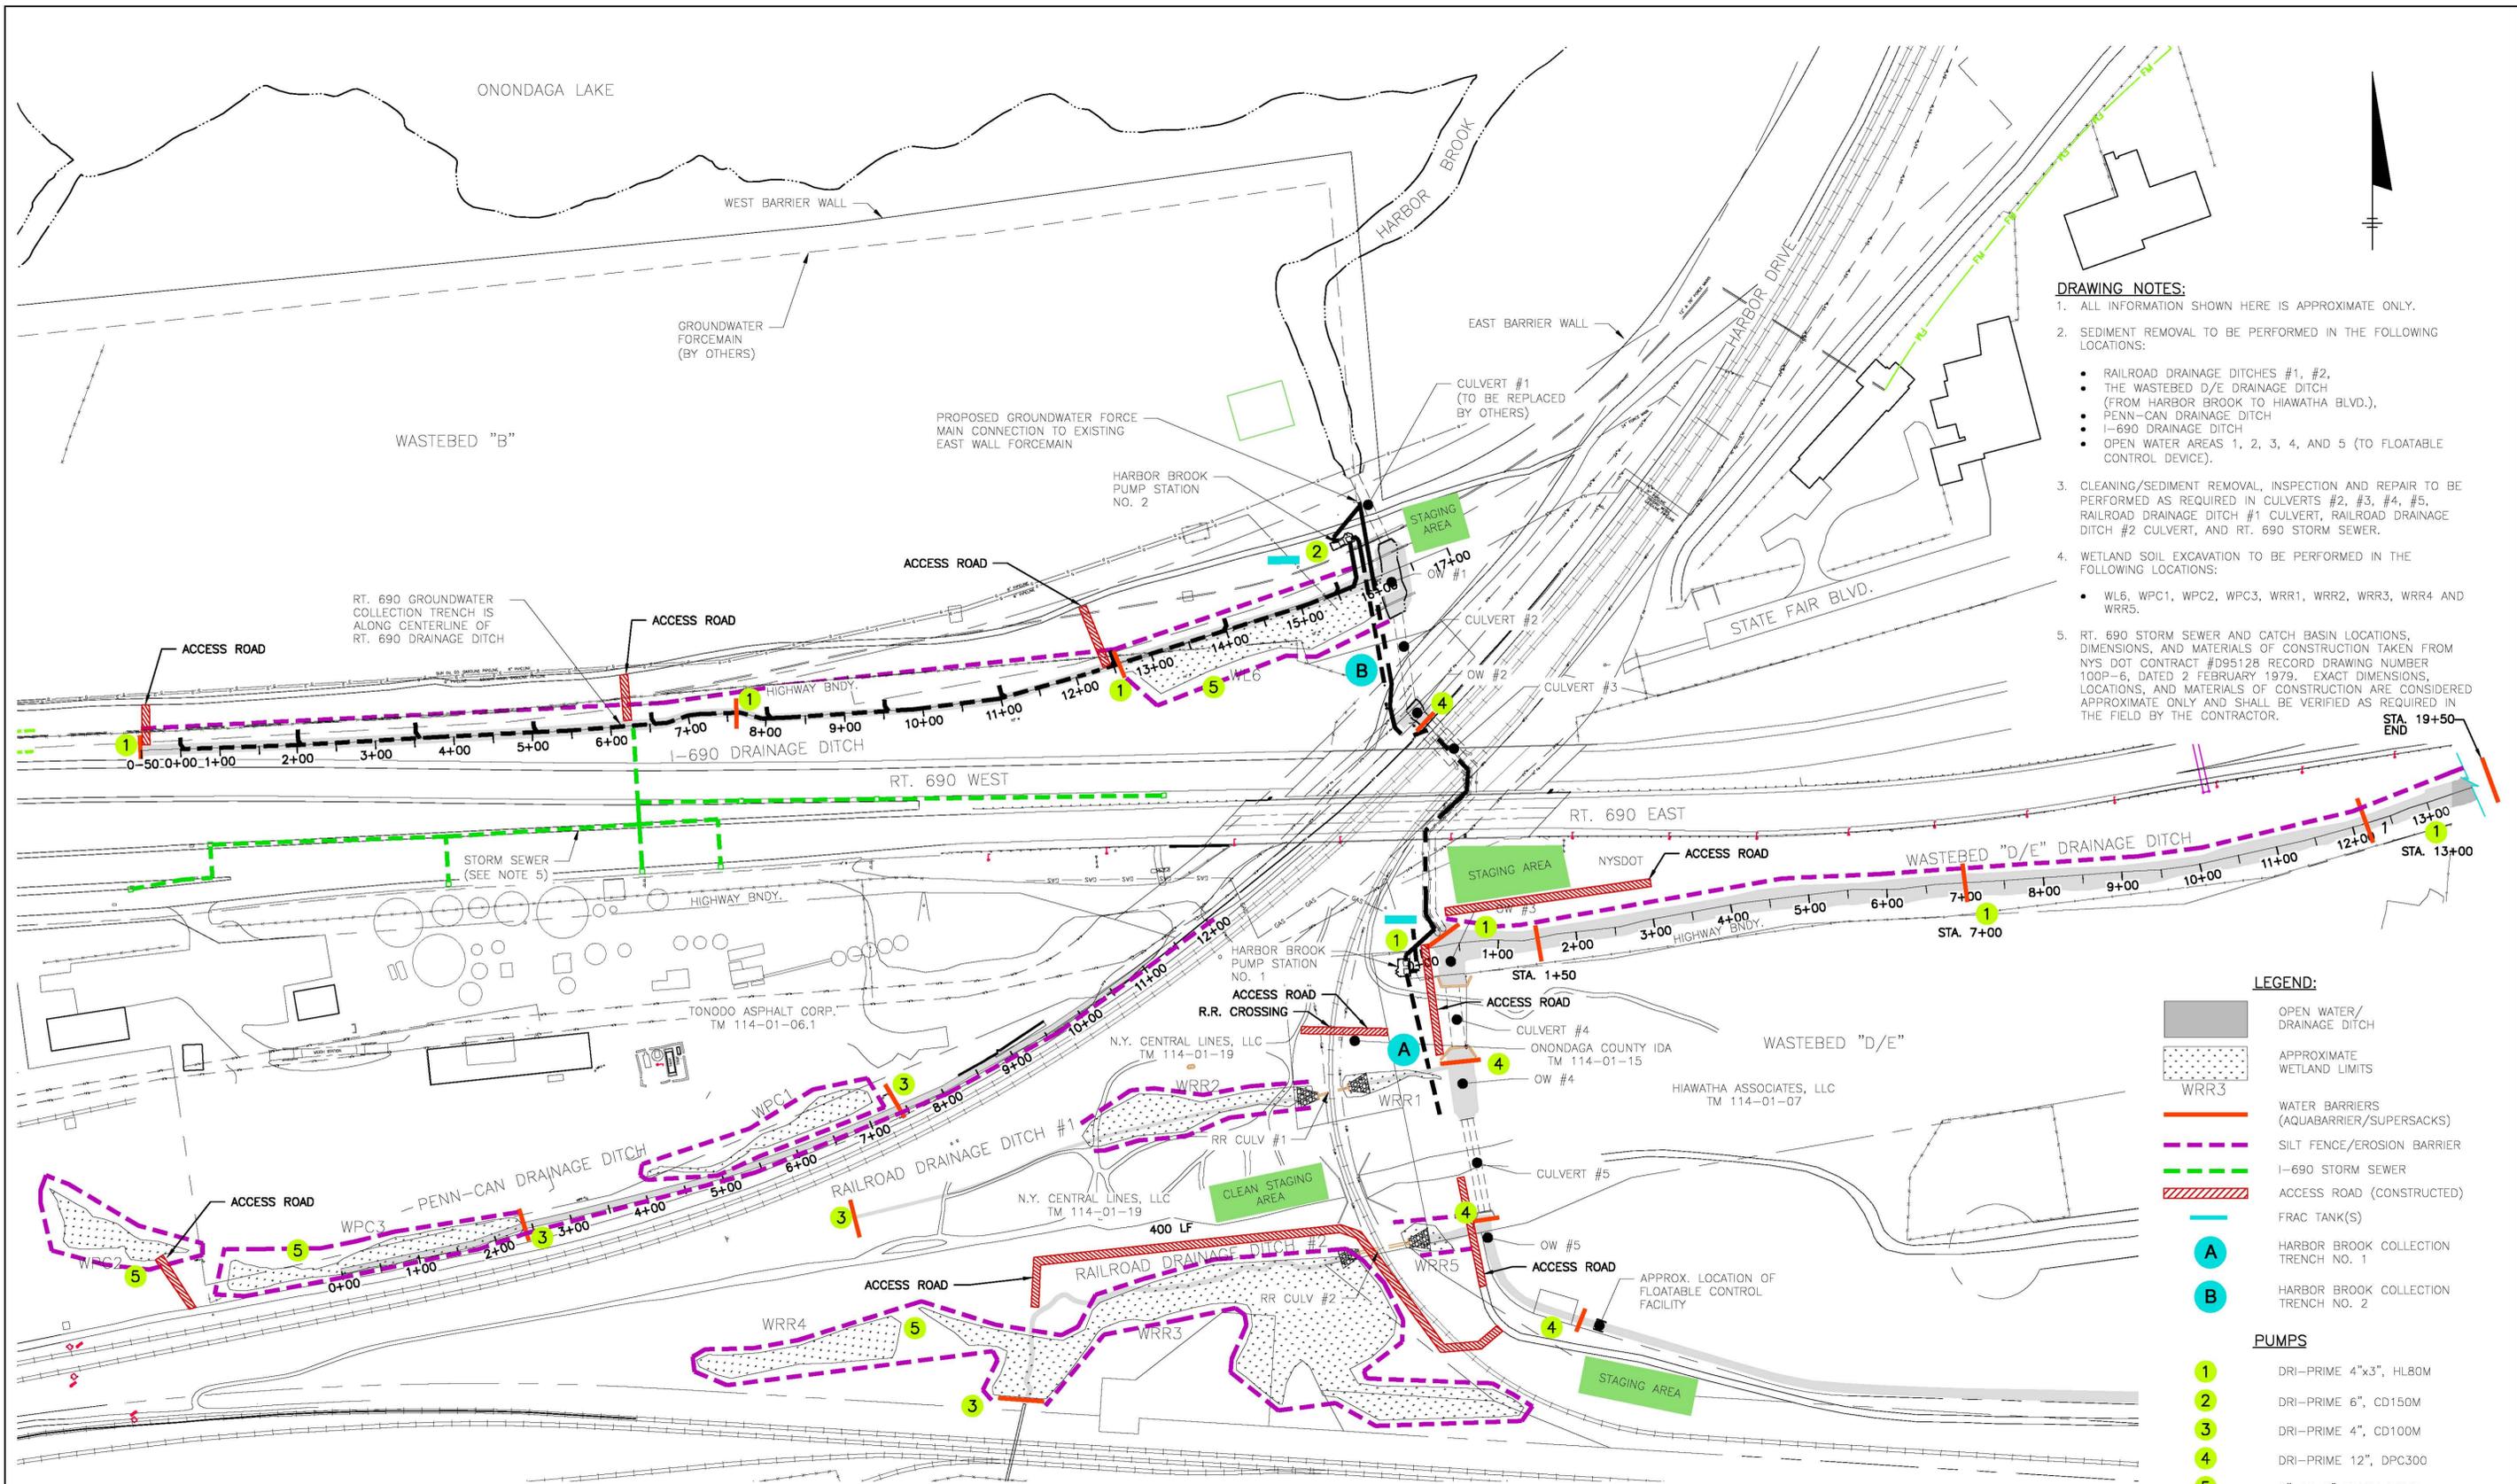

- DRAWING NOTES:**
- ALL INFORMATION SHOWN HERE IS APPROXIMATE ONLY.
 - SEDIMENT REMOVAL TO BE PERFORMED IN THE FOLLOWING LOCATIONS:
 - RAILROAD DRAINAGE DITCHES #1, #2,
 - THE WASTEBED D/E DRAINAGE DITCH (FROM HARBOR BROOK TO HIAWATHA BLVD.),
 - PENN-CAN DRAINAGE DITCH
 - I-690 DRAINAGE DITCH
 - OPEN WATER AREAS 1, 2, 3, 4, AND 5 (TO FLOATABLE CONTROL DEVICE).
 - CLEANING/SEDIMENT REMOVAL, INSPECTION AND REPAIR TO BE PERFORMED AS REQUIRED IN CULVERTS #2, #3, #4, #5, RAILROAD DRAINAGE DITCH #1 CULVERT, RAILROAD DRAINAGE DITCH #2 CULVERT, AND RT. 690 STORM SEWER.
 - WETLAND SOIL EXCAVATION TO BE PERFORMED IN THE FOLLOWING LOCATIONS:
 - WL6, WPC1, WPC2, WPC3, WRR1, WRR2, WRR3, WRR4 AND WRR5.
 - RT. 690 STORM SEWER AND CATCH BASIN LOCATIONS, DIMENSIONS, AND MATERIALS OF CONSTRUCTION TAKEN FROM NYS DOT CONTRACT #D95128 RECORD DRAWING NUMBER 100P-6, DATED 2 FEBRUARY 1979. EXACT DIMENSIONS, LOCATIONS, AND MATERIALS OF CONSTRUCTION ARE CONSIDERED APPROXIMATE ONLY AND SHALL BE VERIFIED AS REQUIRED IN THE FIELD BY THE CONTRACTOR.


- LEGEND:**
- OPEN WATER/ DRAINAGE DITCH
 - APPROXIMATE WETLAND LIMITS
 - WRR3
 - WATER BARRIERS (AQUABARRIER/SUPERSACKS)
 - SILT FENCE/EROSION BARRIER
 - I-690 STORM SEWER
 - ACCESS ROAD (CONSTRUCTED)
 - FRAC TANK(S)
 - A HARBOR BROOK COLLECTION TRENCH NO. 1
 - B HARBOR BROOK COLLECTION TRENCH NO. 2
- PUMPS**
- 1 DRI-PRIME 4"x3", HL80M
 - 2 DRI-PRIME 6", CD150M
 - 3 DRI-PRIME 4", CD100M
 - 4 DRI-PRIME 12", DPC300
 - 5 2" OR 3" TRASH PUMP

IT IS A VIOLATION OF LAW FOR ANY PERSON, UNLESS ACTING UNDER THE DIRECTION OF A LICENSED ENGINEER, TO ALTER THIS DOCUMENT.

THIS DRAWING WAS PREPARED AT THE SCALE INDICATED IN THE TITLE BLOCK. INACCURACIES IN THE STATED SCALE MAY BE INTRODUCED WHEN DRAWINGS ARE REPRODUCED BY ANY MEANS. USE THE GRAPHIC SCALE BAR IN THE TITLE BLOCK TO DETERMINE THE ACTUAL SCALE OF THIS DRAWING.

PLAN
SCALE: 1"=100'

IN CHARGE OF _____
DESIGNED BY _____ CHECKED BY _____
DRAWN BY _____ SED

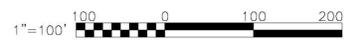

| NO. | DATE | REVISION | INIT. |
|-----|------|----------|-------|
| | | | |



HONEYWELL INTERNATIONAL INC.
WASTEBED B/HARBOR BROOK IRM
TOWN OF GEDDES
SYRACUSE, NEW YORK


GENERAL
**WATER MANAGEMENT PLAN
SITE PLAN**

FILE NO.
1163.42071.107
DATE
FEBRUARY 2012

FIG 1

I:\HONEYWELL\1163\42071\WASTEBED-B-HARB.DWG\SHEETS\42071-107-FIG1.DWG

Appendix D
Traffic/Haul Routes

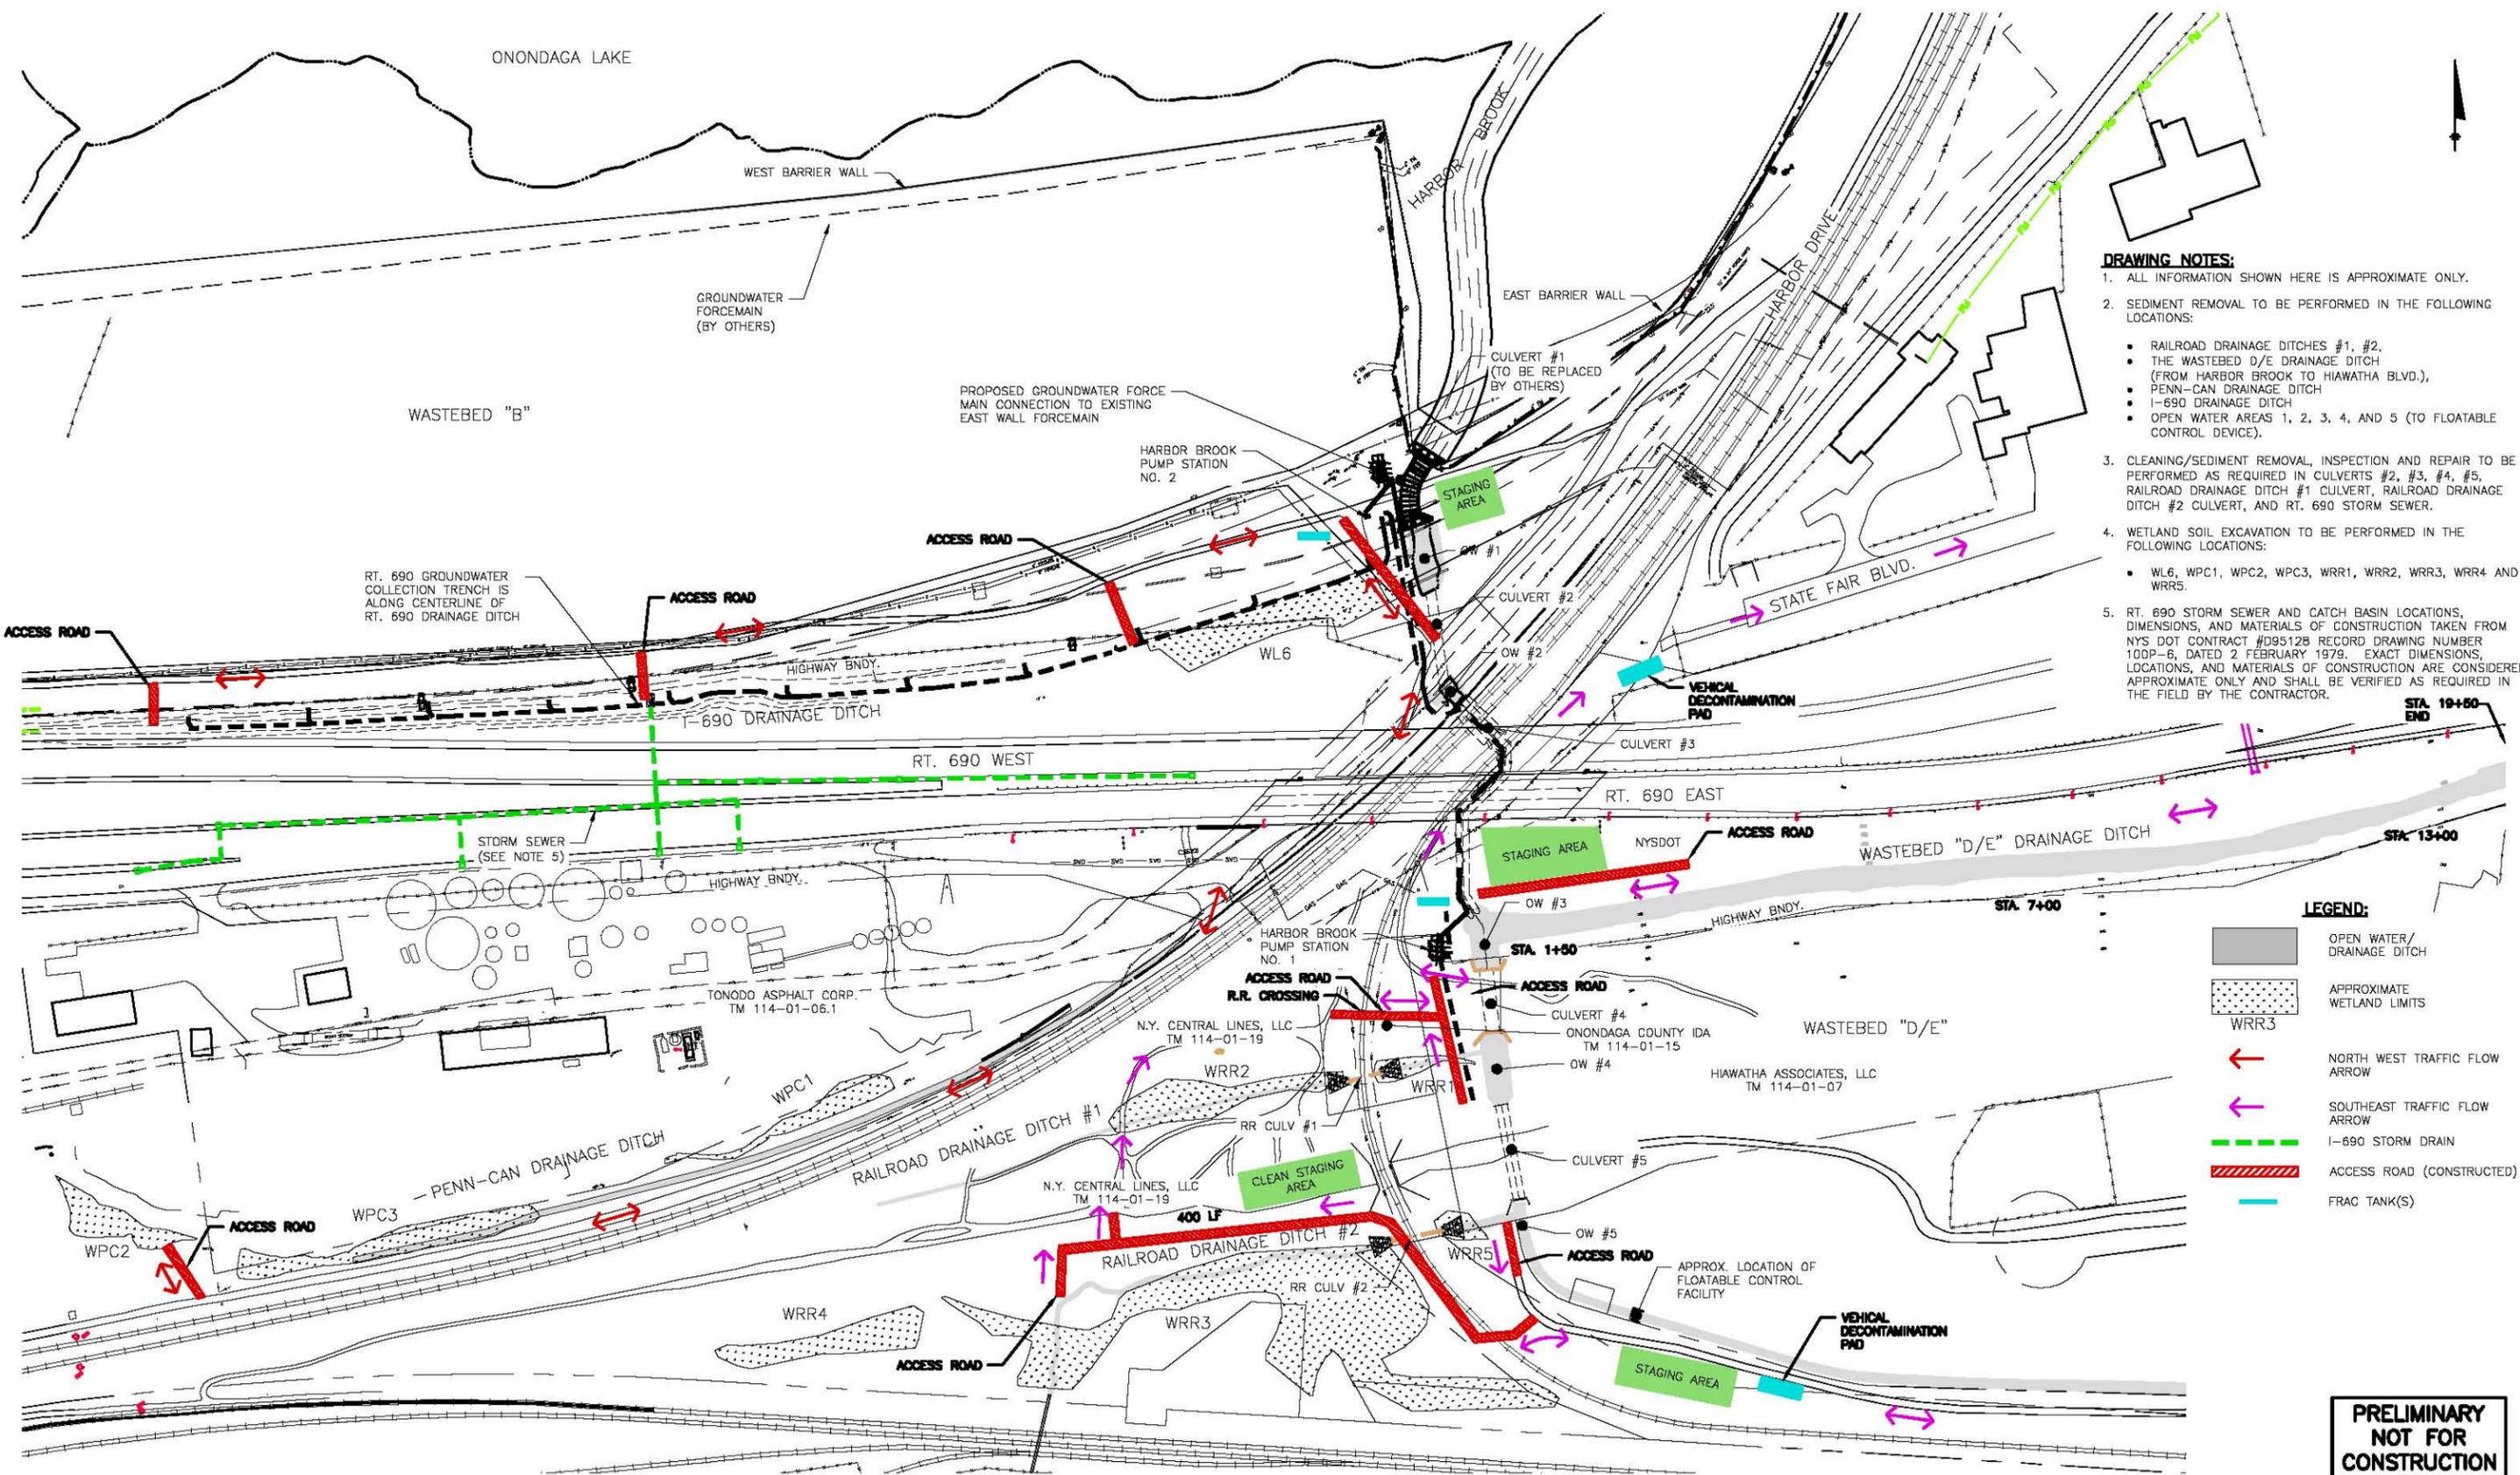

- DRAWING NOTES:**
1. ALL INFORMATION SHOWN HERE IS APPROXIMATE ONLY.
 2. SEDIMENT REMOVAL TO BE PERFORMED IN THE FOLLOWING LOCATIONS:
 - RAILROAD DRAINAGE DITCHES #1, #2,
 - THE WASTE BED D/E DRAINAGE DITCH (FROM HARBOR BROOK TO HIAWATHA BLVD.),
 - PENN-CAN DRAINAGE DITCH
 - I-690 DRAINAGE DITCH
 - OPEN WATER AREAS 1, 2, 3, 4, AND 5 (TO FLOATABLE CONTROL DEVICE).
 3. CLEANING/SEDIMENT REMOVAL, INSPECTION AND REPAIR TO BE PERFORMED AS REQUIRED IN CULVERTS #2, #3, #4, #5, RAILROAD DRAINAGE DITCH #1 CULVERT, RAILROAD DRAINAGE DITCH #2 CULVERT, AND RT. 690 STORM SEWER.
 4. WETLAND SOIL EXCAVATION TO BE PERFORMED IN THE FOLLOWING LOCATIONS:
 - WL6, WPC1, WPC2, WPC3, WRR1, WRR2, WRR3, WRR4 AND WRR5.
 5. RT. 690 STORM SEWER AND CATCH BASIN LOCATIONS, DIMENSIONS, AND MATERIALS OF CONSTRUCTION TAKEN FROM NYS DOT CONTRACT #D95128 RECORD DRAWING NUMBER 100P-6, DATED 2 FEBRUARY 1979. EXACT DIMENSIONS, LOCATIONS, AND MATERIALS OF CONSTRUCTION ARE CONSIDERED APPROXIMATE ONLY AND SHALL BE VERIFIED AS REQUIRED IN THE FIELD BY THE CONTRACTOR.


- LEGEND:**
- OPEN WATER/ DRAINAGE DITCH
 - APPROXIMATE WETLAND LIMITS
 - WRR3
 - NORTH WEST TRAFFIC FLOW ARROW
 - SOUTHEAST TRAFFIC FLOW ARROW
 - I-690 STORM DRAIN
 - ACCESS ROAD (CONSTRUCTED)
 - FRAC TANK(S)

PRELIMINARY NOT FOR CONSTRUCTION
 DATE: 02/13/2012

IT IS A VIOLATION OF LAW FOR ANY PERSON, UNLESS ACTING UNDER THE DIRECTION OF A LICENSED ENGINEER, TO ALTER THIS DOCUMENT.
 THIS DRAWING WAS PREPARED AT THE SCALE INDICATED IN THE TITLE BLOCK. INACCURACIES IN THE STATED SCALE MAY BE INTRODUCED WHEN DRAWINGS ARE REPRODUCED BY ANY MEANS. USE THE GRAPHIC SCALE BAR IN THE TITLE BLOCK TO DETERMINE THE ACTUAL SCALE OF THIS DRAWING.

PLAN
 SCALE: 1"=100'

IN CHARGE OF _____
 DESIGNED BY _____ CHECKED BY _____
 DRAWN BY _____ SED

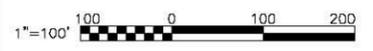

| NO. | DATE | REVISION | INIT. |
|-----|------|----------|-------|
| | | | |
| | | | |



HONEYWELL INTERNATIONAL INC.
WASTE BED B/HARBOR BROOK IRM
TOWN OF GEDDES
SYRACUSE, NEW YORK

GENERAL
STAGING/HAUL ROUTES PLAN

FILE NO.
1163.42071.108
 DATE
FEBRUARY 2012
FIG 1